

NorthLink WA—

Infrastructure Report

Perth-Darwin National Highway (Swan Valley Section)



CLIENT / Main Roads WA DOCUMENT NO / BGE-0104-REP-C-001 REV / B DATE / 05/08/2020 bgeeng.com—

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Appendices



Appendix A Bridge Drawings Appendix B Non-Compliances Appendix C DWER Response

Document Control

Revision	Date	Description	Prepared	Reviewed	Approved
DRAFT	02/07/2020	Draft to MRWA	N. Martin	P. Murphy	
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Prepared by:



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1 SUMMARY

This post-construction Infrastructure Report (Terrestrial Fauna, Hydrological Processes, Inland Waters Environmental Quality, Amenity (Noise)) is submitted to demonstrate that the key design elements of the Perth–Darwin Nation Highway (Swan Valley Section) have been constructed as detailed in the Infrastructure Plan (NLWA-03-EN-RP-0063). Condition 6-5 of Ministerial Statement No.1036 states that a post-construction Infrastructure Report shall be submitted within 6-months following the completion of construction. This report details the design elements listed in condition 6-5.

This document sets out the as-constructed location and design of the key proposal elements. There are some areas of construction that occurred outside the Development Envelope, which are shown in Appendix B. It was expected that design elements would be modified and refined as the design advanced through the detailed design stage.

Table 1 provides a summary of this plan.

Table 1: Infrastructure Report Summary

Item	Details			
Title of proposal	Infrastructure Report Perth–Darwin National Highway (Swan Valley Section)			
Proponent name	Commissioner for Main Roads Western Australia			
Ministerial Statement No.	1036			
Purpose of this plan	The Infrastructure Report is submitted to fulfil the requirements of condition 6-5 to Ministerial Statement No.1036			
Environmental objectives	Minimise direct and indirect impacts to conservation significant terrestrial fauna.			
	Minimise impacts to hydrological regimes of surface water.			
 Minimise impacts to the quality of groundwater and surface 				
	 Minimise impacts to amenity as low as reasonably practicable. 			



2 CONTEXT AND SCOPE

2.1 Description of the Project

Main Roads Western Australia (MRWA) has constructed a new 38 km long section of the Perth–Darwin National Highway (PDNH) between Malaga and Muchea, in Western Australia (Figure 1). The project consists of a dual carriageway highway and connects the intersection of Tonkin Highway and Reid Highway in the south with Great Northern Highway and Brand Highway in the north.

2.2 Requirements of the Condition

This report is submitted to demonstrate compliance with Ministerial Statement No. 1036, condition 6-5. As required under condition 5-1, this plan will be made publicly available for the life of the proposal. The requirements of this condition and where they are addressed in this report are described in Table 2.

Condition No.	Condition	Section of This Report
5-1	Subject to condition 5-2, within a reasonable time period approved by the CEO of the issue of this Statement and for the remainder of the life of the proposal the proponent shall make publicly available, in a manner approved by the CEO, all environmental plans and reports required under this statement.	Section 2.2
6-5	The proponent shall prepare and submit a post-construction Infrastructure Report to confirm they the key elements of the proposal as referred to in Columns 1 and 2 of Table 2 in Schedule 1 were constructed in accordance with the requirements of condition 6-2, within six (6) months following the completion of construction, or as otherwise agreed in writing by the CEO. The post-construction Infrastructure Report shall include:	This plan; Sections 3.1 to 3.6
	 The alignment, dimensions and locations of the key proposal elements as referred to in Columns 1 and 2 of Table 2 in Schedule 1; 	
	 The dimensions and locations of fauna underpasses and fauna fencing as referred to in Columns 1 and 2 of Table 2 in Schedule 1. Fauna underpass dimensions and locations should be consistent with the approved Fauna – Construction – Condition Environmental Management Plan as required by condition 12; 	
	3. The design and locations of culverts and bridges as referred to in Columns 1 and 2 of Table 2 in Schedule 1;	
	 The design and location of bioretention swales and infiltration basins in the vicinity of Ellen Brook and within the GUWPCA, consistent with the approved Inland Waters Environmental Quality – Hydrological Processes Condition Environmental Management Plan as required by condition 13; 	
	5. The dimensions and locations of noise walls as referred to	


Table 2: Summary of Conditions



Condition No.	Condition	Section of This Report
	in Columns 1 and 2 of Table 2 in Schedule 1, consistent with the approved Amenity (Noise) – Condition Environmental Management Plan; and	
	 Spatial data for the proposal elements as detailed in 6-5(1), 6-5(2), 6-5(3), 6-5(4) and 6-5(5). 	



Northlink Infrastructure Report - Figure 1 - Proposal Overview - AsCon

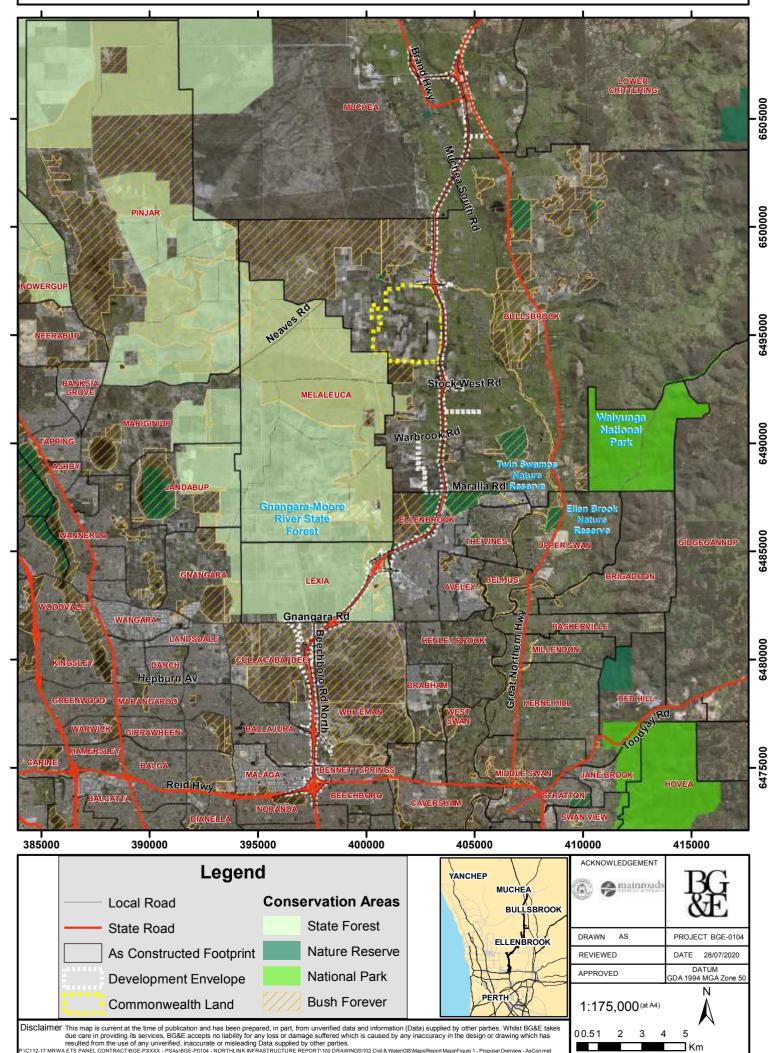

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3 KEY CONSTRUCTION DESIGN ELEMENTS

The location and authorised extent of the key proposal elements provided in Attachment 2 to Schedule 1 of Ministerial Statement No. 1036 are detailed in Table 3. These construction elements are referred to in Condition 6.5 (1) of Ministerial Statement No. 1036.

	Column 2 –		Column 4 – Cleared Areas
Column 1 – Element	Location	Column 3 – Authorised Extent	
Clearing and disturbance for road corridor, drainage structures including infiltration and bioretention basins and swales, laydowns, bridges and culverts, fauna fencing, fauna underpasses, noise walls, road train assembly area and principal shared path.	Located within the development envelope as shown in Figure 1 (of the Ministerial Statement).	 Clearing and disturbance of no more than 765.07 ha consisting of up to 206 ha of native vegetation. This includes up to: 129.9 ha of Bush Forever areas. 0.4 ha of Class A Nature Reserve 46920. 0.2 ha of Class A Nature Reserve 46919. 32.6 ha of Gnangara–Moore River State Forest No. 65. 4 ha Floristic Community Type SCP 20a Threatened Ecological Community. 31.9 ha of Caladenia huegelii critical habitat. 2 ha of Grevillea curviloba subsp. incurva critical habitat. 16 ha of Conservation Category Wetlands, Within a 985 ha development envelope. 	 Cleared areas have been recorded as follows: 92.5 ha of Bush Forever areas. 0.07 ha of Class A Nature Reserve 46920. 0.2 ha of Class A Nature Reserve 46919. 27.6 ha of Gnangara-Moore River State Forest No. 65. 3.9 ha Floristic Community Type SCP 20a Threatened Ecological Community. 29.8 ha of Caladenia huegelii critical habitat. 1.6 ha of Grevillea curviloba subsp. incurva critical habitat. 13.3 ha of Conservation Category Wetlands, within a 1004.07 ha development envelope.
Noise walls	Located within the development envelope as shown in Figure 1 [of the Ministerial Statement].	Height of Noise walls to be no more than 5m on residential boundaries between Reid Highway and south of Maralla Road.	Compliant

Table 3: Location and extent of physical and operational elements

Source: Ministerial Statement No. 1036, Attachment 2



3.1 Road Corridor, Principal Shared Path and Road Train Assembly Area


The road corridor, principal shared path (PSP) and road train assembly area have been constructed within the Development Envelope as shown in Figure 1, with the exception of four areas. Details of these areas and acknowledgement from Department of Water and Environmental Regulation (DWER) can be found in Appendix B and C respectively.

The road corridor, PSP and road train assembly area are depicted in Figure 2.


The remainder of this chapter details key elements consistent with the environmental objectives stated in condition 6-1 of the Ministerial Statement.



Northlink Infrastructure Report - Figure 2 - Location of Road Corridor, principal shared path and road train assembly area - AsCon Map 1 of 4

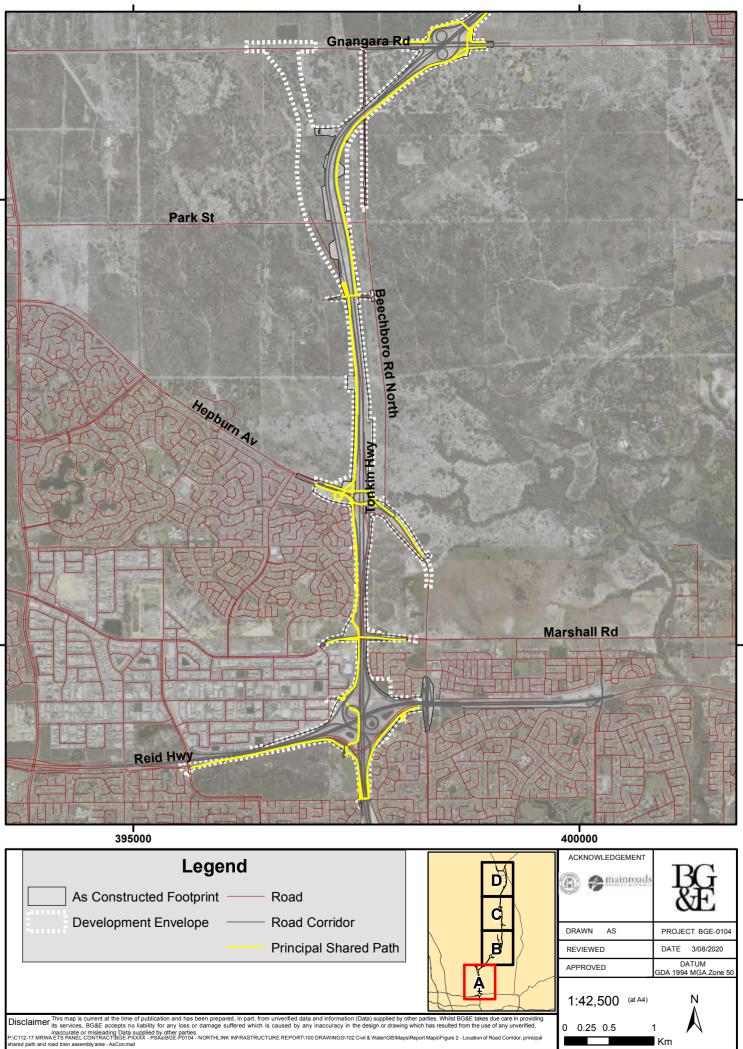

Northlink Infrastructure Report - Figure 2 - Location of Road Corridor, principal shared path and road train assembly area - AsCon Map 2 of 4

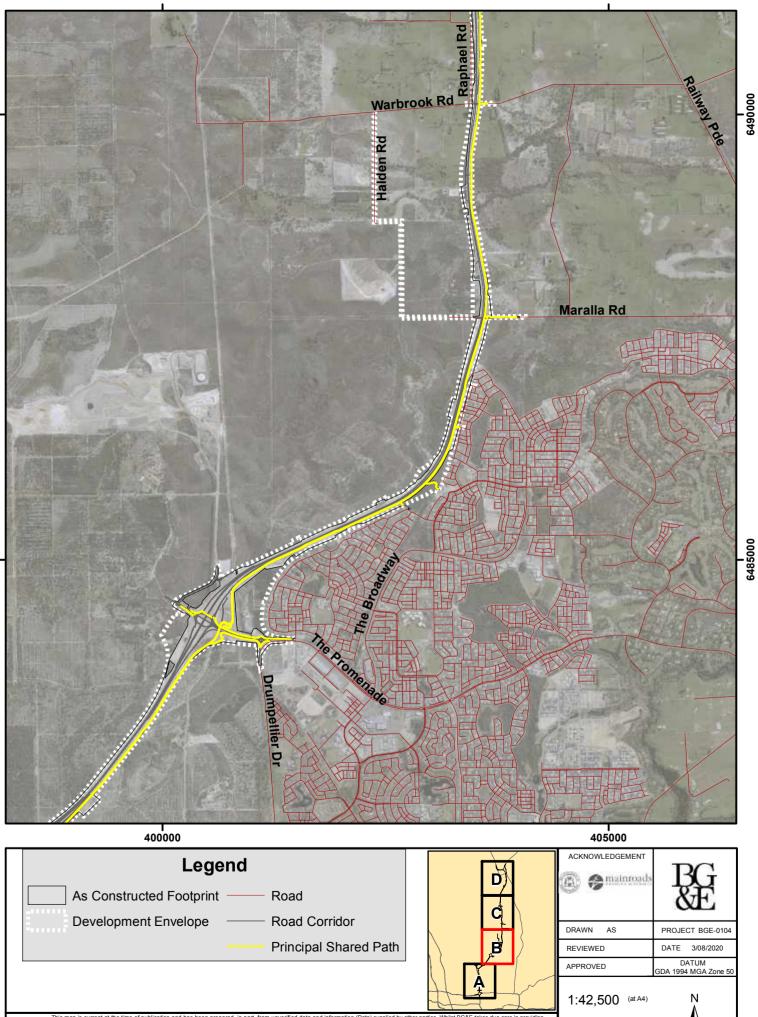


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Northlink Infrastructure Report - Figure 2 - Location of Road Corridor, principal shared path and road train assembly area - AsCon Map 3 of 4



Principal Shared Path

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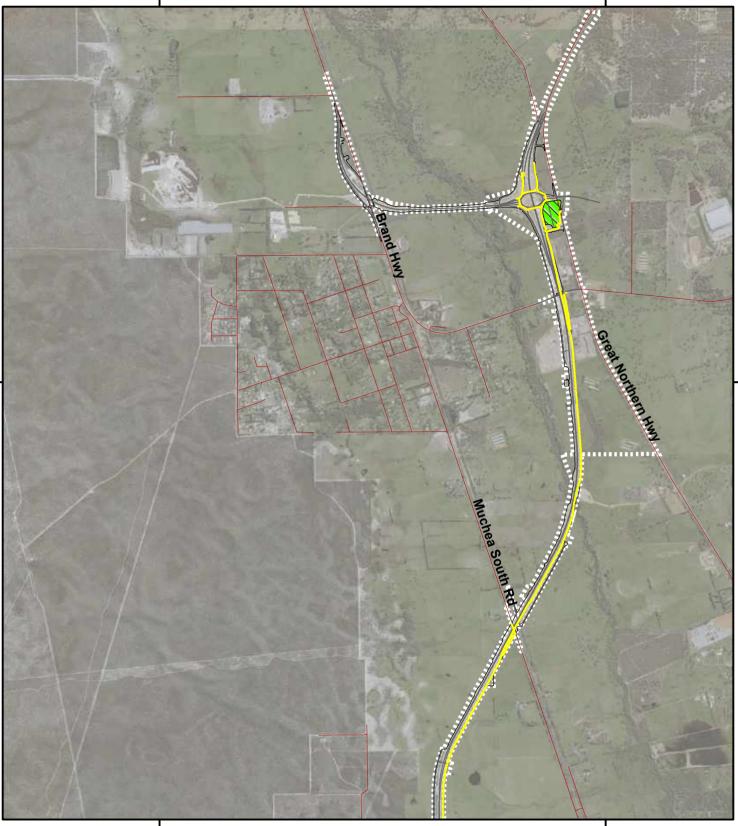
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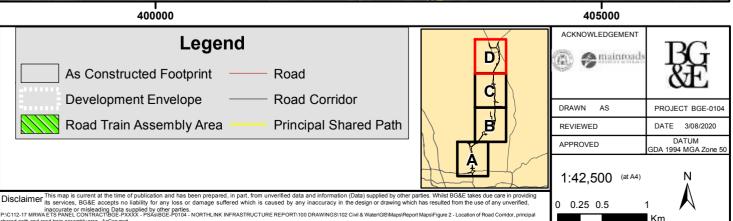
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Northlink Infrastructure Report - Figure 2 - Location of Road Corridor, principal shared path and road train assembly area - AsCon Map 4 of 4

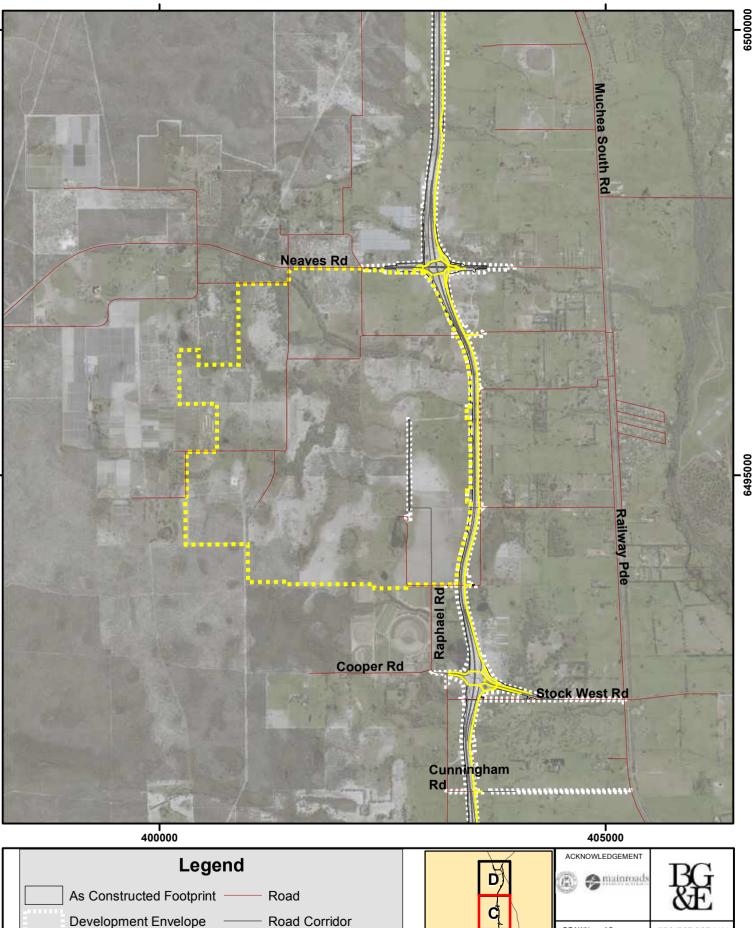



\GIS\Maps\Report Maps\Figure 2 - Location of Road Corridor, princip

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3.2 Laydown Areas

All laydown areas were established within the permanent footprint of the works. No temporary laydown areas involving the clearing of native vegetation were constructed. No laydown areas were constructed within the wellhead protection zones in the Gnangara Underground Water Pollution Control Area (GUWPCA).

3.3 Fauna Underpasses, Bridges and Fencing

Habitat (and fauna population) fragmentation has been managed through the installation of fauna underpasses and a fauna bridge. Dual use culverts have also been installed which allow for both cross-highway drainage as well as fauna movement under the highway. The as constructed bridge, underpass design, culvert design and locations are summarised in Table 4 and depicted in Figure 3. Dimensions given in Table 4 refer to the internal space available to fauna within the fauna underpass or bridge structure.

The as constructed fauna fence locations are depicted in Figure 3. All fauna fencing is 1,800 mm high and is returned from the boundary over the fauna underpasses to ensure continuous fence line. All fauna fencing has been supplied and installed in accordance with Australian Standard AS1725.

Table 5 summarises the as constructed designs against the proposed design in the Fauna – Construction – Condition Environmental Management Plan and the Infrastructure Plan – Perth – Darwin National Highway (Swan Valley Section), as required by condition 12 of the Ministerial Statement.

<u>Note</u>: The proposed fauna underpass locations are consistent in both the Infrastructure Plan and the Condition Environmental Management Plan (Fauna – Construction), hence the comparisons described in the below apply to both the Infrastructure Plan and the CEMP Fauna – Construction plan.

In general, the locations of design items as shown in figure 3 match the locations shown in the both the Fauna EMP and the PDNH Infrastructure Plan with the exception of:

- Ascon label 87 is a new dual use culvert;
- Ascon label 19.65 is a new dual use culvert;
- Whiteman Park 2 and 3 as labelled in the Fauna EMP and Infrastructure Plan are no longer required as the projects extents have changed since these documents were issued and;
- Table 5 shows there are changes in the lengths of culverts and bridges as a result of the design progression and refinement through the detailed design stage.



Ascon label	Location	Design	Internal dimensions ¹ (height x width)	Length (opening to opening) m	Comments
DU1	Hepburn Avenue	Dual Use Culvert	1200x1200mm	194	Under the Alignment
DU2	Cullacabardee Bushland	Dual Use Culvert	1200x900mm	7	Under the Alignment
DU2.3	Cullacabardee Bushland	Dual Use Culvert	1200x900mm	22	Under the Alignment
DU2.5	Cullacabardee Bushland	Dual Use Culvert	1200x900mm	22	Under the Alignment
FU1	Cullacabardee Bushland	Fauna Underpass	1200x1200mm	39	Under the Alignment
FU1.3	Cullacabardee Bushland	Fauna Underpass	1200x1200mm	22	Under the Alignment
FU2	Cullacabardee Bushland	Fauna Underpass	1200x1200mm	40	Under the Alignment
FU2.3	Cullacabardee Bushland	Fauna Underpass	1200x900mm	24	Under the Alignment
FU3	Cullacabardee Bushland	Fauna Underpass	1200x1200mm	28	Under the Alignment
FU3.3	Cullacabardee Bushland	Fauna Underpass	1200x1200mm	40	Under the Alignment
47	Whiteman Park	Box culvert	1200x1200mm	77	Under the Alignment
50	Ellenbrook	Dual Use Culvert	1200x600mm	83	Under the Alignment
87	Ellenbrook	Dual Use Culvert	600x600mm	17	Under the Alignment
30	Ellenbrook	Dual Use Culvert	1200x600mm	74	Under the Alignment
1815	Maralla Road Bushland	Fauna Bridge	12m x 48m	48	Bridge over alignment, 10m vegetated surface for fauna use only
CT20.64	Bullsbrook	Dual Use Culvert	1200x375mm	53	Under the Alignment
CT19.65	Bullsbrook	Dual Use Culvert	2400x600mm	44	Under the Alignment
CT10.90	Bullsbrook	Dual Use Culvert	450mm RCP	137	Under the Alignment
CT10.70	Bullsbrook	Dual Use Culvert	1200x450mm	94	Under the Alignment
CT09.52	Bullsbrook	Dual Use Culvert	1800x600mm	40	Under the Alignment
CD01.86	Bullsbrook	Dual Use Culvert	1200x450mm	15	Under the Alignment
1796	Muchea	Bridge	32m x 62m	62	Bridge over Ellen Brook, design allows fauna movement underneath during periods of low or no flow
CT01.41	Muchea	Dual Use Culvert	2400x60mm & 1200x600mm	102	Under the Alignment
1798	Muchea	Bridge	30m x 45m	45	Bridge over Ellen Brook, design allows fauna movement underneath during periods of low or no flow

Table 4: Summary of as-constructed Fauna Underpass and Bridge Design and Locations

Notes: 1. Internal dimensions indicate headroom for enclosed spaces (e.g. fauna underpasses and dual use culverts) or available width for nonenclosed structures (e.g. bridges).



Ascon Label	Design	Internal dimensions ¹ (height x width)	Length (opening to opening) m	Infrastructure Plan/Fauna CEMP Label	Design	Internal dimensions ¹ (height x width)	Length (opening to opening) m
DU1	Dual Use Culvert	1200x1200mm	194	Hepburn Avenue	Dual use culvert	300 × 300mm	Sections of 80m, 20m, 15m
DU2	Dual Use Culvert	1200x900mm	7	Cullacabardee Bushland 2	Dual use culvert	300 × 300mm	90
DU2.3	Dual Use Culvert	1200x900mm	22	Cullacabardee Bushland 2		abardee Bushland n of DU2, DU2.3 a	
DU2.5	Dual Use Culvert	1200x900mm	22	Cullacabardee Bushland 2			
FU1	Fauna Underpass	1200x1200mm	39	Cullacabardee Bushland 1	Box culvert	1200x1200mm	82
FU1.3	Fauna Underpass	1200x1200mm	22	Cullacabardee Bushland 1	Note: Cullacabardee Bushland 1 is a combination of FU1 and FU1.3		
FU2	Fauna Underpass	1200x1200mm	40	Cullacabardee Bushland 3	Box culvert	1200x1200mm	80
FU2.3	Fauna Underpass	1200x900mm	24	Cullacabardee Bushland 3		abardee Bushland n of FU2 and FU2.	
FU3	Fauna Underpass	1200x1200mm	28	Cullacabardee Bushland 4	Box culvert	1200x1200mm	Sections of 65m, 50m
FU3.3	Fauna Underpass	1200x1200mm	40	Cullacabardee Bushland 4		abardee Bushland n of FU3 and FU3.	
47	Box culvert	1200x1200mm	77	Whiteman Park 1	Box culvert	1200x1200mm	60
50	Dual Use Culvert	1200x600mm	83	Ellenbrook 1	Dual use culvert	300 × 300mm	65
87	Dual Use Culvert	600x600mm	17	NEW PIECE OF INFRA	ASTRUCTURE		
30	Dual Use Culvert	1200x600mm	74	Ellenbrook 2	Dual use culvert	300 × 300mm	65
1815	Fauna Bridge	12mx48m	48	Maralla Road Bushland	Fauna Bridge	Minimum 12m wide (10m wide fauna access)	50
CT20.64	Dual Use Culvert	1200x375mm	53	Bullsbrook 1	Dual use culvert	300 × 300mm	Sections of 70m, 44m
CT19.65	Dual Use Culvert	2400x600mm	44	NEW PIECE OF INFRASTRUCTURE			
CT10.90	Dual Use Culvert	450mm RCP	137	Bullsbrook 2	Dual use culvert	300 × 300mm	Sections of 85m, 50m

Table 5 Summary of as-constructed Fauna Underpass and Bridge Design against Infrastructure Plan / Fauna CEMP




Ascon Label	Design	Internal dimensions ¹ (height x width)	Length (opening to opening) m	Infrastructure Plan/Fauna CEMP Label	Design	Internal dimensions ¹ (height x width)	Length (opening to opening) m
CT10.70	Dual Use Culvert	1200x450mm	94	Bullsbrook 3	Dual use culvert	300 × 300mm	76
CT09.52	Dual Use Culvert	1800x600mm	40	Bullsbrook 4	Dual use culvert	300 × 300mm	Sections of 44m, 12m
CD01.86	Dual Use Culvert	1200x450mm	15	Bullsbrook 4	Note: Bullsbrook 4 is a combination of CT09.52 and CD01.86		
1796	Bridge	32mx62m	62	Bullsbrook/Muchea	Bridge	Unknown	78
CT01.41	Dual Use Culvert	2400x60mm & 1200x600mm	102	Muchea 1	Dual use culvert	300 × 300mm	86
1798	Bridge	30mx45m	45	Muchea 2	Bridge	Unknown	33
PROJECT EXTENT CHANGED - NO LONGER REQUIRED			Whiteman Park 2		·		
PROJECT EXTENT CHANGED - NO LONGER REQUIRED			Whiteman Park 3				

Notes:

1. Internal dimensions indicate headroom for enclosed spaces (e.g. fauna underpasses and dual use culverts) or available width for non-enclosed structures (e.g. bridges).



Northlink Infrastructure Report - Figure 3 - Location of fauna underpasses, bridges and fencing - AsCon Map 1 of 4

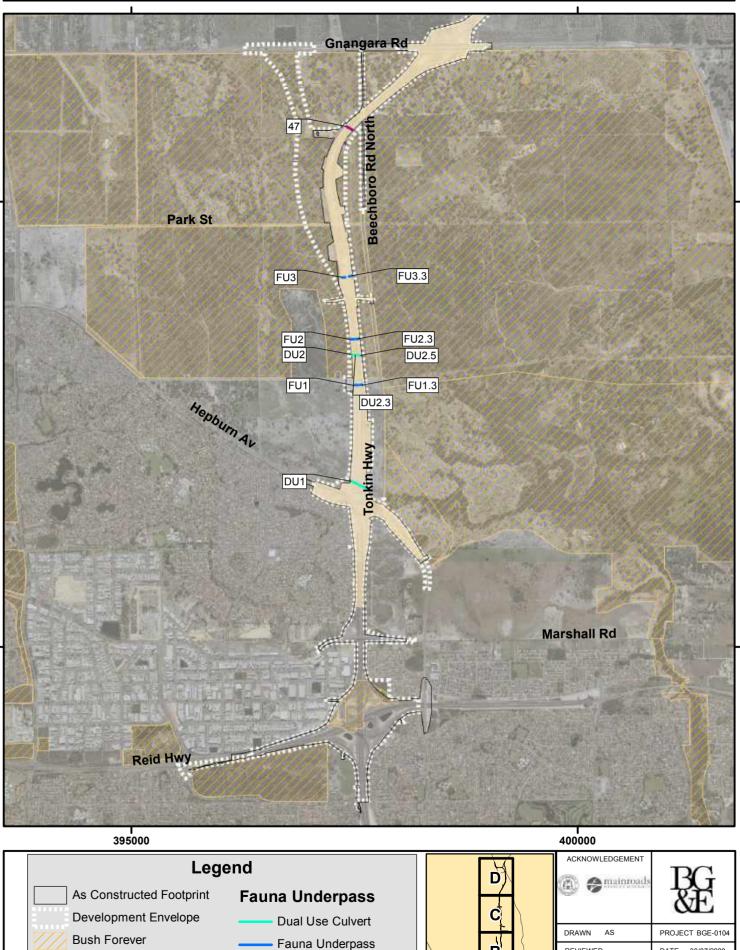

Box culvert, 1200x1200

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Sections including fauna

fencing (1,800mm high)

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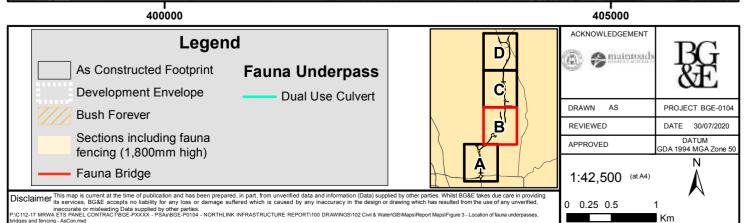
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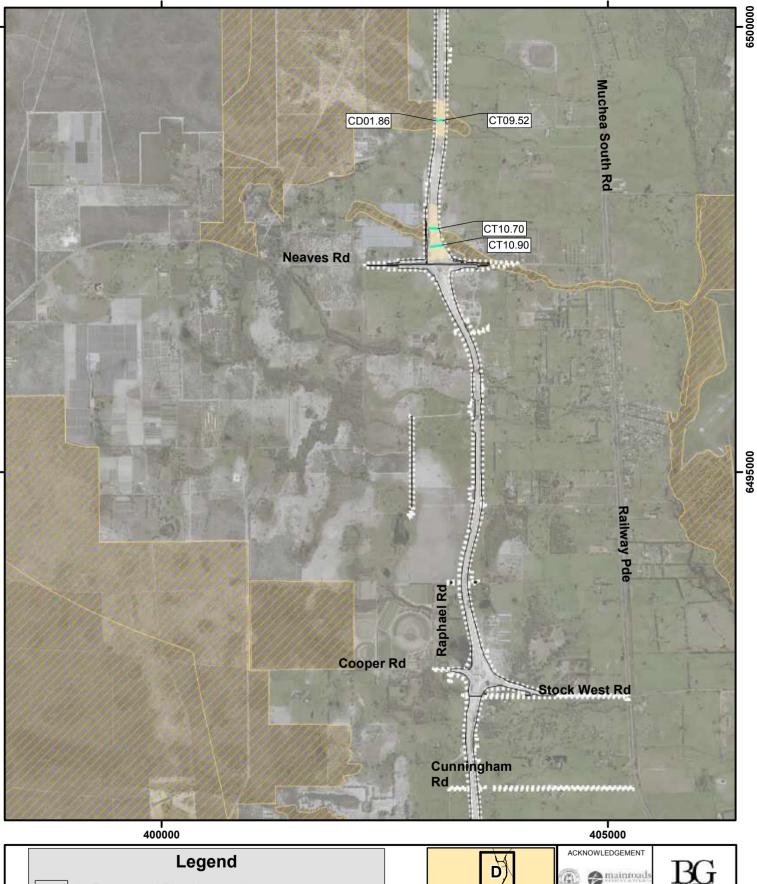
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Northlink Infrastructure Report - Figure 3 - Location of fauna underpasses, bridges and fencing - AsCon Map 2 of 4







Northlink Infrastructure Report - Figure 3 - Location of fauna underpasses, bridges and fencing - AsCon Map 3 of 4



As Constructed Footprint **Fauna Underpass** Development Envelope Dual Use Culvert DRAWN AS PROJECT BGE-0104 **Bush Forever** DATE 30/07/2020 REVIEWED Sections including fauna DATUM APPROVED DA 1994 MGA Zone 50 fencing (1,800mm high) N 1:42,500 (at A4) Disclaimer This map is current at the time of publication and has been prepared, in part, from unverified data and information (Data) supplied by other parties. Whilst BG&E takes due care in providing its services, BG&E accepts no liability for any loss or damage suffered which is caused by any inaccuracy in the design or drawing which has resulted from the use of any unverified, 0 0.25 0.5 1 eading Data supplied by other parties. TRACT/BGE-PXXXX - PSAs/BGE-P0104 - NORTHLINK INFRASTRUCTURE REPORT/100 DRAWINGS/102 Civil & Water/GIS/Maps/Report Maps/Figure 3 - Location of fauna underpa C112-17 | Km

Northlink Infrastructure Report - Figure 3 - Location of fauna underpasses, bridges and fencing - AsCon Map 4 of 4

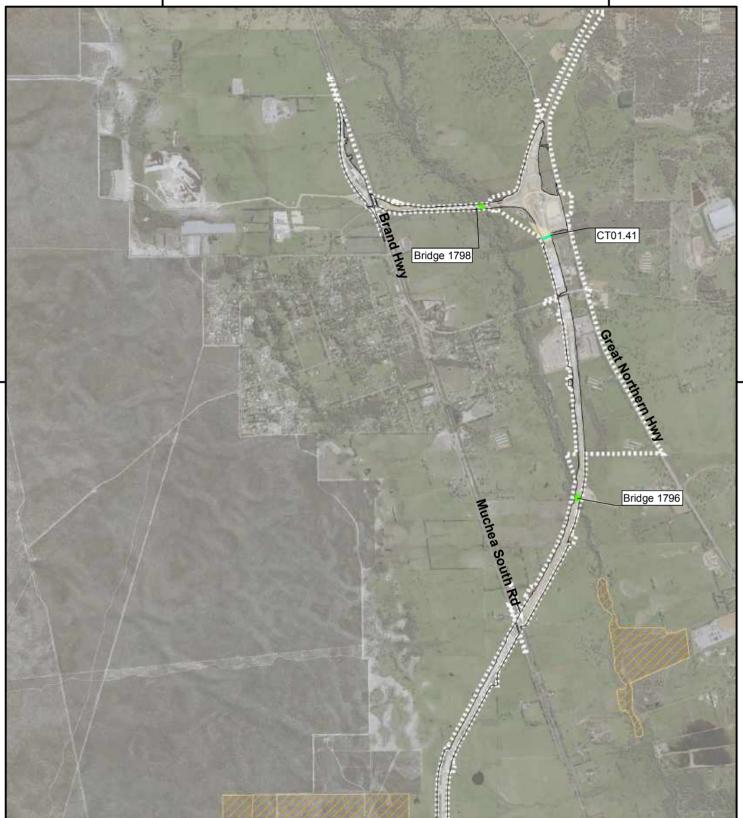

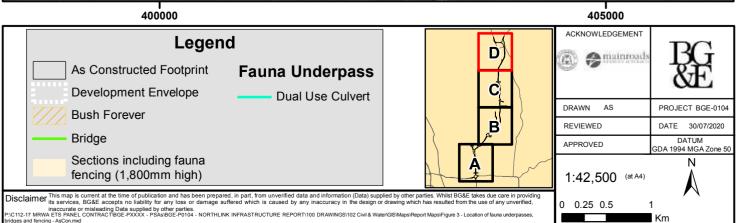

3.4 Culverts and Bridges

Culverts and bridges have been installed along the alignment in order to minimise impacts to hydrological regimes of surface water from the proposal.

The as constructed culvert design and locations are summarised in Table 6 and depicted in Figure 4. Most culverts are a box culvert design, and some provide for dual use; i.e. cross-highway drainage as well as the movement of fauna under the highway. Figure 4 demonstrates that all culverts and bridges have been constructed within the Development Envelope.

Culvert No.	Location	Туре	Length (m)
E1.13	Marshall Road	Culvert	18
A049	Marshall Road	Culvert	345
68	Marshall Road	Culvert	83
DU1	Hepburn Ave	Dual use drainage/ fauna culvert	194
FU1	Cullacarbardee Bushland	Dual use drainage/ fauna culvert	39
FU1.3	Cullacarbardee Bushland	Dual use drainage/ fauna culvert	22
DU2.5	Cullacarbardee Bushland	Dual use drainage/ fauna culvert	22
DU2.3	Cullacarbardee Bushland	Dual use drainage/ fauna culvert	22
DU2	Cullacarbardee Bushland	Dual use drainage/ fauna culvert	7
FU2	Cullacarbardee Bushland	Dual use drainage/ fauna culvert	40
FU2.3	Cullacarbardee Bushland	Dual use drainage/ fauna culvert	24
FU3	Cullacarbardee Bushland	Dual use drainage/ fauna culvert	28
FU3.3	Cullacarbardee Bushland	Dual use drainage/ fauna culvert	40
32	Cullacarbardee Bushland	Culvert	65
30	Cullacarbardee Bushland	Dual use drainage/ fauna culvert	12
33	Whiteman Park	Culvert	17
34	Whiteman Park	Culvert	35
35	Whiteman Park	Culvert	45
47	Whiteman Park	Dual use drainage/ fauna culvert	77
29	Lexia	Culvert	78
27	Lexia	Culvert	51
87	Ellenbrook	Dual use drainage/ fauna culvert	18
50	Ellenbrook	Dual use drainage/ fauna culvert	83
30	Ellenbrook	Culvert	74
CT20.64	North of Maralla Road, Bullsbrook	Dual use drainage/ fauna culvert	53
CT20.65	North of Maralla Road, Bullsbrook	Culvert	51
CT20.29	North of Maralla Road, Bullsbrook	Culvert	42
CP20.28	North of Maralla Road, Bullsbrook	Culvert	12
CT19.78	North of Maralla Road, Bullsbrook	Culvert	32
CT19.65	North of Maralla Road, Bullsbrook	Dual use drainage/ fauna culvert	44
CP19.27	North of Maralla Road, Bullsbrook	Culvert	10
CT19.27	North of Maralla Road, Bullsbrook	Culvert	41

Table 6: Summary of as-constructed Culvert Type and Locations



Culvert No.	Location	Туре	Length (m)
CP19.23	North of Maralla Road, Bullsbrook	Culvert	8
CT19.23	North of Maralla Road, Bullsbrook	Culvert	40
CT18.78	South of Warbrook Road, Bullsbrook	Culvert	38
CP18.78	South of Warbrook Road, Bullsbrook	Culvert	7
CP18.62	South of Warbrook Road, Bullsbrook	Culvert	10
CT18.62	South of Warbrook Road, Bullsbrook	Culvert	50
CP18.46	Warbrook Road, Bullsbrook	Culvert	8
CT18.46	Warbrook Road, Bullsbrook	Culvert	48
CP18.07	North of Warbrook Road, Bullsbrook	Culvert	7
CT18.05	North of Warbrook Road, Bullsbrook	Culvert	65
CT17.85A	South of Cunningham Road, Bullsbrook	Culvert	47
CP17.85	South of Cunningham Road, Bullsbrook	Culvert	22
CT17.76	South of Cunningham Road, Bullsbrook	Culvert	12
CT17.75	South of Cunningham Road, Bullsbrook	Culvert	53
CP17.75	South of Cunningham Road, Bullsbrook	Culvert	41
CP17.56	South of Cunningham Road, Bullsbrook	Culvert	9
CT17.53B	South of Cunningham Road, Bullsbrook	Culvert	22
CT17.53A	South of Cunningham Road, Bullsbrook	Culvert	29
CT17.51	South of Cunningham Road, Bullsbrook	Culvert	25
CT17.45A	South of Cunningham Road, Bullsbrook	Culvert	16
CT17.45B	South of Cunningham Road, Bullsbrook	Culvert	55
CT17.45	South of Cunningham Road, Bullsbrook	Culvert	8
CT17.44	South of Cunningham Road, Bullsbrook	Culvert	13
CT17.34B	South of Cunningham Road, Bullsbrook	Culvert	71
CP17.34	South of Cunningham Road, Bullsbrook	Culvert	8
CT17.33	South of Cunningham Road, Bullsbrook	Culvert	16
CT17.24	South of Cunningham Road, Bullsbrook	Culvert	65
CP17.24	South of Cunningham Road, Bullsbrook	Culvert	10
CC15.13	Cunningham Road, Bullsbrook	Culvert	28
CT16.84	North of Cunningham Road, Bullsbrook	Culvert	49
CP16.84	North of Cunningham Road, Bullsbrook	Culvert	10
CP16.57	South of Stock Road, Bullsbrook	Culvert	8
CT16.57	South of Stock Road, Bullsbrook	Culvert	53
CP16.30	South of Stock Road, Bullsbrook	Culvert	13
CT16.30	South of Stock Road, Bullsbrook	Culvert	99
CO00.01	Stock Road, Bullsbrook	Culvert	22
CO00.03	Stock Road, Bullsbrook	Culvert	23
CP16.00	Stock Road, Bullsbrook	Culvert	12
CS15.99	Stock Road, Bullsbrook	Culvert	54
CT15.87	Stock Road, Bullsbrook	Culvert	85
CS15.77	Stock Road, Bullsbrook	Culvert	34



Culvert No.	Location	Туре	Length (m)
CT15.03	North of Stock Road, Bullsbrook	Culvert	43
CP15.03	North of Stock Road, Bullsbrook	Culvert	8
CP14.75	North of Stock Road, Bullsbrook	Culvert	8
CT14.75	North of Stock Road, Bullsbrook	Culvert	37
CP14.58	North of Stock Road, Bullsbrook	Culvert	10
CP00.38	West of PDNH, North of Stock Road Bullsbrook	Culvert	9
CP00.48	West of PDNH, North of Stock Road Bullsbrook	Culvert	11
CP14.26	North of Stock Road, Bullsbrook	Culvert	7
CT14.26	North of Stock Road, Bullsbrook	Culvert	40
CP00.87	West of PDNH, North of Stock Road Bullsbrook	Culvert	12
CG00.02	North of Stock Road, Bullsbrook	Culvert	18
CG00.09	North of Stock Road, Bullsbrook	Culvert	11
CG00.01	North of Stock Road, Bullsbrook	Culvert	11
CP01.12	West of PDNH, North of Stock Road Bullsbrook	Culvert	12
CP13.72	Bullsbrook	Culvert	9
CT13.72	Bullsbrook	Culvert	45
CT13.18	Bullsbrook	Culvert	34
CP13.18	Bullsbrook	Culvert	7
CP01.97	West of PDNH, North of Stock Road Bullsbrook	Culvert	13
CP12.90	Bullsbrook	Culvert	11
CT12.90	Bullsbrook	Culvert	38
CT12.74	Bullsbrook	Culvert	41
CP12.74	Bullsbrook	Culvert	17
CP12.37	Bullsbrook	Culvert	16
CT12.37	Bullsbrook	Culvert	48
CP11.90	South of Neaves Road, Bullsbrook	Culvert	11
CT11.90	South of Neaves Road, Bullsbrook	Culvert	46
CT11.80	South of Neaves Road, Bullsbrook	Culvert	52
CP11.80	South of Neaves Road, Bullsbrook	Culvert	9
CT11.47	South of Neaves Road, Bullsbrook	Culvert	101
CD00.01	Neaves Road, Bullsbrook	Culvert	18
CT10.90	North of Neaves Road, Bullsbrook	Dual use drainage/ fauna culvert	137
CD00.65	North of Neaves Road, Bullsbrook	Culvert	17
CT10.70	North of Neaves Road, Bullsbrook	Dual use drainage/ fauna culvert	94
CP10.65	North of Neaves Road, Bullsbrook	Culvert	8
CD00.77	North of Neaves Road, Bullsbrook	Culvert	14
CP09.81	West of Muchea South Road, Bullsbrook	Culvert	8
CT09.81	West of Muchea South Road, Bullsbrook	Culvert	35
CD01.57	West of Muchea South Road, Bullsbrook	Culvert	14
CT09.70	West of Muchea South Road, Bullsbrook	Culvert	36
CD01.68	West of Muchea South Road, Bullsbrook	Culvert	12



Culvert No.	Location	Туре	Length (m)
CP09.70	West of Muchea South Road, Bullsbrook	Culvert	11
CD01.86	West of Muchea South Road, Bullsbrook	Dual use drainage/ fauna culvert	15
CT09.52	West of Muchea South Road, Bullsbrook	Dual use drainage/ fauna culvert	40
CP09.52	West of Muchea South Road, Bullsbrook	Culvert	10
CD02.11	West of Muchea South Road, Bullsbrook	Culvert	16
CT09.27	West of Muchea South Road, Bullsbrook	Culvert	35
CP09.27	West of Muchea South Road, Bullsbrook	Culvert	7
CP09.08	West of Muchea South Road, Bullsbrook	Culvert	10
CT09.08	West of Muchea South Road, Bullsbrook	Culvert	40
CD02.30	West of Muchea South Road, Bullsbrook	Culvert	17
CP08.65	West of Muchea South Road, Bullsbrook	Culvert	10
CT08.63	West of Muchea South Road, Bullsbrook	Culvert	43
CD02.75	West of Muchea South Road, Bullsbrook	Culvert	18
CD03.10	West of Muchea South Road, Bullsbrook	Culvert	16
CT08.27	West of Muchea South Road, Bullsbrook	Culvert	42
CP08.26	West of Muchea South Road, Bullsbrook	Culvert	12
CD03.20	West of Muchea South Road, Bullsbrook	Culvert	16
CD03.36	West of Muchea South Road, Bullsbrook	Culvert	13
CP07.82	West of Muchea South Road, Bullsbrook	Culvert	7
CT07.83	West of Muchea South Road, Bullsbrook	Culvert	53
CD03.55	West of Muchea South Road, Bullsbrook	Culvert	14
CP07.72	West of Muchea South Road, Bullsbrook	Culvert	8
CP07.50	West of Muchea South Road, Bullsbrook	Culvert	7
CT07.50	West of Muchea South Road, Bullsbrook	Culvert	42
CT07.27	West of Muchea South Road, Bullsbrook	Culvert	38
CP07.22	West of Muchea South Road, Bullsbrook	Culvert	12
CT06.88	West of Muchea South Road, Bullsbrook	Culvert	36
CP06.88	West of Muchea South Road, Bullsbrook	Culvert	7
CT06.41	West of Muchea South Road, Bullsbrook	Culvert	42
CP06.36	West of Muchea South Road, Bullsbrook	Culvert	14
CP06.22	West of Muchea South Road, Bullsbrook	Culvert	6
CT06.10	West of Muchea South Road, Bullsbrook	Culvert	95
CX05.50	East of Muchea South Road, Muchea	Culvert	12
CT05.50	East of Muchea South Road, Muchea	Culvert	68
CP05.20	East of Muchea South Road, Muchea	Culvert	8
CT05.20	East of Muchea South Road, Muchea	Culvert	38
CX05.20	East of Muchea South Road, Muchea	Culvert	16
CP04.95	East of Muchea South Road, Muchea	Culvert	10
CX04.95	East of Muchea South Road, Muchea	Culvert	14
CT04.95	East of Muchea South Road, Muchea	Culvert	49
CP04.77	East of Muchea South Road, Muchea	Culvert	8



Culvert No.	Location	Туре	Length (m)
CT04.77	East of Muchea South Road, Muchea	Culvert	44
CP04.65	East of Muchea South Road, Muchea	Culvert	12
CT04.65	East of Muchea South Road, Muchea	Culvert	44
CT04.56	East of Muchea South Road, Muchea	Culvert	56
CP04.18	East of Ellen Brook, Muchea	Culvert	7
CT04.18	East of Ellen Brook, Muchea	Culvert	45
CP03.89	East of Ellen Brook, Muchea	Culvert	10
CT03.89	East of Ellen Brook, Muchea	Culvert	53
CT03.64	East of Ellen Brook, Muchea	Culvert	43
CP03.64	East of Ellen Brook, Muchea	Culvert	7
CT03.52	East of Ellen Brook, Muchea	Culvert	36
CP03.52	East of Ellen Brook, Muchea	Culvert	7
CT03.20	East of Ellen Brook, Muchea	Culvert	38
CP03.20	East of Ellen Brook, Muchea	Culvert	10
CT03.14	East of Ellen Brook, Muchea	Culvert	41
CP03.14	East of Ellen Brook, Muchea	Culvert	12
CT03.11	East of Ellen Brook, Muchea	Culvert	43
CP03.11	East of Ellen Brook, Muchea	Culvert	8
CT02.89	East of Ellen Brook, Muchea	Culvert	35
CP02.89	East of Ellen Brook, Muchea	Culvert	8
CA00.01	East of Ellen Brook, Muchea	Culvert	5
CT02.60	East of Ellen Brook, Muchea	Culvert	47
CP02.60	East of Ellen Brook, Muchea	Culvert	13
CX02.39	East of Ellen Brook, Muchea	Culvert	22
CT02.39	East of Ellen Brook, Muchea	Culvert	89
CX02.33	Brand Hwy, Muchea	Culvert	13
CT02.28	Brand Hwy, Muchea	Culvert	112
CT02.20	Brand Hwy, Muchea	Culvert	95
WC02.12	Brand Hwy, Muchea	Culvert	99
CT02.00	Brand Hwy, Muchea	Culvert	104
CA00.59	Muchea	Culvert	5
CT01.41	Muchea	Dual use drainage/fauna culvert	102
CG00.11	Muchea	Culvert	26
CB02.87	Muchea	Culvert	37
CB02.33	Muchea	Culvert	38
CB00.33	Muchea	Culvert	67
CB02.03	Muchea	Culvert	47
CB01.94	Muchea	Culvert	44
CB03.42	Muchea	Culvert	26
CB01.92	Muchea	Culvert	24
CT00.97	Muchea	Culvert	90



Culvert No.	Location	Туре	Length (m)
CB00.89A	Muchea	Culvert	23
CB00.89B	Muchea	Culvert	25
CB00.09	Muchea	Culvert	40
CB00.78	Muchea	Culvert	14
CT00.69E	Muchea	Culvert	17
CT00.69	Muchea	Culvert	20
CT00.69B	Muchea	Culvert	120
CT00.69A	Muchea	Culvert	26
CB03.77	Muchea	Culvert	43
CT00.62	Muchea	Culvert	14
CB00.48	Muchea	Culvert	24
CT00.53A	Muchea	Culvert	24
CT00.53C	Muchea	Culvert	22
CT00.53B	Muchea	Culvert	70
CB03.97	Muchea	Culvert	62
CB00.28	Muchea	Culvert	10
CT00.28B	Muchea	Culvert	22
CT00.28A	Muchea	Culvert	86
CB04.16A	Muchea	Culvert	39
CB04.22	Muchea	Culvert	34
CB01.61	Muchea	Culvert	15
CB03.97	Muchea	Culvert	62
CB00.28	Muchea	Culvert	10
CT00.28B	Muchea	Culvert	22

The bridge locations are summarised in Table 7 and depicted in Figure 4. The bridge design drawings can be found in Appendix A.





Bridge No.	Location	Туре	Width (m)	Length (m)
9122A	PSP Footbridge South of Reid Highway/Tonkin Highway interchange	Footbridge	5	90
1777	Reid Highway/Tonkin Highway interchange	Traffic bridge	50	82
1778			56	87
1779			10	74
1780			19	87
9427	PSP underpasses at Reid Highway/Tonkin Highway	Underpass	10	17
9450	interchange		10	19
9430			10	14
9431			10	31
1782	Marshall Road over PDNH	Traffic bridge	28	74
1783	Hepburn Avenue over PDNH	Traffic bridge	16	26
1784			16	26
1785			16	25
1786			16	25
9425	Hepburn Avenue west of PDNH	Footbridge	4	60
1787	PDNH over Baal Street	Traffic bridge	16	23
1811	PDNH over Baal Street	Traffic Bridge	21	23
1788	PDNH over Gnangara Road	Traffic bridge	68	120
9426	Gnangara Road east of PDNH	Footbridge	5	98
9443	PSP underpass North of Gnangara Road	Underpass	10	80
1789	The Promenade over PDNH	Traffic bridge	14	37
1790			10	37
9432	PSP underpass at The Promenade	Underpass	13	56
1815	Maralla Road Bushland	Fauna Bridge	12	48
1801	PDNH over Stock Road	Traffic bridge	29	21
1802			27	21
9438	Stock Road East of PDNH	Underpass	10	46
1793	PDNH over Neaves Road	Traffic bridge	27	20
1794			27	20
1795	PDNH over Muchea South Road, railway and Almeria Parade	Traffic bridge	44	127
9437	Neaves Road East of PDNH	Footbridge	5	82
1796	PDNH over Ellen Brook	Traffic bridge	32	62
1797	PDNH over Brand Highway	Traffic bridge	36	32
1798	Brand Highway Deviation over Ellen Brook	Traffic bridge	30	45
1799	Brand Highway Deviation over Brand Highway and the Railway	Traffic bridge	17	137
1803	PDNH over Brand Highway Deviation	Traffic bridge	27	22
1804	1		27	27

Table 7: Summary of as-constructed Bridge Locations and Dimensions





Northlink Infrastructure Report - Figure 4 - Location of culverts and bridges - AsCon Map 1 of 6

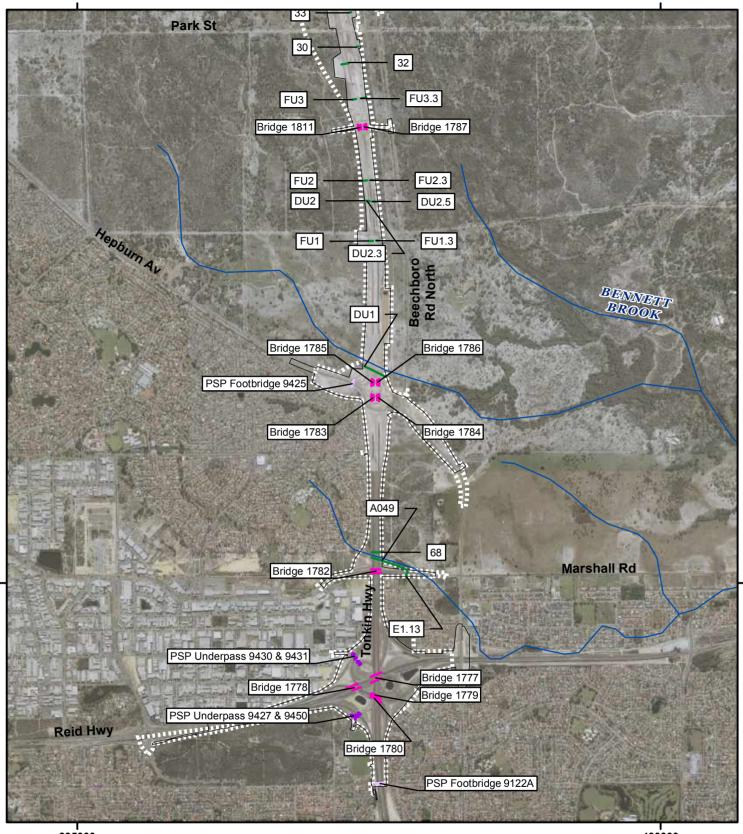

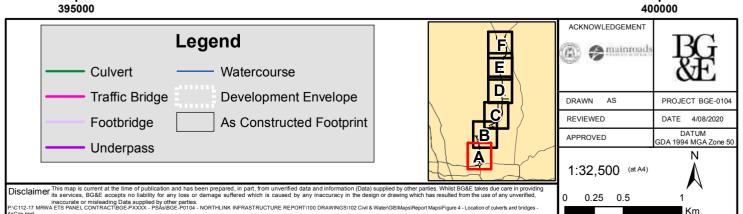

Northlink Infrastructure Report - Figure 4 - Location of culverts and bridges - AsCon Map 2 of 6

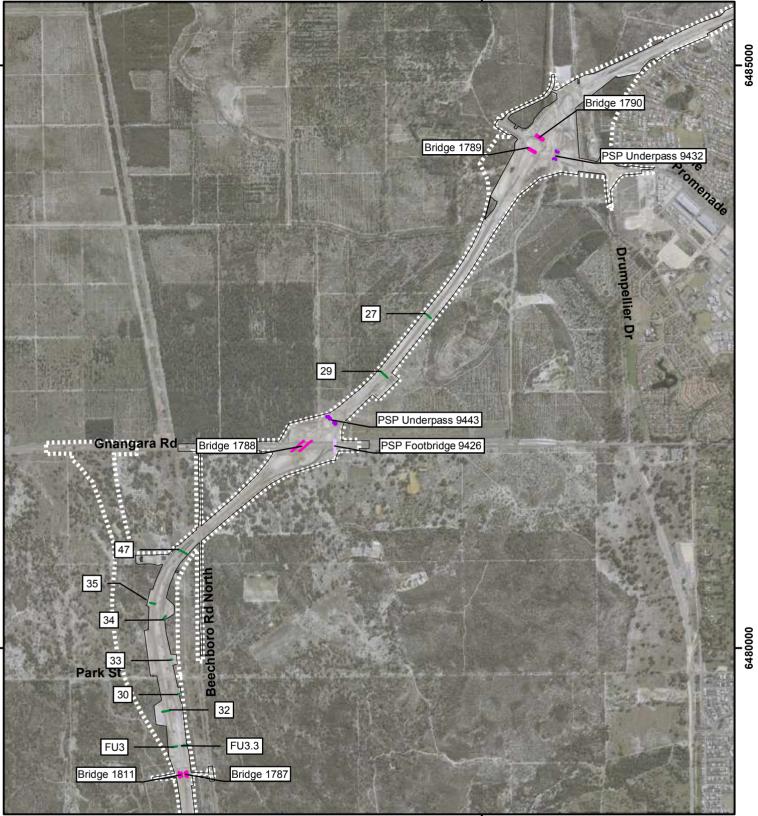

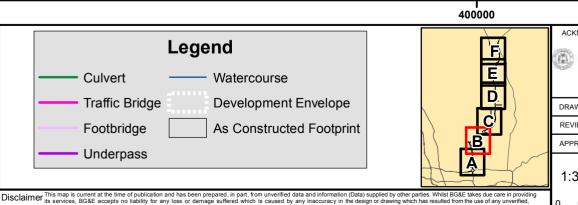


GIS\Maps\Report Maps\Figure 4 - Location of culverts and bridge


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Northlink Infrastructure Report - Figure 4 - Location of culverts and bridges - AsCon Map 3 of 6



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1:32,500 (at A4) Disclaimer This map is current at the time of publication and has been prepared, in part, from unverified data and information (Data) supplied by other parties. Whilst BG&E takes due care in providing its services, BG&E accepts no liability for any loss or damage suffered which is caused by any inaccuracy in the design or drawing which has resulted from the use of any unverified, inaccurate or misleading Data supp WA ETS PANEL CONTRACT\BGE-PXXXX ed by other parties. - PSAs\BGE-P0104 - NORTHLINK INFRASTRUCTURE REPORT\100 DRAWINGS\102 Civil & Wa C112-17 M GIS\Maps\Report Maps\Figure 4 - Location of culverts and bridge

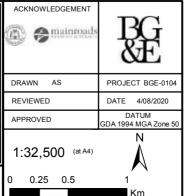Development Envelope


As Constructed Footprint

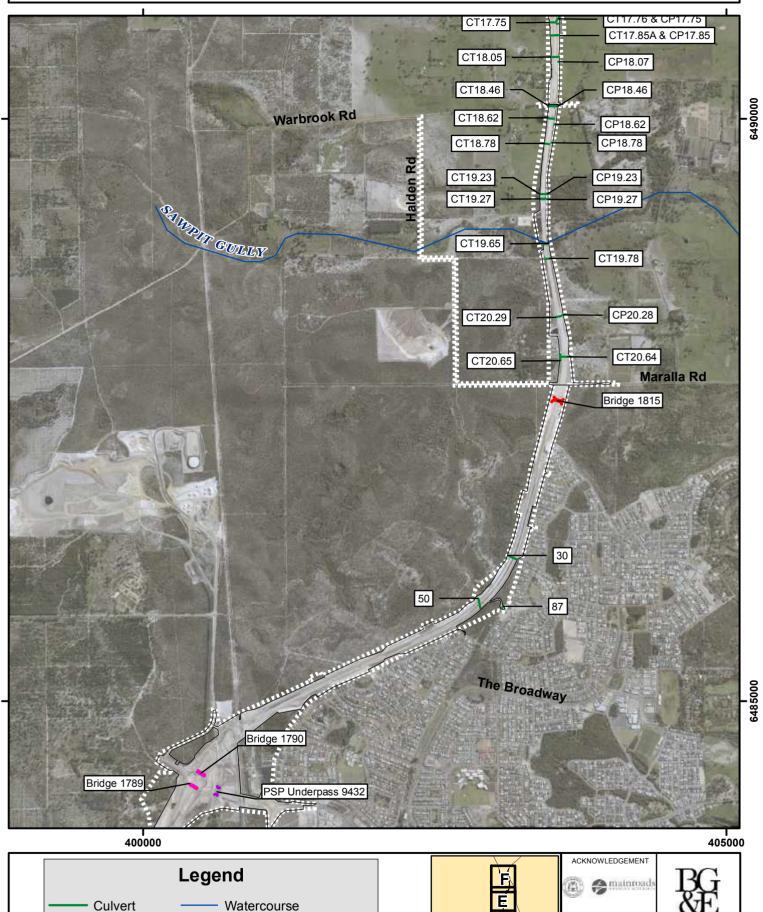
Traffic Bridge

Fauna Bridge

Underpass


Northlink Infrastructure Report - Figure 4 - Location of culverts and bridges - AsCon Map 4 of 6

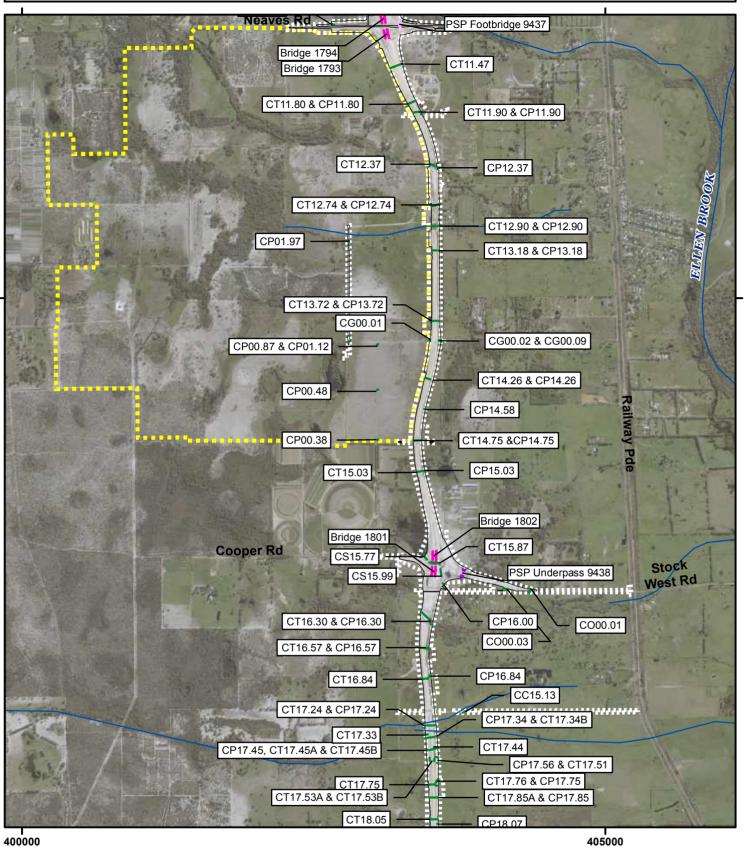


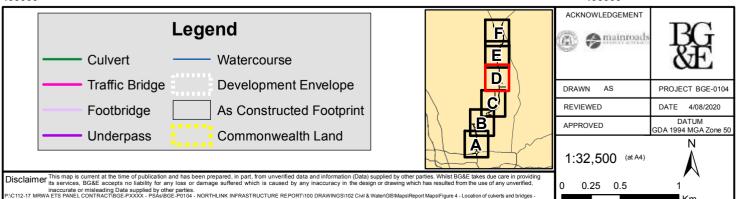

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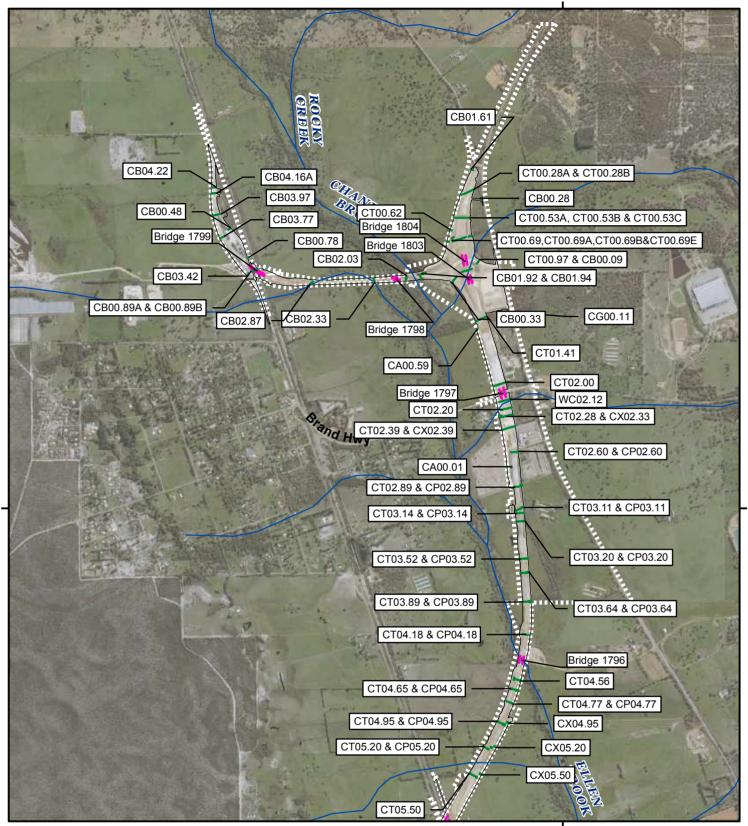
Northlink Infrastructure Report - Figure 4 - Location of culverts and bridges - AsCon Map 5 of 6



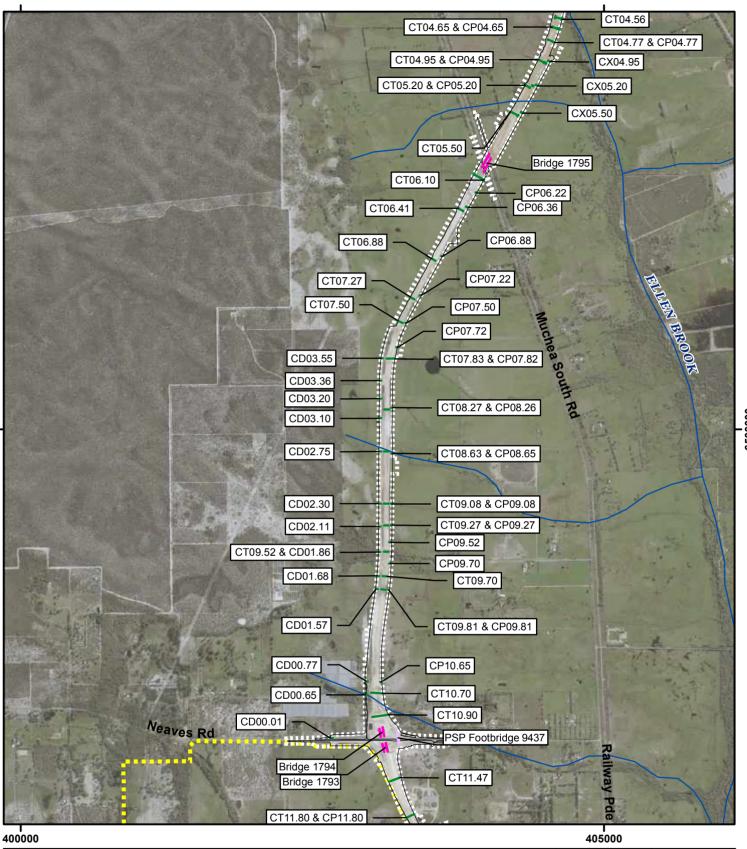
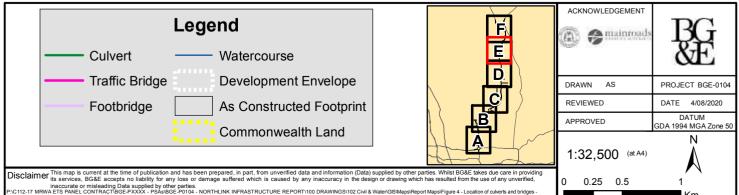
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Northlink Infrastructure Report - Figure 4 - Location of culverts and bridges - AsCon Map 6 of 6



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Legend	E	ACKNOWLEDGEMENT	BG
Culvert — Watercourse			
Traffic Bridge Development Envelope		DRAWN AS	PROJECT BGE-0104
As Constructed Footprint		REVIEWED	DATE 4/08/2020
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Disclaimer This map is current at the time of publication and has been prepared, in part, from unverified data and information (Data) su inaccurate or misleading Data supplied by other parties. PIC112-17 MRWA ETS PANEL CONTRACTIGGEPXXX - PS&IGE-P0104 - NORTHLINK INFRASTRUCTURE REPORT100 DRAWINGS102 Civil & W		0 0.25 0.5	1 1

3.5 Bio-retention Swales and Infiltration Basins

Bio-retention swales, bio-retention basins, infiltration and detention basins, have been installed along the alignment in order to minimise impacts from the proposal to the quality of groundwater and surface water within the vicinity of Ellen Brook and within the GUWPCA.

Table 8 and Figure 5 show the location of all types of swales and basins in the vicinity of Ellen Brook and within the GUWPCA.

<u>Note</u>: the basin and swale locations are consistent between the Infrastructure Plan and the Condition Environmental Management Plan – Inland Waters Environmental Quality (Hydrological Processes).

Table 8 shows the as-constructed basin and swale dimensions. All swale and basin locations as proposed in the Infrastructure Plan / CEMP have been constructed along the alignment. In addition to this, there has been a significant amount of drainage features constructed along the alignment.

Basin/ Swale No.	Location	Туре	Area (m²)	Length (m)
S01	Ballajura	Bio Retention Swale		100
BASIN HB06	Ballajura	Detention Basin	2324	
S02	Ballajura	Bio Retention Swale		250
BASIN BEECH 1	Ballajura	Detention Basin	587	
S03	Ballajura	Bio Retention Bund		5
BASIN HB12	Ballajura	Detention Basin	210	
S04	Ballajura	Bio Retention Swale		266
BASIN HB12A	Ballajura	Detention Basin	1703	
S05	Ballajura	Bio Retention Bund		20
S06	Ballajura	Bio Retention Bund		152
BASIN HB07	Ballajura	Detention Basin	2210	
S07	Ballajura	Bio Retention Bund		30
BASIN HB09	Ballajura	Detention Basin	10213	
S08	Ballajura	Bio Retention Bund		39
S09	Ballajura	Bio Retention Bund		44
BASIN HB11	Ballajura	Detention Basin	1433	
BASIN HB10	Hepburn Ave Interchange	Detention Basin	3713	
BASIN HB08	Hepburn Ave Interchange	Detention Basin	5990	
BASIN HB26	Hepburn Ave Interchange	Detention Basin	429	
BASIN HB14	Hepburn Ave Interchange	Detention Basin	2211	
BASIN HB13	Hepburn Ave Interchange	Detention Basin	1632	
BASIN HB25	Hepburn Ave Interchange	Detention Basin	3686	
BASIN HB19	Hepburn Ave Interchange	Detention Basin	334	
BASIN HB20	Hepburn Ave Interchange	Detention Basin	597	
BASIN HB24	Hepburn Ave Interchange	Detention Basin	1792	
BASIN HB18	Hepburn Ave Interchange	Detention Basin	2125	
BASIN HEP5	Hepburn Ave Interchange	Detention Basin	2456	
BASIN HEP1	Ballajura	Detention Basin	14120	

Table 8: Summary of as-constructed Basins and Swales



Basin/ Swale No.	Location	Туре	Area (m²)	Length (m
BASIN HB28	Ballajura	Detention Basin	445	
BASIN HB23	Ballajura	Detention Basin	646	
BASIN HEP6	Cullabardee	Detention Basin	650	
BASIN HB17	Cullabardee	Detention Basin	1215	
BASIN HB15	Cullabardee	Detention Basin	26099	
S10	Cullabardee	Bio Retention Swale		185
S11	Cullabardee	Bio Retention Swale		364
S12	Cullabardee	Bio Retention Swale		197
BASIN LD03	Cullabardee	Detention Basin	5929	
S13	Cullabardee	Bio Retention Swale		145
BASIN HB04	Cullabardee	Detention Basin	186	
S14	Cullabardee	Bio Retention Swale		43
S15	Cullabardee	Bio Retention Swale		137
BASIN HB22	Cullabardee	Detention Basin	887	
S16	Cullabardee	Bio Retention Swale		28
S17	Cullabardee	Bio Retention Swale		62
BASIN HB01	Cullabardee	Detention Basin	109	
BASIN HB03	Cullabardee	Detention Basin	302	
BASIN HB02	Cullabardee	Detention Basin	346	
BASIN HB21	Cullabardee	Detention Basin	1180	
S18	Whiteman	Bio Retention Swale		55
S19	Whiteman	Bio Retention Swale		69
S20	Whiteman	Bio Retention Swale		91
S21	Whiteman	Bio Retention Swale		140
BASIN GB25	Whiteman	Detention Basin	7250	
BASIN GB26	Whiteman	Detention Basin	674	
BASIN GB24	Whiteman	Detention Basin	355	
\$22	Whiteman	Bio Retention Swale		546
\$23	Whiteman	Bio Retention Swale		187
S24	Whiteman	Bio Retention Swale		718
BASIN GB23	Whiteman	Detention Basin	1244	
BASIN GB22	Whiteman	Detention Basin	17480	
\$25	Whiteman	Bio Retention Swale		246
BASIN GB21	Whiteman	Detention Basin	4202	
BASIN GB20	Whiteman	Detention Basin	790	
LANDSCAPE DEPRESSION LD01	Whiteman	Detention Basin	11206	
BASIN GB19	Whiteman	Detention Basin	1584	
BASIN GB18	Whiteman	Detention Basin	1568	
BASIN GB16	Whiteman	Detention Basin	4119	
BASIN GB17	Whiteman	Detention Basin	555	
S26	Whiteman	Bio Retention Swale		134



Basin/ Swale No.	Location	Туре	Area (m²)	Length (m)
S27	Whiteman	Bio Retention Swale		141
S28	Whiteman	Bio Retention Swale		200
BASIN GB15	Lexia/Gnangara Rd Interchange	Detention Basin	643	
BASIN GB12	Lexia/Gnangara Rd Interchange	Detention Basin	3256	
BASIN GB10	Lexia/Gnangara Rd Interchange	Detention Basin	1027	
BASIN GB14	Lexia/Gnangara Rd Interchange	Detention Basin	745	
BASIN GB11	Lexia/Gnangara Rd Interchange	Detention Basin	2491	
BASIN GB13	Lexia/Gnangara Rd Interchange	Detention Basin	61	
BASIN GB06	Lexia/Gnangara Rd Interchange	Detention Basin	201	
BASIN GB09	Lexia/Gnangara Rd Interchange	Detention Basin	933	
BASIN GB08	Lexia/Gnangara Rd Interchange	Detention Basin	4080	
BASIN GB05	Lexia/Gnangara Rd Interchange	Detention Basin	5398	
BASIN GB07	Lexia/Gnangara Rd Interchange	Detention Basin	2131	
COMBINED BASIN GB02 & GB04	Lexia	Detention Basin	6314	
BASIN GB03	Lexia	Detention Basin	15821	
BASIN GB01	Lexia	Detention Basin	2293	
BASIN PR29	Lexia	Detention Basin	415	
BASIN PR30	Lexia	Detention Basin	408	
S29	Lexia	Bio Retention Bund		7
S30	Lexia	Bio Retention Bund		92
S31	Lexia	Bio Retention Bund		134
BASIN PR28	Lexia	Detention Basin	1164	
BASIN PR27	Lexia	Detention Basin	999	
S32	Lexia	Bio Retention Swale		36
S33	Lexia	Bio Retention Swale		350
S34	Lexia	Bio Retention Swale		514
S35	Lexia	Bio Retention Bund		117
BASIN PR26	Lexia		1466	
\$36	Lexia	Bio Retention Swale		0
S37	Lexia	Bio Retention Swale		98
S38	Lexia	Bio Retention Swale		13
S39	Lexia	Bio Retention Swale		60
BASIN PR25	Lexia/The Promenade Interchange	Detention Basin	439	
S40	Lexia/The Promenade Interchange	Bio Retention Bund		62
BASIN PR24	Lexia/The Promenade Interchange	Detention Basin	1433	
BASIN PR23	Lexia/The Promenade Interchange	Detention Basin	10931	
BASIN PR17	Lexia/The Promenade Interchange	Detention Basin	1439	
BASIN PR18	Lexia/The Promenade Interchange	Detention Basin	557	
BASIN PR21	Lexia/The Promenade Interchange	Detention Basin	4613	
BASIN PR22	Lexia/The Promenade Interchange	Detention Basin	1957	
BASIN PR20	Lexia/The Promenade Interchange	Detention Basin	1531	



Basin/ Swale No.	Location	Туре	Area (m²)	Length (m)
BASIN PR19	Lexia/The Promenade Interchange	Detention Basin	5841	
BASIN PR16	Lexia/The Promenade Interchange	Detention Basin	889	
BASIN PR15	Lexia/The Promenade Interchange	Detention Basin	1005	
BASIN PR11	Lexia/The Promenade Interchange	Detention Basin	2768	
S41	Lexia/The Promenade Interchange	Bio Retention Bund		8
COMBINED BASIN PR09 & PR12	Lexia/The Promenade Interchange	Detention Basin	9490	
BASIN PR14	Lexia/The Promenade Interchange	Detention Basin	1184	
BASIN PR13	Lexia/The Promenade Interchange	Detention Basin	890	
BASIN PR10	Lexia/The Promenade Interchange	Detention Basin	2576	
BASIN PR08	Ellenbrook	Detention Basin	7440	
BASIN PR07	Ellenbrook	Detention Basin	2230	
BASIN PR05	Ellenbrook	Detention Basin	3415	
BASIN PR06	Ellenbrook	Detention Basin	3242	
BASIN PR04	Ellenbrook	Detention Basin	3318	
BASIN PR03	Ellenbrook	Detention Basin	5053	
BASIN PR02	Ellenbrook	Detention Basin	2022	
BASIN PR01	Ellenbrook	Detention Basin	1331	
BASIN PR31	Ellenbrook	Detention Basin	4603	
BASIN PR32	Bullsbrook	Detention Basin	1295	
Infiltration Basin-NO-N-20.41	Bullsbrook	Infiltration Basin	2448	
Bioretention Basin NO-N-20.32	Bullsbrook	Bioretention Basin	194	
Bioretention Basin SO-S-20.32	Bullsbrook	Bioretention Basin	108	
Infiltration Basin-N0-N-20.25	Bullsbrook	Infiltration Basin	122	
Bioretention Basin SO-S-20.25	Bullsbrook	Bioretention Basin	166	
Infiltration Basin-NO-N-20.20	Bullsbrook	Infiltration Basin	412	
Infiltration Basin-NO-N-20.10	Bullsbrook	Infiltration Basin	1294	
Infiltration Basin-NO-N-19.77	Bullsbrook	Infiltration Basin	1380	
Bioretention Basin NO-N-19.70	Bullsbrook	Bioretention Basin	201	
Bioretention Basin NO-N-19.62	Bullsbrook	Bioretention Basin	216	
Infiltration Basin-NO-N-19.50	Bullsbrook	Infiltration Basin	5062	
Infiltration Basin-S0-S-19.50	Bullsbrook	Infiltration Basin	681	
Bioretention Basin SO-S-19.30	Bullsbrook	Bioretention Basin	177	
Bioretention Basin NO-N-19.35	Bullsbrook	Bioretention Basin	127	
Bioretention Basin NO-N-19.25	Bullsbrook	Bioretention Basin	220	
Bioretention Basin NO-N-19.25	Bullsbrook	Bioretention Basin	246	
Bioretention Basin SO-S-19.20	Bullsbrook	Bioretention Basin	490	
Bioretention Basin NO-N-19.15	Bullsbrook	Bioretention Basin	554	
Detention Basin S0-S-18.85	Bullsbrook	Detention Basin	589	
Detention Basin NO-N-18.90	Bullsbrook	Detention Basin	494	
Detention Basin S0-S-10.70	Bullsbrook	Detention Basin	251	
Detention Basin N0-N-18.70	Bullsbrook	Detention Basin	173	




Basin/ Swale No.	Location	Туре	Area (m²)	Length (m)
Detention Basin NO-N-18.50	Bullsbrook	Detention Basin	138	
Detention Basin S0-S-18.55	Bullsbrook	Detention Basin	1019	
Detention Basin S0-S-16.58	Bullsbrook	Detention Basin	306	
Detention Basin S0-S-16.42	Bullsbrook	Detention Basin	359	
Detention Basin C2-E-00.34	Bullsbrook	Detention Basin	738	
Detention Basin C3-E-00.52	Bullsbrook/Stock Rd Interchange	Detention Basin	1314	
Infiltration Basin 05-E-00.63	Bullsbrook/Stock Rd Interchange	Infiltration Basin	632	
Infiltration Basin 05-E-00.55	Bullsbrook/Stock Rd Interchange	Infiltration Basin	454	
Infiltration Basin 05-W-0.55	Bullsbrook/Stock Rd Interchange	Infiltration Basin	413	
Infiltration Basin 05-W-00.35	Bullsbrook/Stock Rd Interchange	Infiltration Basin	163	
Detention Basin C1-W-00.65	Bullsbrook/Stock Rd Interchange	Detention Basin	449	
Detention Basin C4-W-00.10	Bullsbrook/Stock Rd Interchange	Detention Basin	864	
Detention Basin S0-S-15.22	Bullsbrook	Detention Basin	230	
Detention Basin N0-N-15.16	Bullsbrook	Detention Basin	232	
Bioretention Basin S0-S-15.05	Bullsbrook	Bioretention Basin	402	
Bioretention Basin S0-S-15.01	Bullsbrook	Bioretention Basin	268	
Bioretention Basin S0-S-14.73	Bullsbrook	Bioretention Basin	261	
Bioretention Basin S0-S-14.45	Bullsbrook	Bioretention Basin	123	
Bioretention Basin S0-S-14.50	Bullsbrook	Bioretention Basin	130	
Detention Basin S0-S-11.78	Bullsbrook	Detention Basin	74	
Detention Basin N0-N-11.73	Bullsbrook	Detention Basin	454	
Detention Basin S0-S-11.71	Bullsbrook	Detention Basin	69	
Detention Basin S0-S-11.66	Bullsbrook	Detention Basin	90	
Detention Basin MW-W-00.22	Bullsbrook	Detention Basin	65	
Detention Basin MW-W-00.62	Bullsbrook	Detention Basin	178	
Detention Basin M0-S-00.13	Bullsbrook/Neaves Rd Interchange	Detention Basin	799	
Bioretention Basin JB-S-00.24	Bullsbrook/Neaves Rd Interchange	Bioretention Basin	96	
Detention Basin M0-W-00.36	Bullsbrook/Neaves Rd Interchange	Detention Basin	2560	
Detention Basin M0-E-00.09	Bullsbrook/Neaves Rd Interchange	Detention Basin	2832	
Bioretention Basin J1-N-0.1.17	Bullsbrook/Neaves Rd Interchange	Bioretention Basin	219	
Bioretention Basin M1-E-00.13	Bullsbrook/Neaves Rd Interchange	Bioretention Basin	415	
Bioretention Basin M4-W-00.14	Bullsbrook/Neaves Rd Interchange	Bioretention Basin	248	
Detention Basin S0-S-10.60	Bullsbrook	Detention Basin	357	
Detention Basin N0-N-6.27	Muchea	Detention Basin	143	
Detention Basin NO-N-5.65	Muchea	Detention Basin	982	
Detention Basin NO-N-5.40	Muchea	Detention Basin	429	
Detention Basin NO-N-5.02	Muchea	Detention Basin	457	
Detention Basin NO-N-4.90	Muchea	Detention Basin	145	
Detention Basin NO-N-4.80	Muchea	Detention Basin	402	
Detention Basin NO-N-4.70	Muchea	Detention Basin	312	
Detention Basin N0-N-4.60	Muchea	Detention Basin	618	




Basin/ Swale No.	Location	Туре	Area (m²)	Length (m)
Detention Basin NO-N-4.25	Muchea	Detention Basin	189	
Detention Basin N0-N-4.05	Muchea	Detention Basin	165	
Detention Basin S0-S-3.75	Muchea	Detention Basin	285	
Detention Basin NO-N-3.75	Muchea	Detention Basin	234	
Detention Basin S0-S-3.57	Muchea	Detention Basin	127	
Detention Basin NO-N-3.57	Muchea	Detention Basin	159	
Detention Basin S0-S-3.45	Muchea	Detention Basin	134	
Detention Basin NO-N-3.45	Muchea	Detention Basin	269	
Detention Basin NO-N-3.25	Muchea	Detention Basin	214	
Detention Basin S0-S-3.25	Muchea	Detention Basin	285	
Detention Basin NO-N-3.17	Muchea	Detention Basin	255	
Detention Basin N0-N-3.05	Muchea	Detention Basin	143	
Detention Basin SO-N-3.05	Muchea	Detention Basin	140	
Detention Basin SO-N-3.05	Muchea	Detention Basin	107	
Detention Basin N0-N-02.43	Muchea	Detention Basin	791	
Detention Basin N0-N-02.22	Muchea	Detention Basin	133	
Detention Basin B7-W-00.00	Muchea	Detention Basin	702	
Detention Basin B7-W-00.27	Muchea/Brand Hwy Interchange	Detention Basin	377	
Detention Basin BO-R-00.17	Muchea/Brand Hwy Interchange	Detention Basin	231	
Detention Basin B0-R-00.37	Muchea/Brand Hwy Interchange	Detention Basin	176	
Detention Basin BD-W-01.80	Muchea/Brand Hwy Interchange	Detention Basin	2036	
Detention Basin BO-R-00.06	Muchea/Brand Hwy Interchange	Detention Basin	112	
Detention Basin B0-R-00.64	Muchea/Brand Hwy Interchange	Detention Basin	274	
Detention Basin D4-N-00.03	Muchea	Detention Basin	157	
Detention Basin CS-S-00.54	Muchea	Detention Basin	166	
Detention Basin B4-N-00.35	Muchea	Detention Basin	96	
Detention Basin B1-S-00.38	Muchea	Detention Basin	183	
Detention Basin B4-N-00.64	Muchea	Detention Basin	181	
Detention Basin BD-W-02.50	Muchea	Detention Basin	120	
Detention Basin BD-E-02.50	Muchea	Detention Basin	122	
Detention Basin BD-W-01.50	Muchea	Detention Basin	170	



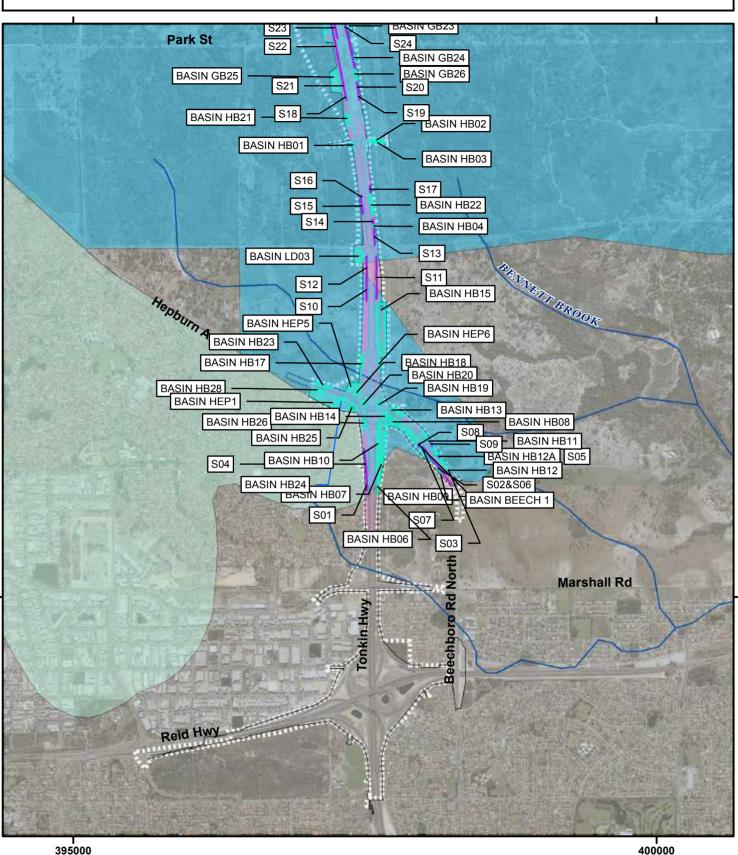


Northlink Infrastructure Report - Figure 5 - Location of swales and basins - AsCon Map 1 of 6

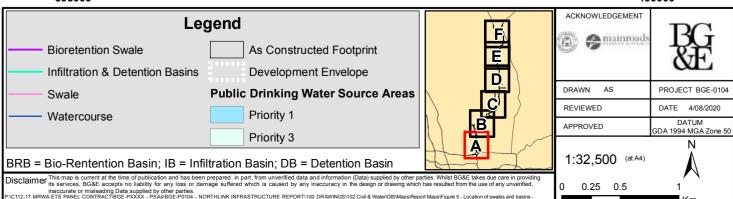


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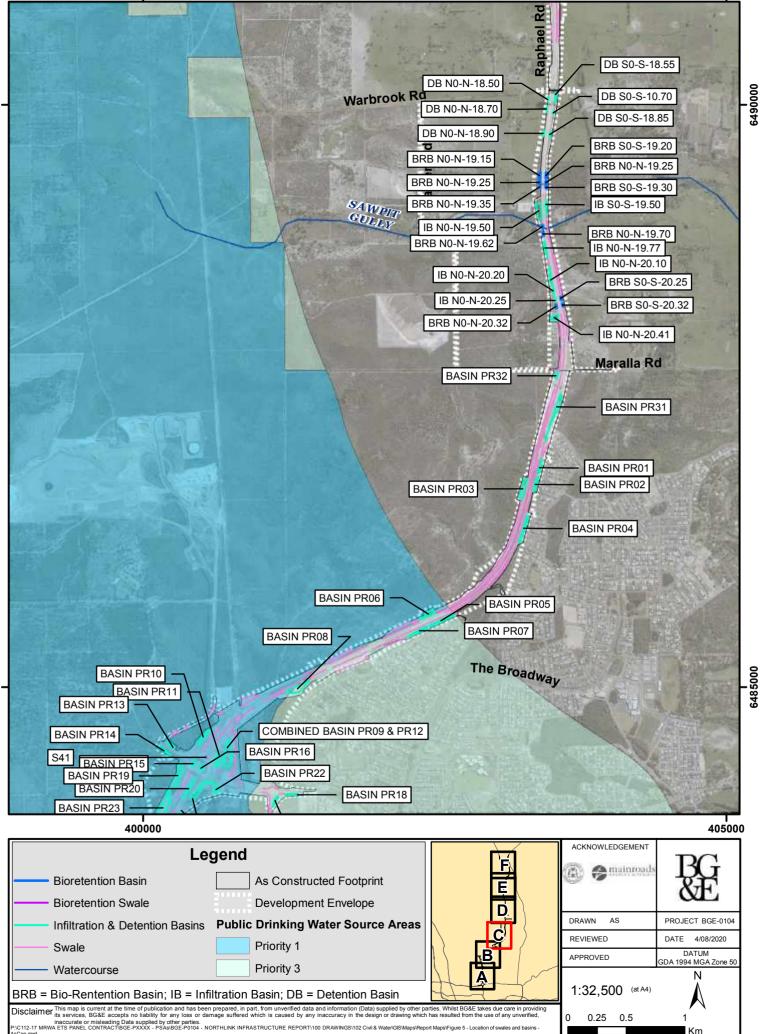
Northlink Infrastructure Report - Figure 5 - Location of swales and basins - AsCon Map 2 of 6



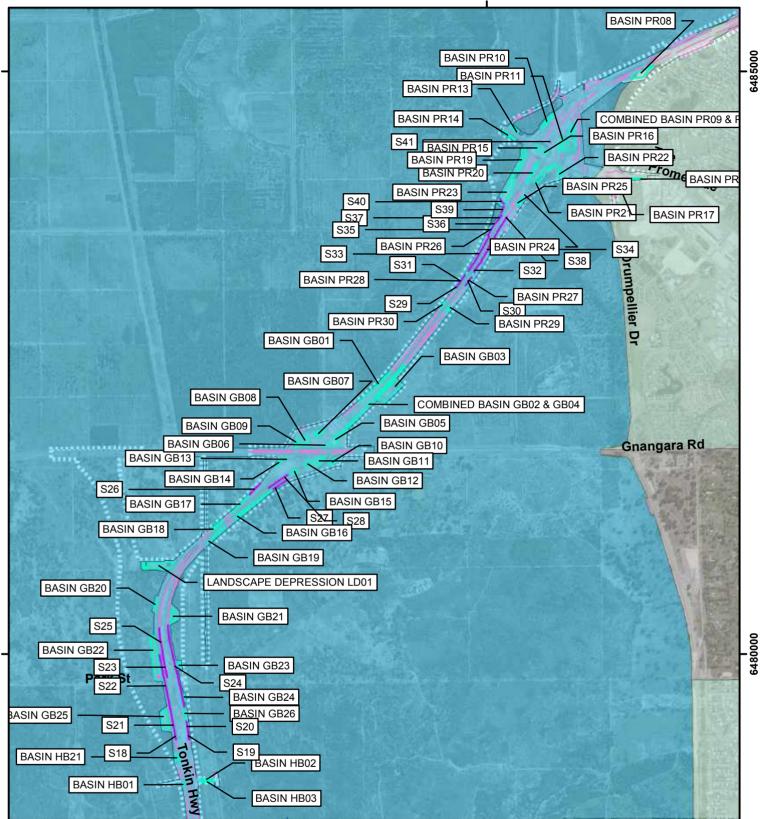


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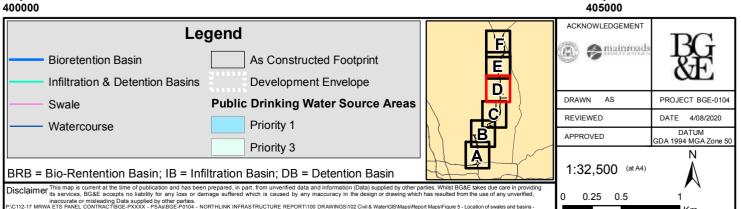
Northlink Infrastructure Report - Figure 5 - Location of swales and basins - AsCon Map 3 of 6

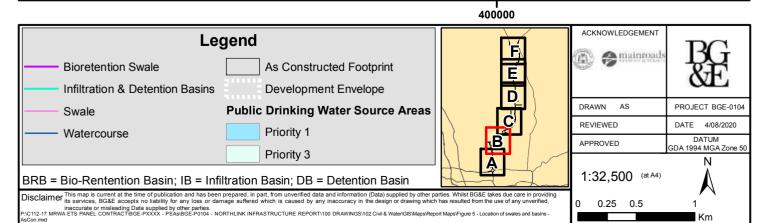

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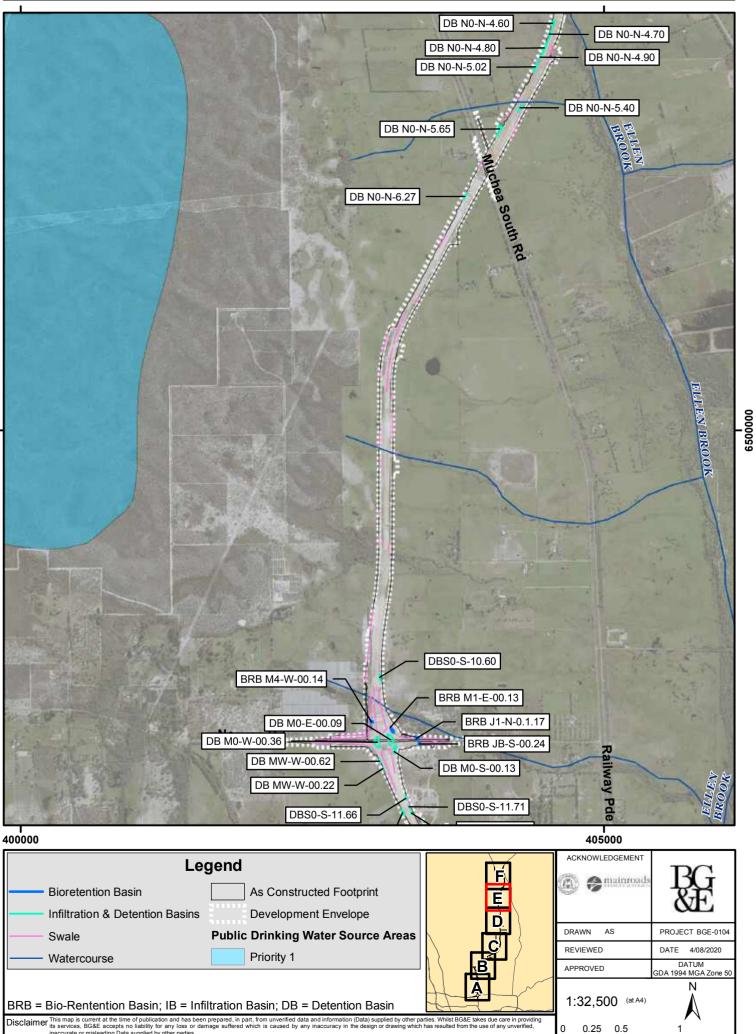




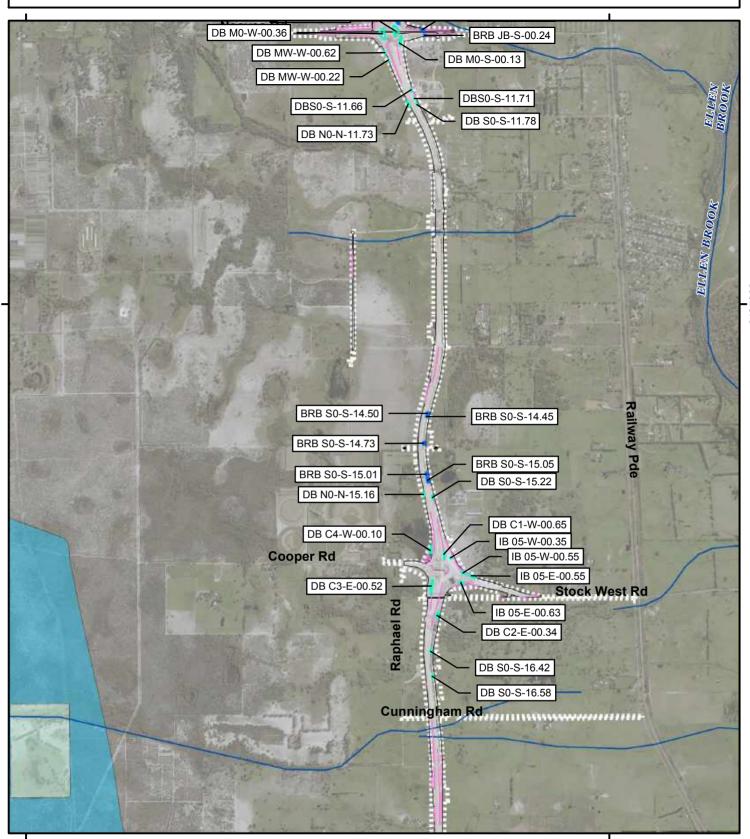

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Northlink Infrastructure Report - Figure 5 - Location of swales and basins - AsCon Map 5 of 6




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MRWA ETS PANEL CONTRACT/BGE-PXXXX - PSAs/BGE-P0104 - NORTHLINK INFRASTRUCTURE REPORT/100 DRAWINGS/102 Civil & Water/GS/Maps/Report Maps/Figure 5 - Location of swates and bas

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Northlink Infrastructure Report - Figure 5 - Location of swales and basins - AsCon Map 6 of 6



ACKNOWLEDGEMENT Legend mainroad Infiltration & Detention Basins As Constructed Footprint Swale **Development Envelope** DRAWN AS PROJECT BGE-0104 **Public Drinking Water Source Areas** Watercourse REVIEWED DATE 4/08/2020 Priority 1 DATUM APPROVED DA 1994 MGA Zone 50 N 1:32,500 (at A4) BRB = Bio-Rentention Basin; IB = Infiltration Basin; DB = Detention Basin Disclaimer This map is current at the time of publication and has been prepared, in part, fro its services, BG&E accepts no liability for any loss or damage suffered which rified data and information (Data) supplied by other parties. Whilst BG&E takes due care in providing ed by any inaccuracy in the design or drawing which has resulted from the use of any unverified. 0 0.25 0.5 1 eading Data supplied by other p ort Maps/Figure 5 - Location of swales and basins Km

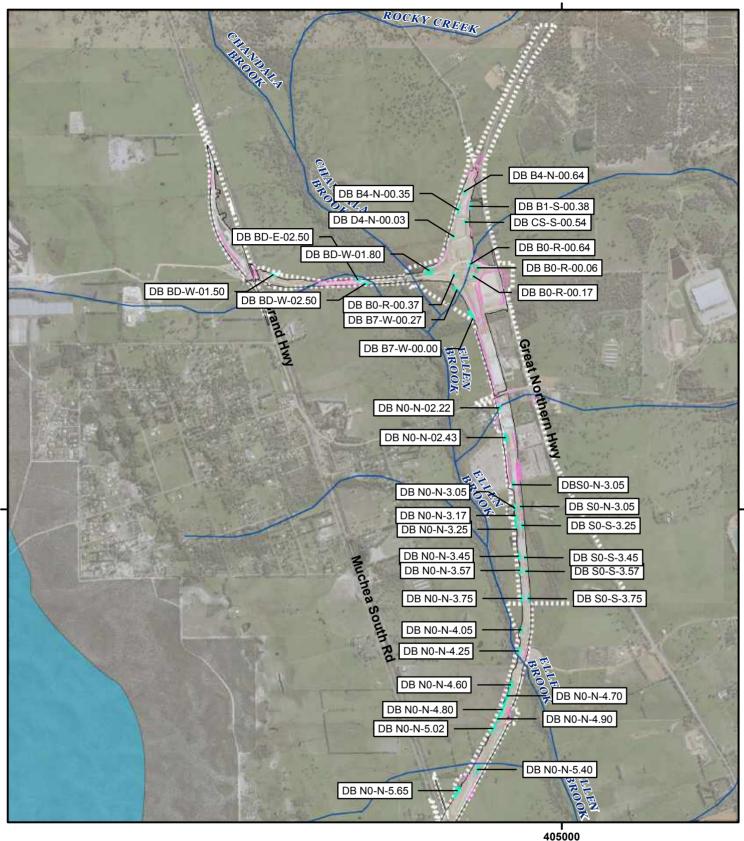3.6 Noise Walls

Noise walls have been installed to mitigate existing noise sensitive receptors south of Maralla Road and have been installed within the Development Envelope. The locations, lengths and heights of the noise walls are shown in Figure 7 and are also detailed in Table 9. Noise walls have been constructed to a maximum height of 5.5 m. As shown in table 9, NW-01, NW-02 and NW-10B have been constructed lower than the proposed height in the Infrastructure Plan/ CEMP Noise. Detailed design has resulted in refinements in wall heights required in order to meet the noise target and in some instances, this has resulted in a lower wall height.

<u>Note</u>: the same noise wall figures are provided in both the Infrastructure Plan and the Condition Environmental Management Plan Amenity (Noise), hence all noise wall locations and heights are consistent between these documents. Table 9 compares the as constructed heights against both the Infrastructure Plan and the CEMP.

Ascon label	Length (m)	Ascon Height (m)	Infrastructure Plan/CEMP Noise		
			Height (m)		
NW-01	74.3	3.0	5.0		
NW-02	34.4	3.0	5.0		
NW-03	CHA 0-60	2.5	4.5		
	CHA 60-536	3.5			
	CHA 536-576	4.0			
	CHA 576-915	5.0			
NW-3A	CHA 0-40	5.0	5.0		
	CHA 40-60	4.5			
	CHA 60-174	3.0			
NW-04	CHA 212-390	4.0	4.5		
	CHA 390-420	4.5			
	CHA 420-513	5.0			
NW-05	364	5.0	5.0		
NW-06	800	5.0	5.0		
NW-07	212.2	5.0	3.0		
NW-08	516	5.0	5.0		
NW-09	409	5.0	5.0		
NW-10	652	5.0	5.0		
NW-10B	CHA 280-512	3.0	5.0		
	CHA 512-547	4.0			
NW-11	193.1	2.5	3.0		
NW-12	75.4	2.5	3.0		
NW-13	37.2	2.5	3.0		
NW-14	342	3.5	4.0		
NW-15	671.5	5.0	5.0		
NW-16	CHA 0-544	5.0	5.0		
	CHA 544-676	5.5			
	CHA 676-905	5.0			


Table 9: Summary of Noise Wall Heights




Ascon label	Length (m)	Ascon Height (m)	Infrastructure Plan/CEMP Noise Height (m)
NW-17	352.2	5.0	5.0
NW-18	720.1	5.0	5.0
NW-19	CHA 0-122	2.5	5.0
	CHA 122-170	3.0	
	CHA 170-234	4.0	
	CHA 234-262	5.0	
	CHA 262-406	5.5	
	CHA 406-765	5.0	





Northlink Infrastructure Report - Figure 6 - Location of Noise Walls - AsCon Map 1 of 2

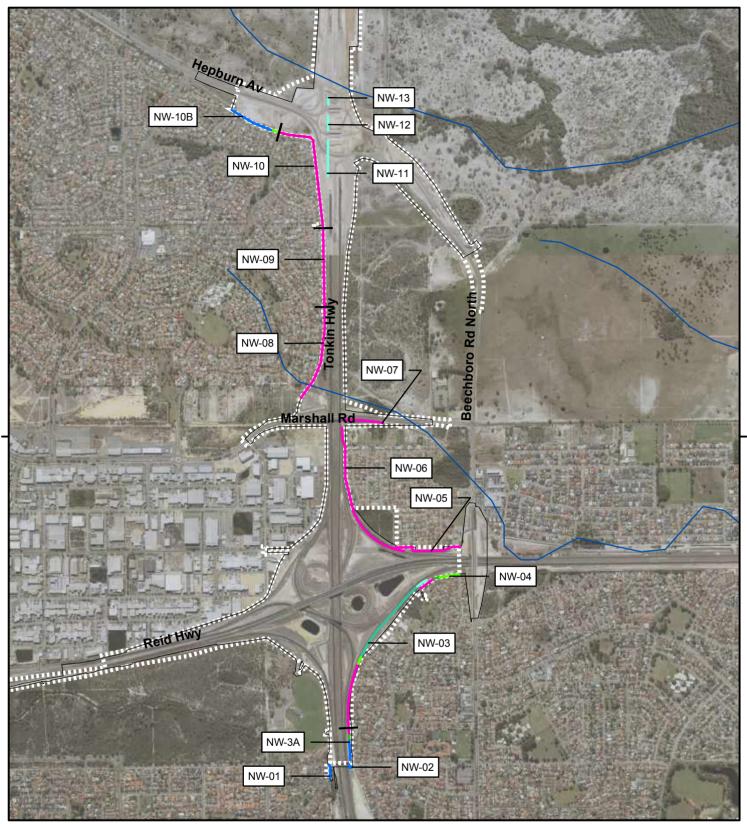

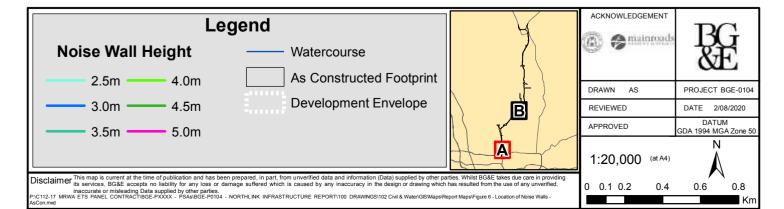

Northlink Infrastructure Report - Figure 6 - Location of Noise Walls - AsCon Map 2 of 2

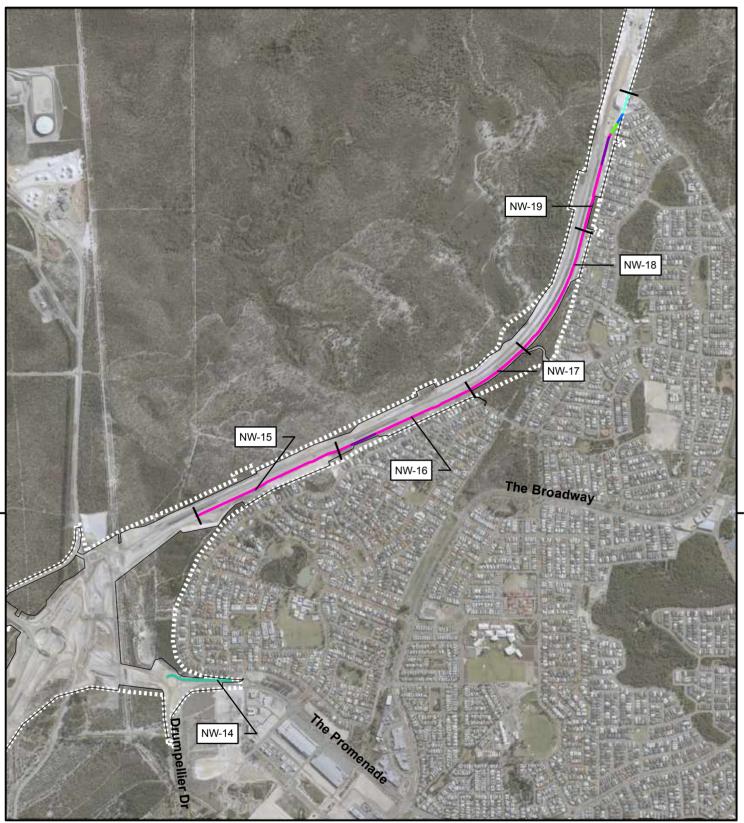

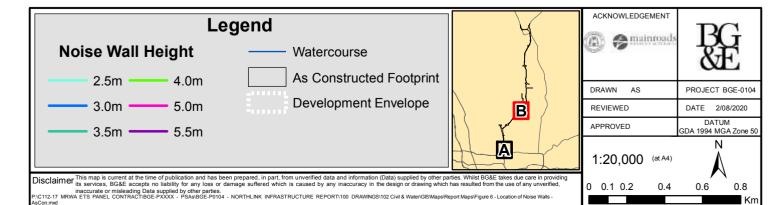

4 **REFERENCES**

BG&E 2015. Drainage Strategy. NorthLink WA Perth Darwin National Highway. May. Report prepared for NorthLink WA by BG&E Pty Limited.



5 NON-COMPLIANCES

Appendix B shows where construction (Clearance Footprint) has occurred outside the Development Envelope. There are ninety-four locations where the Clearance Footprint is outside the Development Envelope. An analysis of these ninety-four locations show that the vast majority (90) are minor discrepancies, most likely due to differences between desktop survey that established the Development Envelope and the ground survey undertaken by surveyors.

There are four locations where works have occurred outside the Development Envelope that is not associated with errors in spatial data. These four areas are listed as follows:

- Area 14 works required to tie in with new works on Hepburn Avenue. No clearing of native vegetation occurred.
- Area 18 and 20 works required on Gnangara Road to remove the signalised intersection and also to slightly realign Gnangara Road to the west of Tonkin Highway. No clearing of native vegetation occurred.
- Area 91 works required along the original Brand Highway in order to tie the new works into the existing road. No clearing of native vegetation occurred.

This information was submitted to Department of Water and Environment (DWER) on 15 June 2020. Response letter from DWER can be found in Appendix C stating that due to the nature of exceedances that occurred, no enforcement action will be taken.



APPENDIX A

Bridge Drawings

GENERAL		DRAWING DESCRIPTION	<u>DRAWING NUMBER</u>	<u>MRWA DRAWING No.</u>	DRAWING DESCRIPTION
	1830-0804	LOCALITY PLAN	NL2-AAJ-DRG-0155-BR-0120	1830-0837	BRIDGE PRIVACY SCREEN WALL DETAILS - SHEET 1
NL2-AAJ-DRG-0155-BR-0002	1830-0805	INDEX	NL2-AAJ-DRG-0155-BR-0121	1830-0838	BRIDGE PRIVACY SCREEN WALL DETAILS - SHEET 2
	690-0601		NL2-AAJ-DRG-0155-BR-0122	1830-0839	BRIDGE PRIVACY SCREEN WALL DETAILS – SHEET 3
NL2-AAJ-DRG-0155-BR-0005	1830-0806	GENERAL NOTES – SHEET 1	NL2-AAJ-DRG-0155-BR-0123	1830-0840	BRIDGE APPROACH PRIVACY SCREEN WALL AND DETAILS
NL2-AAJ-DRG-0155-BR-0006	1830-0807	GENERAL NOTES - SHEET 2	NL2-AAJ-DRG-0155-BR-0124	1830-0841	BRIDGE APPROACH PRIVACY SCREEN WALL AND DETAILS
	1020-0007	ULNERAL NOTES - SHELT 2	NL2-AAJ-DRG-0155-BR-0125	1830-0842	BALUSTRADE LAYOUT AND DETAILS
NL2-AAJ-DRG-0155-BR-0008	1830-0808	STRUCTURES LOCALITY PLAN	NL2-AAJ-DRG-0155-BR-0135	1830-0843	SERVICES AND LIGHTING CONNECTION DETAILS
			NL2-AAJ-DRG-0155-BR-0136	1830-0844	UNDER BRIDGE LIGHTING BRACKET DETAILS
NL2-AAJ-DRG-0155-BR-0010	1830-0809	GENERAL ARRANGEMENT - SHEET 1	NC2-AAJ-DKU-V133-DK-V130	1050-0044	ONDER DRIDGE LIGHTING DRACKET DETAILS
NL2-AAJ-DRG-0155-BR-0011	1830-0810	GENERAL ARRANGEMENT - SHEET 2	NL2-AAJ-DRG-0155-BR-0140	1830-0845	EARTHING AND DEBONDING DETAILS - SHEET 1
			NL2-AAJ-DRG-0155-BR-0141	1830-0846	EARTHING AND DEBONDING DETAILS - SHEET 2
SUBSTRUCTURE			NL2-AAJ-DRG-0155-BR-0142		FUTURE PIER WALL EARTHING AND DEBONDING DETAILS
NL2-AAJ-DRG-0155-BR-0015	1830-0811	BORE INFORMATION		1830-0847	FOTORE FIER WALL EARTHING AND DEDUNDING DETAILS
NL2-AAJ-DRG-0155-BR-0017	1830-0812	GEOMETRIC DATA	NL2-AAJ-DRG-0155-BR-0145	1830-0848	FUTURE ELECTRIFICATION PROTECTION SCREEN DETAILS
			NL2-AAJ-DRG-0155-BR-0146	1830-0849	FUTURE ELECTRIFICATION PROTECTION SCREEN DETAILS
NL2-AAJ-DRG-0155-BR-0020	1830-0813	ABUTMENT No. 1 – CONCRETE ARRANGEMENT	NL2-AAJ-DRG-0155-BR-0147	1830-0850	FUTURE ELECTRIFICATION PROTECTION SCREEN DETAILS
NL2-AAJ-DRG-0155-BR-0021	1830-0814	ABUTMENT N₀. 2 - CONCRETE ARRANGEMENT			
NL2-AAJ-DRG-0155-BR-0022	1830-0815	ABUTMENT - CONCRETE DETAILS	NL2-AAJ-DRG-0155-BR-0160	1830-0851	STAIR No.1 - PLAN AND DETAILS
			NL2-AAJ-DRG-0155-BR-0161	1830-0852	STAIR No. 2 - PLAN AND DETAILS
NL2-AAJ-DRG-0155-BR-0024	1830-0816	COLUMN FORMER DETAILS	NL2-AAJ-DRG-0155-BR-0162	1830-0853	STAIR DETAILS – SHEET 1
			NL2-AAJ-DRG-0155-BR-0163	1830-0854	STAIR DETAILS - SHEET 2
NL2-AAJ-DRG-0155-BR-0030	1830-0817	ABUTMENT REINFORCEMENT DETAILS – SHEET 1	NL2-AAJ-DRG-0155-BR-0164	1830-0855	STAIR DETAILS – SHEET 3
NL2-AAJ-DRG-0155-BR-0031	1830-0818	ABUTMENT REINFORCEMENT DETAILS – SHEET 2	NL2-AAJ-DRG-0155-BR-0165	1830-0856	STAIR DETAILS – SHEET 4
NL2-AAJ-DRG-0155-BR-0032	1830-0819	COLUMN REINFORCEMENT DETAILS			
			NL2-AAJ-DRG-0155-BR-0170	1830-0857	LIMESTONE RETAINING WALL (MW25) – SHEET 1
NL2-AAJ-DRG-0155-BR-0035	1830-0820	PIER CONCRETE DETAILS	NL2-AAJ-DRG-0155-BR-0171	1830-0858	LIMESTONE RETAINING WALL (MW25) – SHEET 2
NL2-AAJ-DRG-0155-BR-0036	1830-0821	SCREW PILE LAYOUT	NL2-AAJ-DRG-0155-BR-0172	1830-0859	LIMESTONE RETAINING WALL (MW25) – SHEET 3
NL2-AAJ-DRG-0155-BR-0037	1830-0822	SCREW PILE DETAILS	NL2-AAJ-DRG-0155-BR-0173	1830-0860	LIMESTONE RETAINING WALL TYPICAL SECTION - SHEET 1
NL2-AAJ-DRG-0155-BR-0038	1830-0823	PIER REINFORCEMENT DETAILS - SHEET 1	NL2-AAJ-DRG-0155-BR-0174	1830-0861	LIMESTONE RETAINING WALL TYPICAL SECTION - SHEET 2
NL2-AAJ-DRG-0155-BR-0039	1830-0824	PIER REINFORCEMENT DETAILS - SHEET 2	NL2-AAJ-DRG-0155-BR-0175	1830-0862	ABUTMENT No. 1 – MSE RETAINING WALL LAYOUT – SHEET
			NL2-AAJ-DRG-0155-BR-0180	1830-0863	ABUTMENT No. 2 - MSE RETAINING WALL LAYOUT - SHEET
NL2-AAJ-DRG-0155-BR-0040	1830-0825	FUTURE PIER WALL - CONCRETE DETAILS	NL2-AAJ-DRG-0155-BR-0181	1830-0864	ABUTMENT No. 2 - MSE RETAINING WALL LAYOUT - SHEET
NL2-AAJ-DRG-0155-BR-0041	1830-0826	FUTURE PIER WALL - REINFORCEMENT DETAILS	NL2-AAJ-DRG-0155-BR-0182	1830-0865	ABUTHENT NO. 2 - MSE RETAINING WALL LAYOUT - SHEET
			NL2-AAJ-DRG-0155-BR-0183	1830-0866	ABUTMENT No. 2 - MSE RETAINING WALL LAYOUT - SHEET ABUTMENT No. 2 - MSE RETAINING WALL LAYOUT - SHEET
SUPERSTRUCTURE					
NL2-AAJ-DRG-0155-BR-0045	1830-0827	BEARING DETAILS - SHEET 1	NL2-AAJ-DRG-0155-BR-0185	1830-0867	MSE RETAINING WALL (MW26) LAYOUT – SHEET 1
NL2-AAJ-DRG-0155-BR-0046	1830-0828	BEARING DETAILS - SHEET 2	NL2-AAJ-DRG-0155-BR-0186	1830-0868	MSE RETAINING WALL (MW26) LAYOUT – SHEET 2
			NL2-AAJ-DRG-0155-BR-0187	1830-0869	MSE RETAINING WALL (MW26) LAYOUT – SHEET 3
NL2-AAJ-DRG-0155-BR-0050	1830-0829	PRECAST BEAM LAYOUT & DETAILS - SHEET 1	NL2-AAJ-DRG-0155-BR-0188	1830-0870	MSE RETAINING WALL (MW26) LAYOUT – SHEET 4
NL2-AAJ-DRG-0155-BR-0051	1830-0830	PRECAST BEAM LAYOUT & DETAILS - SHEET 2			
NL2-AAJ-DRG-0155-BR-0052	1830-0831	PRECAST BEAM LAYOUT & DETAILS - SHEET 3	NL2-AAJ-DRG-0155-BR-0190	1830-0871	MSE RETAINING WALL TYPICAL SECTION - SHEET 1
NL2-AAJ-DRG-0155-BR-0053	1830-0832	PRECAST BEAM PRESTRESSING DETAILS	NL2-AAJ-DRG-0155-BR-0191	1830-0872	MSE RETAINING WALL TYPICAL SECTION - SHEET 2
			NL2-AA J-DRG-0155-BR-0192	1830-0873	MSE RETAINING WALL TYPICAL SECTION – SHEET 3
NL2-AAJ-DRG-0155-BR-0060	1830-0833	PRECAST BEAM - REINFORCEMENT DETAILS - SHEET 1			
NL2-AAJ-DRG-0155-BR-0061	1830-0834	PRECAST BEAM - REINFORCEMENT DETAILS - SHEET 2	MRWA STANDARD		
NL2-AAJ-DRG-0155-BR-0062	1830-0835	LINK SLAB CONCRETE AND REINFORCEMENT DETAILS	DRAWINGS	0630-1901	BRIDGE LIGHT POLE BASE - SHEET 1
NL2-AAJ-DRG-0155-BR-0100	1830-0836	EXPANSION JOINT DETAILS		0630-1902	BRIDGE LIGHT POLE BASE - SHEET T
	050-050				
S DRAWING IS AN AMENDM ROVED DRAWING. M	ENT OF THE . Kakulas				
			DRAWN J. BUI 30.08.17	CONSTRUCTOR	
	GROUND SURVEY	STANDARD.	DESIGNED J. NGUI 30.08.17		

AS CONSTRUCTED - NO CHANGES ISSUED FOR CONSTRUCTION

DESCRIPTION

AMENDMENTS

MAPPING SURVEY STANDARD: MAPPING SURVET STA

AHD

HEIGHT DATUM:

AAJV Add Overlass Services ACCOM and Arranks to Design ACCOM ARCADIS DESIGN MANAGER D. SULLIVAN

28.02.18 DATE IFC


DESIGNED J. NGUI CHECKED P. DOBSON APPROVED M. KAKULAS 30.08.17 DRAWING STATUS

RIFIED L. TINLIN DATE 07.03.18




ALL DETAILS - SHEET 1	
ALL DETAILS – SHEET 2 ALL DETAILS – SHEET 3	
SCREEN WALL AND DETAILS - SHEET 1	
SCREEN WALL AND DETAILS - SHEET 2	
DETAILS	
INECTION DETAILS	
ACKET DETAILS	
DETAILS – SHEET 1 DETAILS – SHEET 2	
IG AND DEBONDING DETAILS	
ROTECTION SCREEN DETAILS	
OTECTION SCREEN DETAILS	
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TAILS	
(MW25) – SHEET 1	
(MW25) - SHEET 2	
(MW25) - SHEET 3	
TYPICAL SECTION - SHEET 1	
TYPICAL SECTION - SHEET 2	
NINING WALL LAYOUT - SHEET 1	
AINING WALL LAYOUT - SHEET 1	
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SHEET 1	
SHEET 2	
	AS CONSTRUCTED
	<u>DATE 31/01/19</u>
	LOCAL AUTHORITY (109) CITY OF SWAN MAN ROADS RESPONSELITY AREA (109) CITY OF SWAN
western AUSTRALIA	MOZET THE NORTHLINK WA CENTRAL SECTION
	DRANNIG TITLE TONKIN HIGHWAY (H017) PEDESTRIAN FOOTBRIDGE No. 9122A
INFRASIRUCIURE DELIVERY DIRECTORATE	
iegt ctor R. ARNOTT 15.03.18 date	NL2-AAJ-DRG-0155-BR-0002 T

NOTE: ALL DRAWINGS ARE CONSIDERED UNCONTROLLED UNLESS STAMPED 'CONTROLLED COPY' IN RED

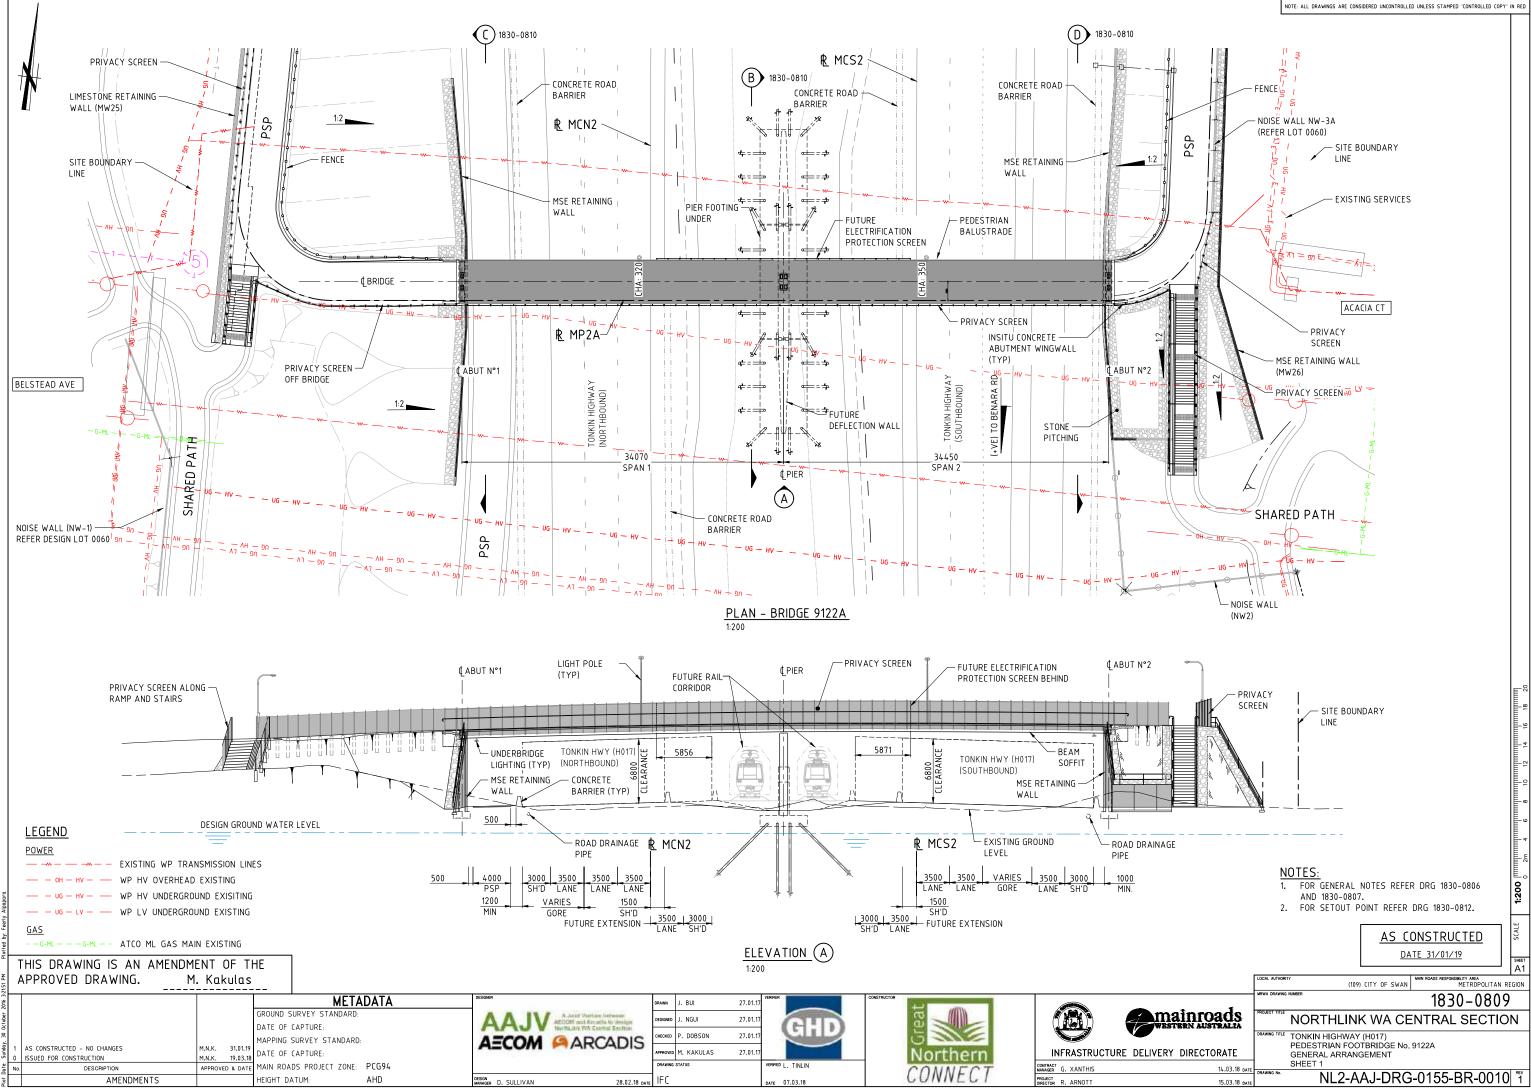



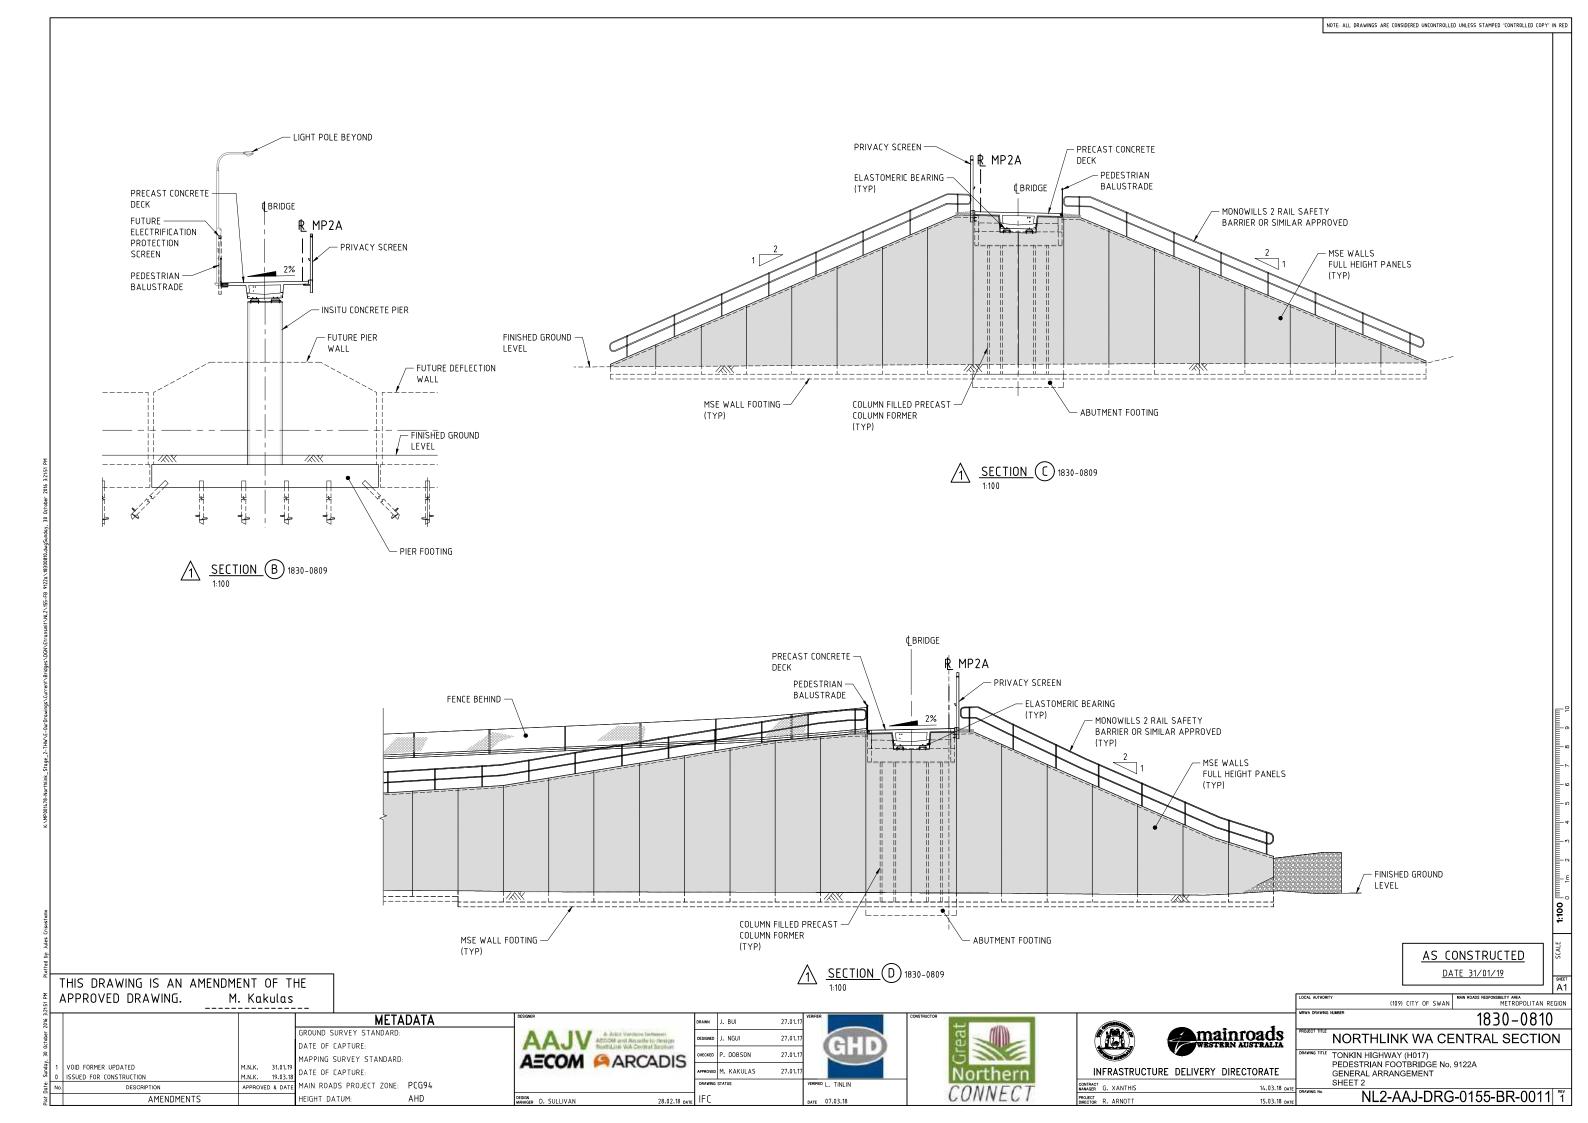


PROJECT DRG No.	MRWA DRG No.	DRAWING TITLE	PROJECT DRG No.	MRWA DRG No.	DRAWING TITLE
	<u></u>	<u></u>			
GENERAL			NL2–AA J–DRG–0100–BR–0057 NL2–AA J–DRG–0100–BR–0058	1830-0458 1830-0459	PRECAST TEEROFF - PRESTRESSING DETAILS - SHEET 1 PRECAST TEEROFF - PRESTRESSING DETAILS - SHEET 2
NL2-AAJ-DRG-0100-BR-0001	1830-0421	LOCALITY PLAN		10-04-07	
NL2-AAJ-DRG-0100-BR-0002	1830-0422	INDEX	NL2-AAJ-DRG-0100-BR-0060	1830-0460	PRECAST TEEROFF - REINFORCEMENT DETAILS - SHEET 1
			NL2-AAJ-DRG-0100-BR-0061	1830-0461	PRECAST TEEROFF - REINFORCEMENT DETAILS - SHEET 7
NL2-AAJ-DRG-0100-BR-0005	1830-0423	GENERAL NOTES - SHEET 1	NL2-AAJ-DRG-0100-BR-0062	1830-0462	PRECAST TEEROFF - REINFORCEMENT DETAILS - SHEET 3
NL2-AAJ-DRG-0100-BR-0006	1830-0424	GENERAL NOTES - SHEET 2	NL2-AAJ-DRG-0100-BR-0063	1830-0463	PRECAST TEEROFF - REINFORCEMENT DETAILS - SHEET 4
NL2-AAJ-DRG-0100-BR-0010	1830-0425	GENERAL ARRANGEMENT – SHEET 1			
NL2-AAJ-DRG-0100-BR-0010	1830-0425	GENERAL ARRANGEMENT - SHEET T	NL2-AAJ-DRG-0100-BR-0070	1830-0464	DECK CONCRETE DETAILS – SHEET 1
NL2-AAJ-DRG-0100-BR-0012	1830-0427	GENERAL ARRANGEMENT - SHEET 3	NL2-AAJ-DRG-0100-BR-0071	1830-0465	DECK CONCRETE DETAILS - SHEET 2
	1050-0427	GENERAL ARRANGENENT - SHELTS	NL2-AAJ-DRG-0100-BR-0072	1830-0466	DECK CONCRETE DETAILS - SHEET 3
			NL2-AAJ-DRG-0100-BR-0073	1830-0467	DECK REINFORCEMENT DETAILS - SHEET 1
SUBSTRUCTURE			NL2-AAJ-DRG-0100-BR-0074	1830-0468	DECK REINFORCEMENT DETAILS - SHEET 2
NL2-AAJ-DRG-0100-BR-0015	1830-0428	BORE INFORMATION - SHEET 1	NL2-AAJ-DRG-0100-BR-0075	1830-0469	DIAPHRAGM DETAILS
NL2-AAJ-DRG-0100-BR-0016	1830-0429	BORE INFORMATION – SHEET 2	NL2-AAJ-DRG-0100-BR-0076	1830-0470	CONTINUITY STITCH REINFORCEMENT DETAILS
NL2-AAJ-DRG-0100-BR-0017	1830-0430	GEOMETRIC DATA			
			NL2-AAJ-DRG-0100-BR-0090	1830-0471	APPROACH SLAB CONCRETE DETAILS
NL2-AAJ-DRG-0100-BR-0020	1830-0431	ABUTMENT - MSE WALL LAYOUT	NL2-AAJ-DRG-0100-BR-0091	1830-0472	APPROACH SLAB REINFORCEMENT DETAILS
NL2-AAJ-DRG-0100-BR-0021	1830-0432	ABUTMENT No.1 - MSE WALL	NL2-AAJ-DRG-0100-BR-0100	1830-0473	EXPANSION JOINT DETAILS
NL2-AAJ-DRG-0100-BR-0022	1830-0433	ABUTMENT No. 2 - MSE WALL	NL2-AAJ-DRG-0100-BR-0105	1830-0474	COVER PLATE DETAILS - SHEET 1
NL2-AAJ-DRG-0100-BR-0023	1830-0434		NL2-AAJ-DRG-0100-BR-0106	1830-0475	COVER PLATE DETAILS - SHEET 2
NL2-AAJ-DRG-0100-BR-0024	1830-0435				
NL2-AAJ-DRG-0100-BR-0025 NL2-AAJ-DRG-0100-BR-0026	1830-0436	ABUTMENT No.1 - CONCRETE DETAILS ABUTMENT No. 2 - CONCRETE DETAILS	NL2-AAJ-DRG-0100-BR-0110	1830-0476	BARRIER LAYOUT
	1830-0437		NL2-AAJ-DRG-0100-BR-0111	1830-0477	PRECAST BARRIER CONCRETE DETAILS
NL2-AAJ-DRG-0100-BR-0027 NL2-AAJ-DRG-0100-BR-0028	1830-0438 1830-0439	ABUTMENT – TYPICAL CONCRETE DETAILS WING WALL DETAILS	NL2-AAJ-DRG-0100-BR-0112	1830-0478	BARRIER CONNECTION DETAILS
NL2-AAJ-DRG-0100-BR-0029	1830-0440				
	1030-0440	WING WALL REINFORCEMENT DETAILS	NL2-AAJ-DRG-0100-BR-0115	1830-0479	BARRIER DETAILS
NL2-AAJ-DRG-0100-BR-0030	1830-0441	ABUTMENT - REINFORCEMENT DETAILS - SHEET 1	NL2-AAJ-DRG-0100-BR-0116	1830-0480	BARRIER TRANSITION DETAILS – SHEET 1
NL2-AAJ-DRG-0100-BR-0031	1830-0442	ABUTMENT - REINFORCEMENT DETAILS - SHEET 2	NL2-AAJ-DRG-0100-BR-0117	1830-0481	BARRIER TRANSITION DETAILS – SHEET 2
NL2-AAJ-DRG-0100-BR-0032	1830-0443	ABUTMENT - REINFORCEMENT DETAILS - SHEET 3			
NL2-AAJ-DRG-0100-BR-0033	1830-0444	COLUMN REINFORCEMENT DETAILS	NL2-AAJ-DRG-0100-BR-0135	1830-0482	
			NL2-AAJ-DRG-0100-BR-0136	1830-0483	
NL2-AAJ-DRG-0100-BR-0035	1830-0445	PIER – CONCRETE DETAILS – SHEET 1	NL2-AAJ-DRG-0100-BR-0137	1830-0484	
NL2-AAJ-DRG-0100-BR-0036	1830-0446	PIER - CONCRETE DETAILS - SHEET 2	NL2-AAJ-DRG-0100-BR-0138	1830-0485	LIGHTING POLE TO BARRIER BRACKET DETAILS
NL2-AAJ-DRG-0100-BR-0037	1830-0447	PIER – REINFORCEMENT DETAILS – SHEET 1	NL2-AAJ-DRG-0100-BR-0139	1830-0486	LUMINAIRE BRACKET DETAILS
NL2-AAJ-DRG-0100-BR-0038	1830-0448	PIER - REINFORCEMENT DETAILS - SHEET 2	NL2-AAJ-DRG-0100-BR-0140	1830-0487	EARTHING & BONDING DETAILS - SHEET 1
			NL2-AAJ-DRG-0100-BR-0140	1830-0488	EARTHING & BONDING DETAILS - SHEET 2
NL2-AAJ-DRG-0100-BR-0040	1830-0449	FUTURE PIER WALL DETAILS - SHEET 1	NL2-AAJ-DRG-0100-BR-0141	1830-0489	EARTHING & BONDING DETAILS - SHEET 2
NL2-AAJ-DRG-0100-BR-0041	1830-0450	FUTURE PIER WALL DETAILS - SHEET 2	NL2-AAJ-DRG-0100-BR-0145	1830-0490	ELECTRIFICATION PROTECTION SCREEN DETAILS - SHEET 1
			NL2-AAJ-DRG-0100-BR-0146	1830-0491	ELECTRIFICATION PROTECTION SCREEN DETAILS - SHEET 1
SUPERSTRUCTURE				1050-0471	
NL2-AAJ-DRG-0100-BR-0045	1830-0451	BEARING DETAILS - SHEET 1	NL2-AAJ-DRG-0100-BR-0155	1830-0492	DESIGN SUMMARY SHEET - SHEET 1
NL2-AAJ-DRG-0100-BR-0046	1830-0452	BEARING DETAILS - SHEET 2	NL2-AAJ-DRG-0100-BR-0156	1830-0493	DESIGN SUMMARY SHEET – SHEET 2
NL2-AAJ-DRG-0100-BR-0047	1830-0453	BEARING DETAILS – SHEET 3			
			MRWA STANDARD		
NL2-AAJ-DRG-0100-BR-0050	1830-0454	PRECAST TEEROFF BEAMS LAYOUT	DRAWINGS		
			_	0530-1457-3	ROAD-SIDE SLIP-BASE AND BRIDGE MOUNTED OCTAGONAL LIGH POLE DETAILS - SHEET 2
NL2-AAJ-DRG-0100-BR-0052	1830-0455	PRECAST TEEROFF BEAM TYPICAL DETAILS	_	0630-1902	BRIDGE LIGHT POLE BASE – SHEET 2
NL2-AAJ-DRG-0100-BR-0053	1830-0456	PRECAST TEEROFF - CONCRETE DETAILS - SHEET 1			
NL2-AAJ-DRG-0100-BR-0054	1830-0457	PRECAST TEEROFF - CONCRETE DETAILS - SHEET 2			


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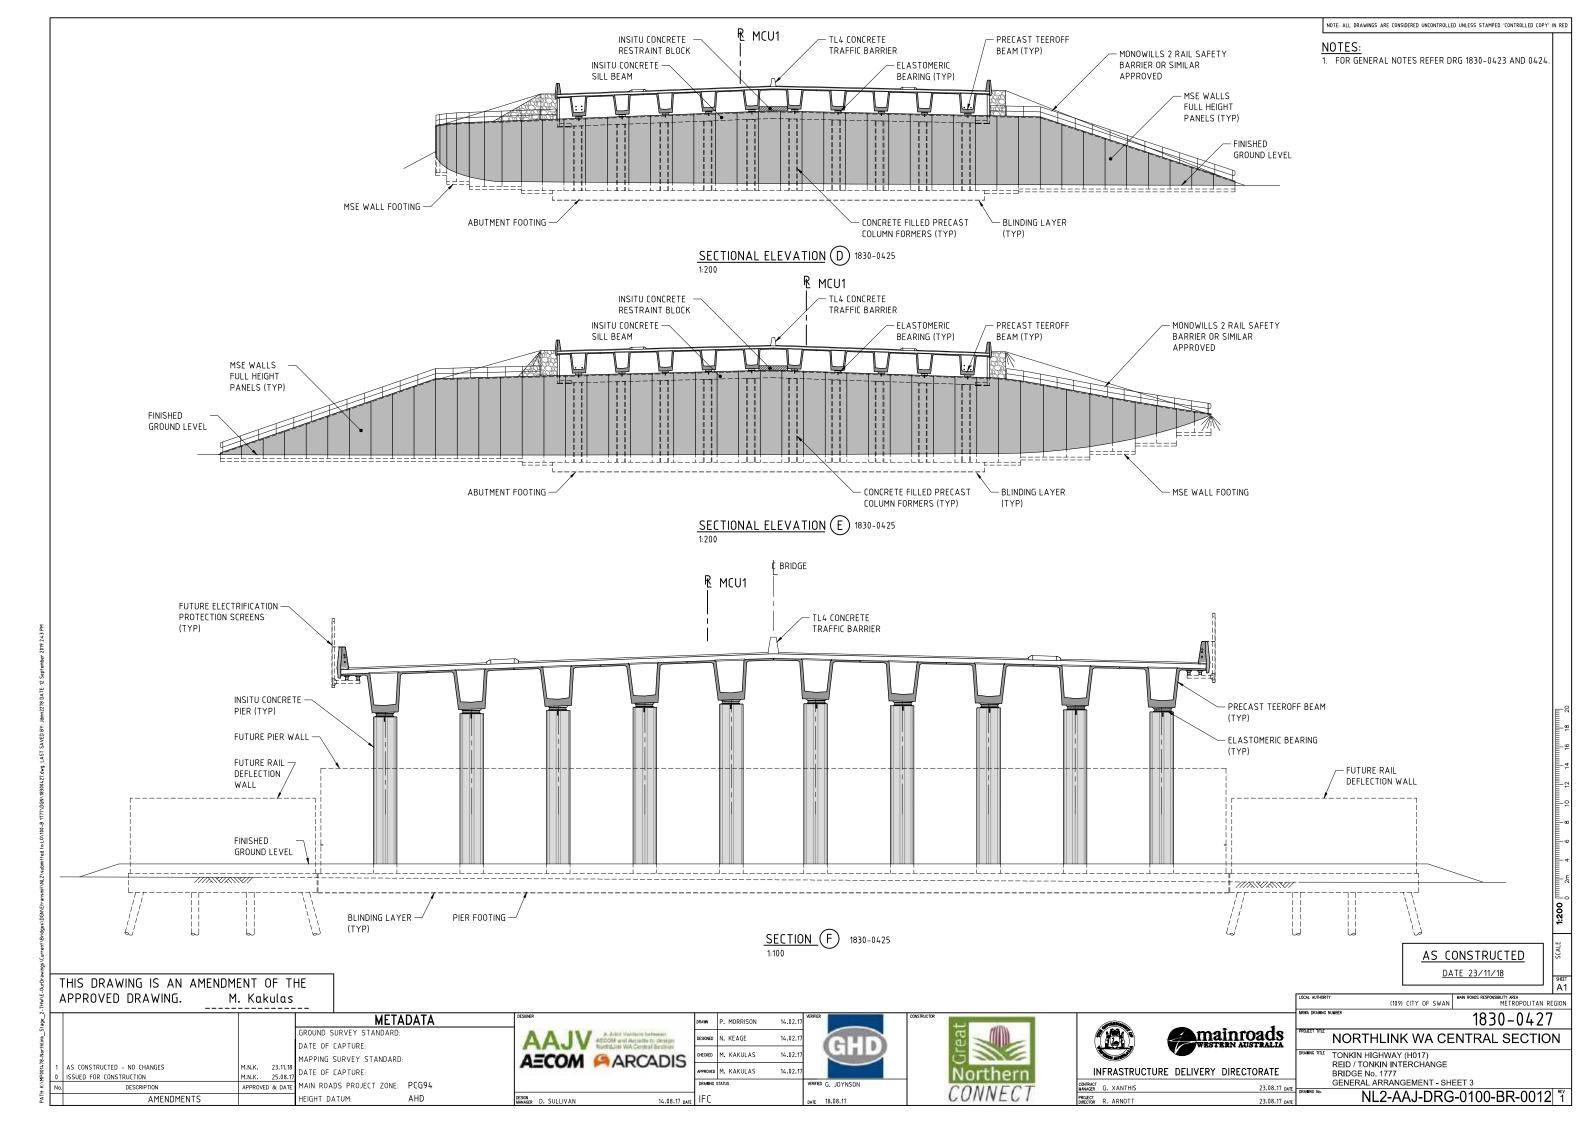
Our	THIS DRAWING IS AN AMENDM												
-THW\E-	APPROVED DRAWING. M	1. Kakulas											
tage_2				DATA	DESIGNER	DRAWN	F. ALPAPARA	26.05.17	VERIFIER	CONSTRUCTOR			_
link_S			GROUND SURVEY STANDARD: DATE OF CAPTURE:		AALV ACOM and Amerille to design	DESIGNED	N. KEAGE	26.05.17	CHID		E S		
8-Norti			MAPPING SURVEY STANDARD		AECOM ARCADI	CHECKED	M. KAKULAS	26.05.17	CITE				
1100	1 AS CONSTRUCTED - NO CHANGES	M.N.K. 23.11.18			AECOM MARCADI	APPROVED	M. KAKULAS	26.05.17			Northern	INFRASTRUCT	JRE DELIVER
- S -	ISSUED FOR CONSTRUCTION	MI.N.K. 25.08.17		0000		DRAWING	TATUS		VERIFIED G. JOYNSON		Northern		
ж ж	No. DESCRIPTION	APPROVED & DATE	MAIN ROADS PROJECT ZONE:	PC094		Dionano -			Lance G. JOTNSON		CONNECT	CONTRACT MANAGER G. XANTHIS	
PAT	AMENDMENTS		HEIGHT DATUM:	AHD	DESIGN MANAGER D. SULLIVAN 14.08.1	7 date IFC			DATE 18.08.17		CONNECT	PROJECT DIRECTOR R. ARNOTT	

Т		
	AS CONSTRUCTED	-
	LOCAL AUTHORITY (109) CITY OF SWAN MAN ROADS RESPONSEDLITY AREA METROPOLITAN REGIO	1
mainroads	1830-0422 RECET THE NORTHLINK WA CENTRAL SECTION BRANNIG TITLE TONKIN HIGHWAY (H017)	
VERY DIRECTORATE 23.08.17 DATE 23.08.17 DATE	REID / TONKIN INTERCHANGE BRIDGE No. 1777 INDEX	

NOTE: ALL DRAWINGS ARE CONSIDERED UNCONTROLLED UNLESS STAMPED 'CONTROLLED COPY' IN RED



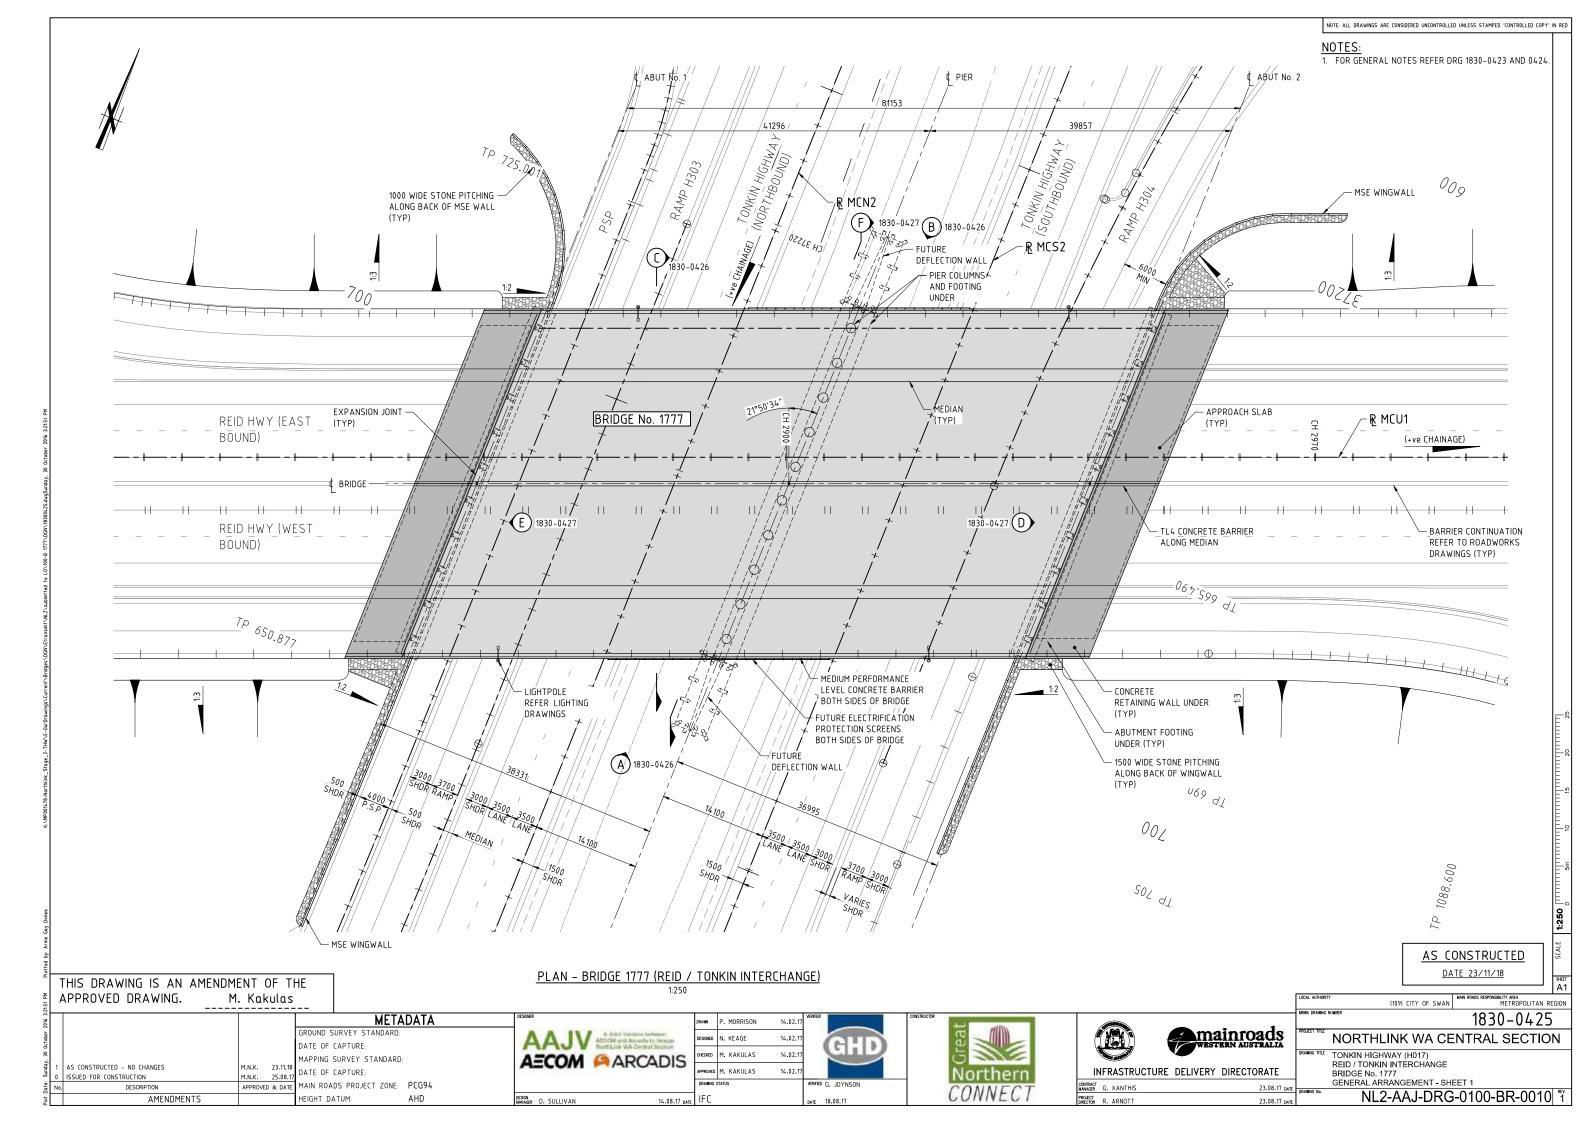

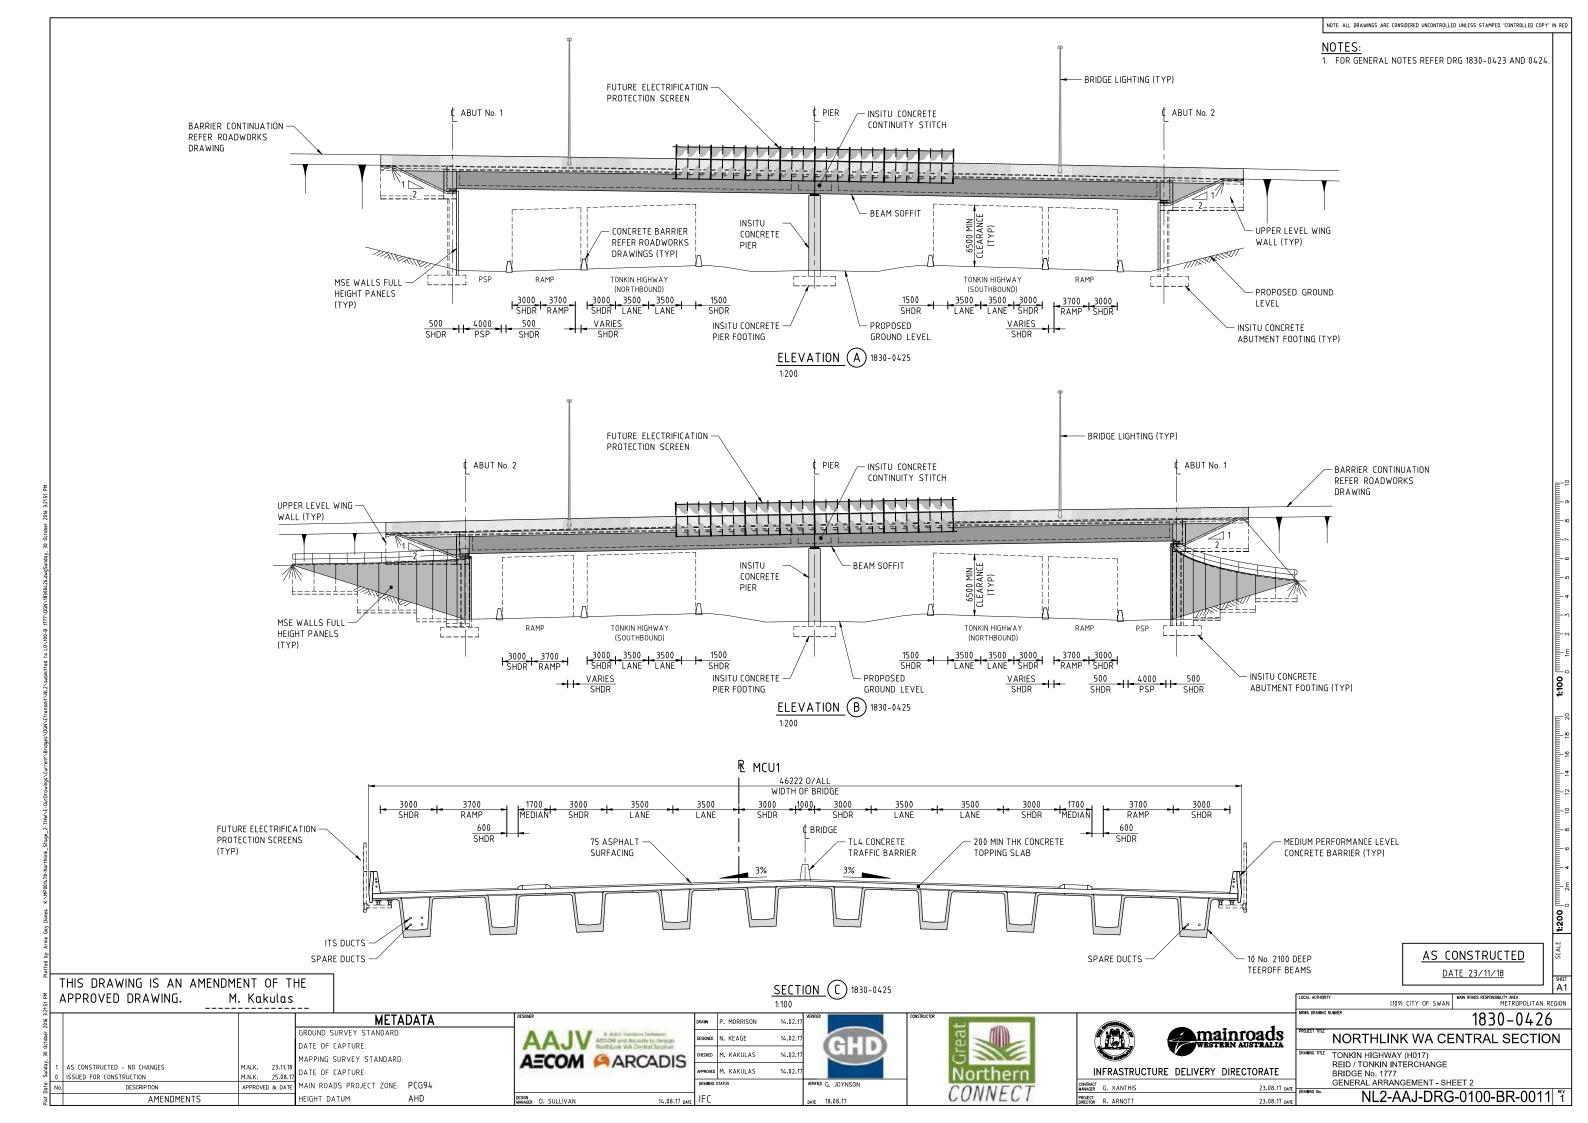

DRAWING INDEX DRAWING NUMBER	MRWA DRG No.	DRAWING DESCRIPTION	DRAWING NUMBER	MRWA DRG No.	DRAWING DESCRIPTION
GENERAL				1830-0528	PRECAST TEEROFF - PRESTRESSING DETAILS - SHEET 1
	1030 0105		NL2-AAJ-DRG-0110-BR-0058	1830-0529	PRECAST TEEROFF - PRESTRESSING DETAILS - SHEET 2
NL2-AAJ-DRG-0110-BR-0001	1830-0495	LOCALITY PLAN	NL2-AAJ-DRG-0110-BR-0059	1830-0530	PRECAST TEEROFF - PRESTRESSING DETAILS - SHEET 3
NL2-AAJ-DRG-0110-BR-0002	1830-0496	INDEX			
NL2-AAJ-DRG-0110-BR-0005	1830-0497	GENERAL NOTES – SHEET 1	NL2-AAJ-DRG-0110-BR-0060	1830-0531	PRECAST TEEROFF - REINFORCEMENT DETAILS - SHEET
	1830-0497	GENERAL NOTES - SHEET T	NL2-AAJ-DRG-0110-BR-0061	1830-0532	PRECAST TEEROFF - REINFORCEMENT DETAILS - SHEET
NL2-AAJ-DRG-0110-BR-0006	1030-0490	GENERAL NOTES - SHEET Z	NL2-AAJ-DRG-0110-BR-0062	1830-0533	PRECAST TEEROFF - REINFORCEMENT DETAILS - SHEET
NL2-AAJ-DRG-0110-BR-0010	1830-0499	GENERAL ARRANGEMENT – SHEET 1	NL2-AAJ-DRG-0110-BR-0063	1830-0534	PRECAST TEEROFF - REINFORCEMENT DETAILS - SHEET
NL2-AAJ-DRG-0110-BR-0010	1830-0500	GENERAL ARRANGEMENT – SHEET 2			
NL2-AAJ-DRG-0110-BR-0012	1830-0501	GENERAL ARRANGEMENT - SHEET 3	NL2-AAJ-DRG-0110-BR-0070	1830-0535	DECK CONCRETE DETAILS - SHEET 1
	1050-0501	GENERAL ARRANGENENT - SHEET S	NL2-AAJ-DRG-0110-BR-0071	1830-0536	DECK CONCRETE DETAILS - SHEET 2
			NL2-AAJ-DRG-0110-BR-0072	1830-0537	DECK CONCRETE DETAILS - SHEET 3
SUBSTRUCTURES			NL2-AAJ-DRG-0110-BR-0073	1830-0538	DECK REINFORCEMENT DETAILS - SHEET 1
NL2-AAJ-DRG-0110-BR-0015	1830-0502	BORE INFORMATION - SHEET 1	NL2-AAJ-DRG-0110-BR-0074	1830-0539	DECK REINFORCEMENT DETAILS - SHEET 2
NL2-AAJ-DRG-0110-BR-0016	1830-0503	BORE INFORMATION - SHEET 2	NL2-AAJ-DRG-0110-BR-0075	1830-0540	DECK REINFORCEMENT DETAILS - SHEET 3
NL2-AAJ-DRG-0110-BR-0017	1830-0504	GEOMETRIC DATA - SHEET 1	NL2-AAJ-DRG-0110-BR-0076	1830-0541	CONTINUITY STITCH REINFORCEMENT DETAILS
NL2-AAJ-DRG-0110-BR-0020	1830-0505	ABUTMENT – MSE WALL LAYOUT	NL2-AAJ-DRG-0110-BR-0090	1830-0542	APPROACH SLAB CONCRETE DETAILS
NL2-AAJ-DRG-0110-BR-0021	1830-0506	ABUTMENT – MSE WALL – SHEET 1	NL2-AAJ-DRG-0110-BR-0091	1830-0543	APPROACH SLAB REINFORCEMENT DETAILS
NL2-AAJ-DRG-0110-BR-0022	1830-0507	ABUTMENT – MSE WALL – SHEET 2			
NL2-AAJ-DRG-0110-BR-0023	1830-0508	ABUTMENT - MSE WALL - TYPICAL DETAILS	NL2-AAJ-DRG-0110-BR-0100	1830-0544	EXPANSION JOINT DETAILS
NL2-AAJ-DRG-0110-BR-0024	1830-0509	ABUTMENT No. 1 - CONCRETE DETAILS			
NL2-AAJ-DRG-0110-BR-0025	1830-0510	ABUTMENT No. 2 - CONCRETE DETAILS	NL2-AAJ-DRG-0110-BR-0105	1830-0545	COVER PLATE DETAILS - SHEET 1
NL2-AAJ-DRG-0110-BR-0026	1830-0511	ABUTMENT - TYPICAL CONCRETE DETAILS	NL2-AAJ-DRG-0110-BR-0106	1830-0546	COVER PLATE DETAILS - SHEET 2
NL2-AAJ-DRG-0110-BR-0027	1830-0512	COLUMN FORMER DETAILS			
NL2-AAJ-DRG-0110-BR-0028	1830-0513	ABUTMENT - REINFORCEMENT DETAILS - SHEET 1	NL2-AAJ-DRG-0110-BR-0110	1830-0547	BARRIER LAYOUT
NL2-AAJ-DRG-0110-BR-0029	1830-0514	ABUTMENT - REINFORCEMENT DETAILS - SHEET 2	NL2-AAJ-DRG-0110-BR-0111	1830-0548	PRECAST BARRIER CONCRETE DETAILS
NL2-AAJ-DRG-0110-BR-0030	1830-0515	COLUMN REINFORCEMENT DETAILS	NL2-AAJ-DRG-0110-BR-0112	1830-0549	BARRIER CONNECTION DETAILS
NL2-AAJ-DRG-0110-BR-0032	1830-0516	WING WALL DETAILS	NL2-AAJ-DRG-0110-BR-0115	1830-0550	BARRIER DETAILS
NL2-AAJ-DRG-0110-BR-0033	1830-0517	WING WALL REINFORCEMENT DETAILS	NL2-AAJ-DRG-0110-BR-0116	1830-0551	BARRIER TRANSITION DETAILS – SHEET 1
			NL2-AAJ-DRG-0110-BR-0117	1830-0552	BARRIER TRANSITION DETAILS - SHEET 2
NL2-AAJ-DRG-0110-BR-0035	1830-0518	PIER – CONCRETE DETAILS – SHEET 1			
NL2-AAJ-DRG-0110-BR-0036	1830-0519	PIER - CONCRETE DETAILS - SHEET 2	NL2-AAJ-DRG-0110-BR-0135	1830-0553	LIGHTING AND ELECTRICAL LAYOUT
NL2-AAJ-DRG-0110-BR-0037	1830-0520	PIER – REINFORCEMENT DETAILS – SHEET 1	NL2-AAJ-DRG-0110-BR-0136	1830-0554	LIGHTING AND ELECTRICAL DETAILS
NL2-AAJ-DRG-0110-BR-0038	1830-0521	PIER - REINFORCEMENT DETAILS - SHEET 2	NL2-AAJ-DRG-0110-BR-0137	1830-0555	LIGHT POLE CONTROL BOX DETAILS
			NL2-AAJ-DRG-0110-BR-0138	1830-0556	LIGHTING POLE TO BARRIER BRACKET DETAIL
SUPERSTRUCTURE			NL2-AAJ-DRG-0110-BR-0139	1830-0557	LUMINAIRE BRACKET DETAILS
NL2-AAJ-DRG-0110-BR-0045	1830-0522	BEARING DETAILS – SHEET 1		1020 0000	
NL2-AAJ-DRG-0110-BR-0046	1830-0523	BEARING DETAILS - SHEET 2	NL2-AAJ-DRG-0110-BR-0155	1830-0558	DESIGN SUMMARY SHEET - SHEET 1
NL2-AAJ-DRG-0110-BR-0047	1830-0524	BEARING DETAILS - SHEET 3	NL2-AAJ-DRG-0110-BR-0156	1830-0559	DESIGN SUMMARY SHEET - SHEET 2
NL2-AAJ-DRG-0110-BR-0050	1830-0525	PRECAST TEEROFF BEAM LAYOUT	MRWA STANDARD DRAW	INGS	
NL2-AAJ-DRG-0110-BR-0052	1830-0526	PRECAST TEEROFF - CONCRETE DETAILS - SHEET 1	-	0530-1457-3	ROAD-SIDE SLIP-BASE AND BRIDGE MOUNTED OCTAGONAL LIGHT POLE DETAILS – SHEET 2
	1830 0527			0630-1901	

NL2-AAJ-DRG-0110-BR-0053

1830-0527

PRECAST TEEROFF - CONCRETE DETAILS - SHEET 2

:-THW\E-OurDrawing	THIS DRAWING IS AN AMENDMI APPROVED DRAWING. M	ENT OF T . Kakulas											
_Stage_2			MET GROUND SURVEY STANDARD		DESIGNER	DRAWN	A. HAWTON	11.07.17	VERIFIER	CONSTRUCTOR	at at		A
arthlink			DATE OF CAPTURE:		AAJV ACCOM set Arrests to Device frontiLine WA Central Section		T. SMITH	11.07.17	CED		ě 🔍		WE
001478-N	1 AS CONSTRUCTED - NO CHANGES		MAPPING SURVEY STANDAR DATE OF CAPTURE:	D:	AECOM ARCADIS)	N. KEAGE M. KAKULAS	11.07.17			Northern	INFRASTRUCTU	JRE DELIVER
H: K:/Wb	0 ISSUED FOR CONSTRUCTION No. DESCRIPTION	M.N.K. 01.11.17 APPROVED & DATE	MAIN ROADS PROJECT ZONE	PCG94		DRAWING	STATUS		VERIFIED G. JOYNSON	_	CONNECT	CONTRACT MANAGER G. XANTHIS	
PAT	AMENDMENTS		HEIGHT DATUM:	AHD	DESIGN MANAGER D. SULLIVAN 09.10.17	DATE IFC			date 19.10.17		CUNNELI	PROJECT DIRECTOR R. ARNOTT	

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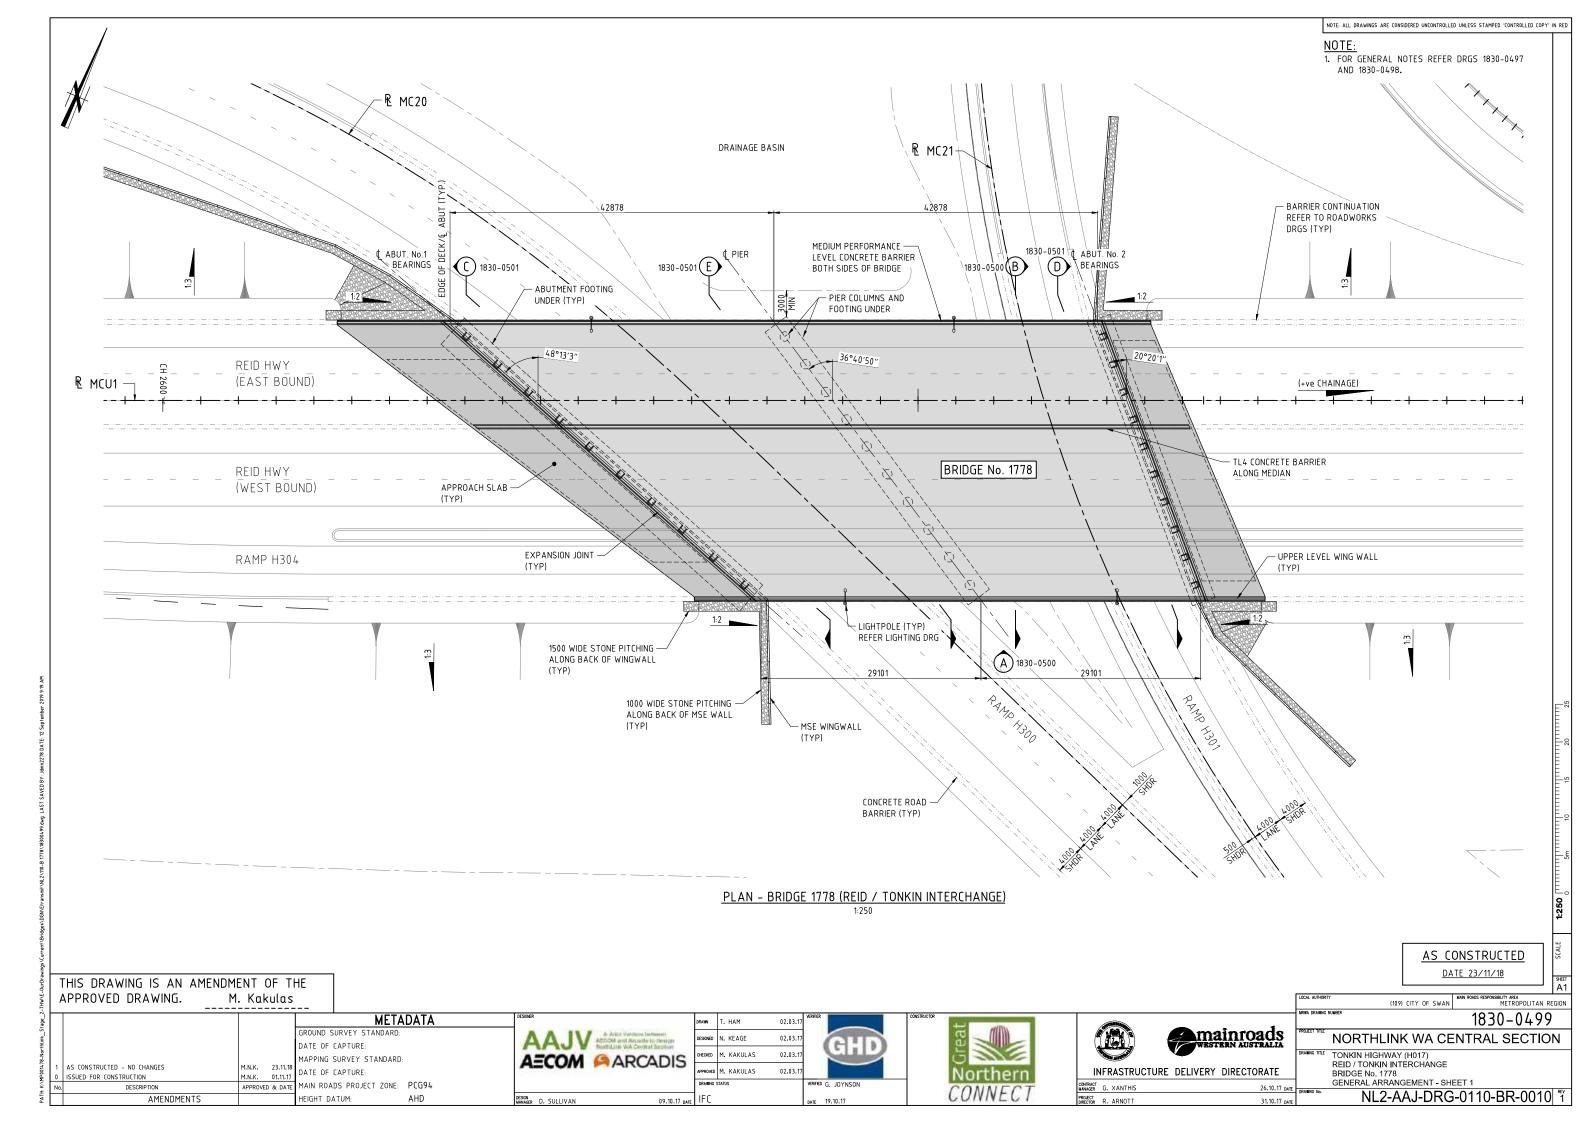
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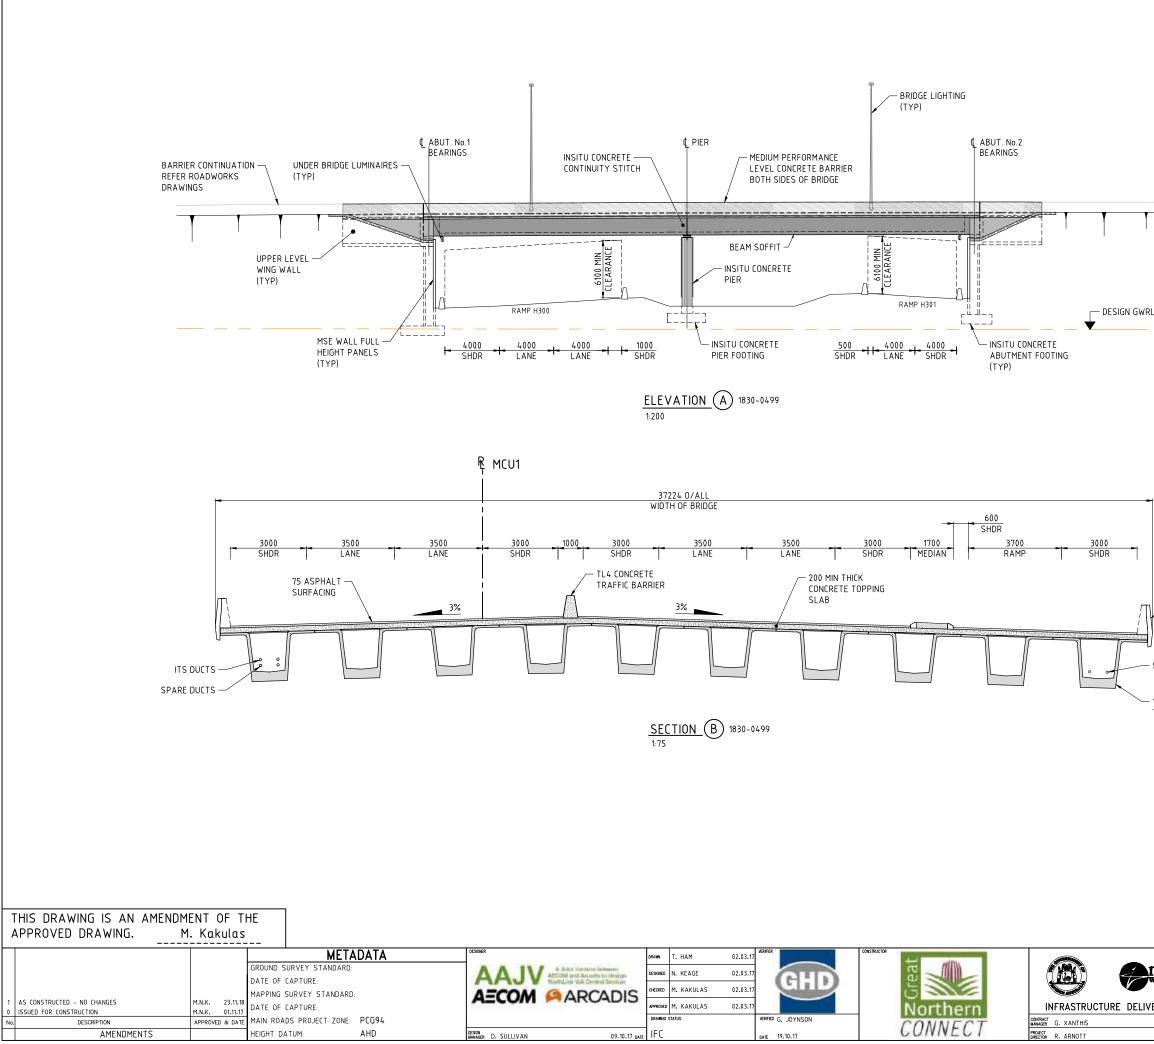
BRIDGE LIGHT POLE BASE - SHEET 1

BRIDGE LIGHT POLE BASE - SHEET 2


	AS CONSTRUCTED	
	DATE 23/11/18	неет А 1
	LOCAL AUTHORYY (109) CITY OF SWAN MEROPOLITAN REGI (109) CITY OF SWAN MEROPOLITAN REGI Merka drawno kuwer	DN
mainroads	HANG LOOKING RANGER 1830-0496 HOUSET THE NORTHLINK WA CENTRAL SECTION	
ELIVERY DIRECTORATE	DRAWING TITLE TONKIN HIGHWAY (H017) REID / TONKIN INTERCHANGE BRIDGE No. 1778 INDEX	
26.10.17 date 31.10.17 date		_{ЕУ} 1

NOTE: ALL DRAWINGS ARE CONSIDERED UNCONTROLLED UNLESS STAMPED 'CONTROLLED COPY' IN RED





		WINGS ARE CONSIDERED	UNCONTROLLE	O UNLESS ST	AMPED CONTROLLED	COPY' IN RED
	NOTES:	GENERAL NOTI	S REFE	R DRGS	1830-0497	
		1830-0498.		(Didd	1050 0477	
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	MRWA DRAWING NUMBER				330-05	
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WDOLDRI' AUSL'XALIA	DRAWING TITLE TONKIN	HIGHWAY (H01 ONKIN INTERC	7)			
VERY DIRECTORATE	BRIDGE	No. 1778 AL ARRANGEMI		FT 2		
26.10.17 date 31.10.17 date		NL2-AAJ			0-BR-00	11 ^{REV}
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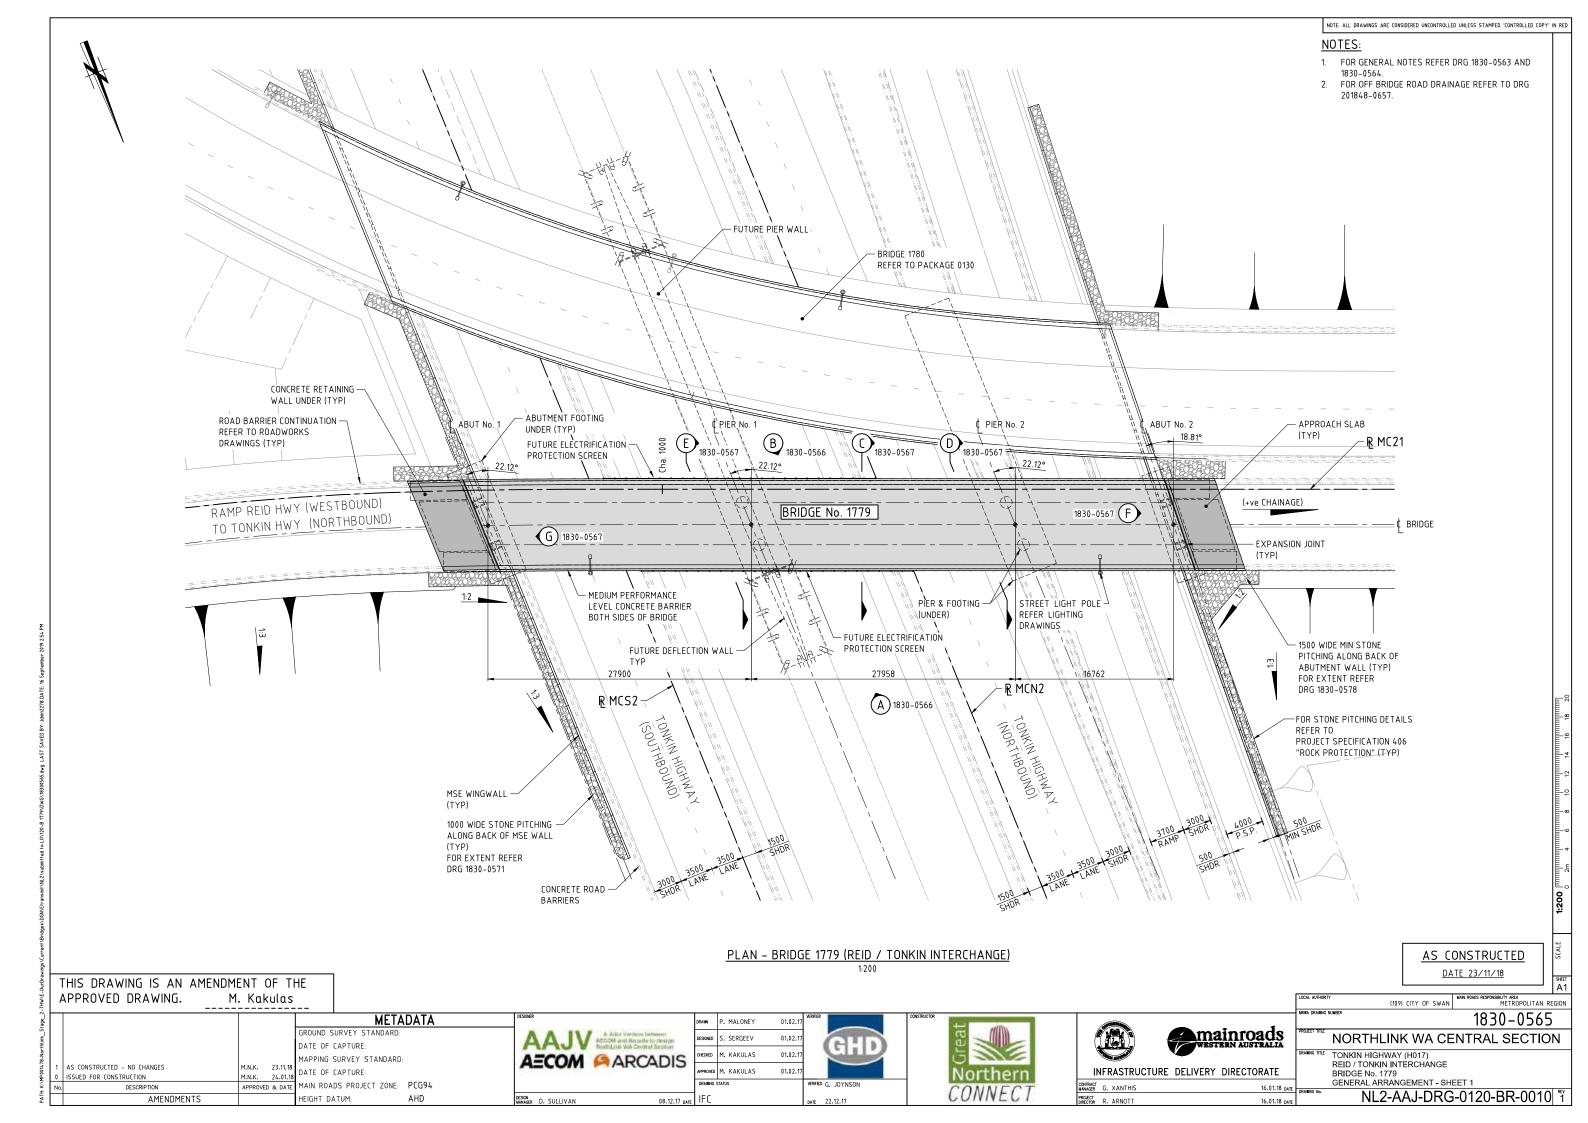


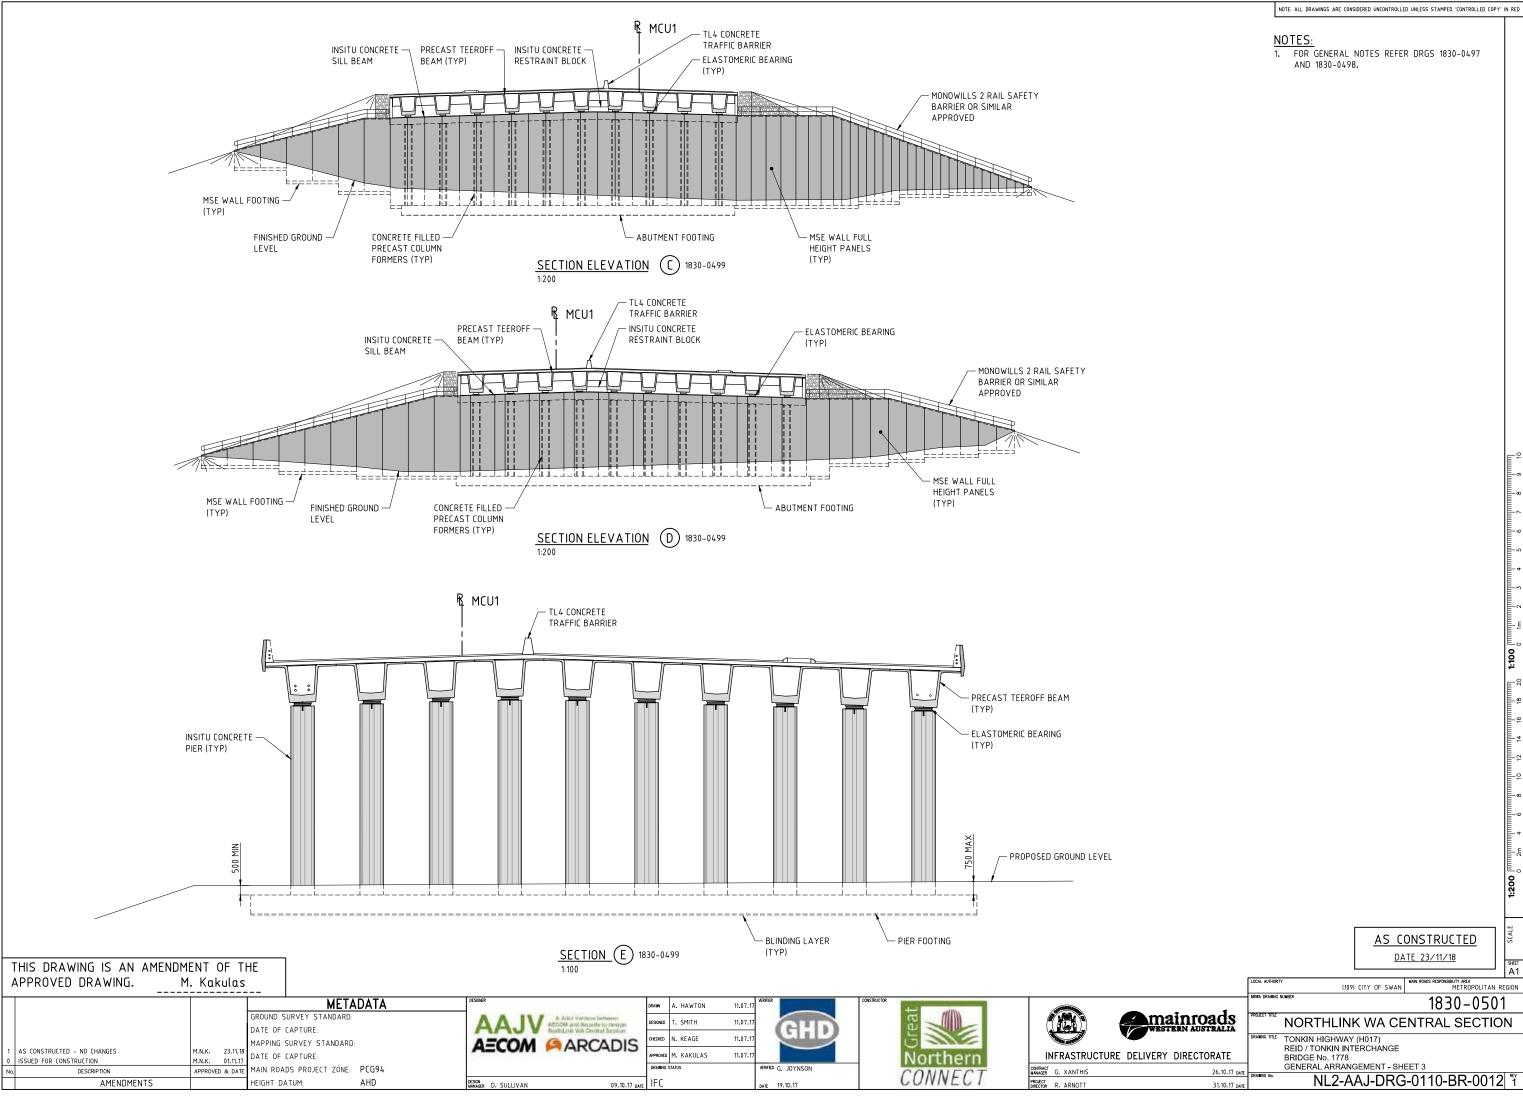
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			NL2-AAJ-DRG-0120-BR-0058	1830-0600	PRECAST TEEROFF - PRESTRESSING DETA
GENERAL			NL2-AAJ-DRG-0120-BR-0059	1830-0601	PRECAST TEEROFF - PRESTRESSING DETA
NL2-AAJ-DRG-0120-BR-0001	1830-0561	LOCALITY PLAN	NL2-AAJ-DRG-0120-BR-0060	1830-0602	PRECAST TEEROFF - REINFORCEMENT DET
NL2-AAJ-DRG-0120-BR-0002	1830-0562	INDEX	NL2-AAJ-DRG-0120-BR-0061	1830-0603	PRECAST TEEROFF - REINFORCEMENT DET
			NL2-AAJ-DRG-0120-BR-0062	1830-0604	PRECAST TEEROFF - REINFORCEMENT DET
NL2-AAJ-DRG-0120-BR-0005	1830-0563	GENERAL NOTES - SHEET 1	NL2-AA J-DRG-0120-BR-0063	1830-0605	PRECAST TEEROFF - REINFORCEMENT DET
NL2-AAJ-DRG-0120-BR-0006	1830-0564	GENERAL NOTES - SHEET 2			
NL2-AAJ-DRG-0120-BR-0010	1830-0565	GENERAL ARRANGEMENT – SHEET 1	NL2-AAJ-DRG-0120-BR-0070	1830-0606	DECK CONCRETE DETAILS - SHEET 1
NL2-AAJ-DRG-0120-BR-0011	1830-0566	GENERAL ARRANGEMENT - SHEET 2	NL2-AAJ-DRG-0120-BR-0071	1830-0607	DECK CONCRETE DETAILS - SHEET 2
NL2-AAJ-DRG-0120-BR-0012	1830-0567	GENERAL ARRANGEMENT - SHEET 3	NL2-AAJ-DRG-0120-BR-0072	1830-0608	DECK CONCRETE DETAILS - SHEET 3
		GENERAL ANNALGENERT STILLTS	NL2-AAJ-DRG-0120-BR-0073	1830-0609	DECK REINFORCEMENT DETAILS - SHEET 1
			NL2-AAJ-DRG-0120-BR-0074	1830-0610	DECK REINFORCEMENT DETAILS - SHEET 2
SUBSTRUCTURES			NL2-AAJ-DRG-0120-BR-0075	1830-0611	DIAPHRAGM DETAILS
NL2-AAJ-DRG-0120-BR-0015	1830-0568	BORE INFORMATION – SHEET 1	NL2-AAJ-DRG-0120-BR-0076	1830-0612	CONTINUITY STITCH REINFORCEMENT DETA
NL2-AAJ-DRG-0120-BR-0016	1830-0569	BORE INFORMATION - SHEET 2			
NL2-AAJ-DRG-0120-BR-0017	1830-0570	GEOMETRIC DATA	NL2-AAJ-DRG-0120-BR-0090	1830-0613	APPROACH SLAB CONCRETE DETAILS
			NL2-AAJ-DRG-0120-BR-0091	1830-0614	APPROACH SLAB REINFORCEMENT DETAILS
NL2-AAJ-DRG-0120-BR-0020	1830-0571	ABUTMENT – MSE WALL LAYOUT			
NL2-AAJ-DRG-0120-BR-0021	1830-0572	ABUTMENT - MSE WALL ELEVATIONS	NL2-AAJ-DRG-0120-BR-0100	1830-0615	EXPANSION JOINT DETAILS
NL2-AAJ-DRG-0120-BR-0023	1830-0573	ABUTMENT - MSE WALL - TYPICAL DETAILS			
NL2-AAJ-DRG-0120-BR-0024	1830-0574	COLUMN FORMER DETAILS	NL2-AAJ-DRG-0120-BR-0105	1830-0616	COVER PLATE DETAILS – SHEET 1
NL2-AAJ-DRG-0120-BR-0025	1830-0575	ABUTMENT - CONCRETE DETAILS - SHEET 1	NL2-AA J-DRG-0120-BR-0106	1830-0617	COVER PLATE DETAILS - SHEET 2
NL2-AAJ-DRG-0120-BR-0026	1830-0576	ABUTMENT - CONCRETE DETAILS - SHEET 2			
NL2-AAJ-DRG-0120-BR-0027	1830-0577	ABUTMENT - TYPICAL CONCRETE DETAILS	NL2-AA J-DRG-0120-BR-0110	1830-0618	PRECAST BARRIER LAYOUT AND DETAILS
NL2-AAJ-DRG-0120-BR-0028	1830-0578	WING WALL DETAILS	NL2-AA J-DRG-0120-BR-0111	1830-0619	PRECAST BARRIER CONCRETE DETAILS
NL2-AAJ-DRG-0120-BR-0029	1830-0579	WING WALL REINFORCEMENT DETAILS	NL2-AAJ-DRG-0120-BR-0112	1830-0620	PRECAST BARRIER CONNECTION DETAILS
NL2-AAJ-DRG-0120-BR-0030	1830-0580	ABUTMENT - REINFORCEMENT DETAILS - SHEET 1	NL2-AA J-DRG-0120-BR-0115	1830-0621	INSITU BARRIER LAYOUT AND DETAILS - S
NL2-AAJ-DRG-0120-BR-0031	1830-0581	ABUTMENT - REINFORCEMENT DETAILS - SHEET 2	NL2-AAJ-DRG-0120-BR-0116	1830-0622	INSITU BARRIER LAYOUT AND DETAILS - S
NL2-AAJ-DRG-0120-BR-0032	1830-0582	ABUTMENT - REINFORCEMENT DETAILS - SHEET 3			
NL2-AAJ-DRG-0120-BR-0033	1830-0583	COLUMN REINFORCEMENT DETAILS	NL2-AA J-DRG-0120-BR-0135	1830-0623	UNDER BRIDGE LIGHTING DETAILS
			NL2-AA J-DRG-0120-BR-0136	1830-0624	LIGHTPOLE TO BARRIER FIXING DETAILS
NL2-AAJ-DRG-0120-BR-0035	1830-0584	PIER - CONCRETE DETAILS - SHEET 1	NL2-AAJ-DRG-0120-BR-0137	1830-0625	BARRIER ELECTRICAL JUNCTION BOX DETA
NL2-AAJ-DRG-0120-BR-0036	1830-0585	PIER - CONCRETE DETAILS - SHEET 2	NL2-AAJ-DRG-0120-BR-0138	1830-0626	BARRIER ELECTRICAL JUNCTION BOX DETA
NL2-AAJ-DRG-0120-BR-0037	1830-0586	PIER - REINFORCEMENT DETAILS - SHEET 1	NL2-AAJ-DRG-0120-BR-0139	1830-0627	LUMINAIRE BRACKET DETAILS
NL2-AAJ-DRG-0120-BR-0038	1830-0587	PIER - REINFORCEMENT DETAILS - SHEET 2			
	1020 0500		NL2-AAJ-DRG-0120-BR-0140	1830-0628	EARTHING & BONDING DETAILS - SHEET 1
NL2-AAJ-DRG-0120-BR-0040	1830-0588	FUTURE PIER WALL DETAILS	NL2-AAJ-DRG-0120-BR-0141	1830-0629	EARTHING & BONDING DETAILS - SHEET 2
NL2-AAJ-DRG-0120-BR-0041	1830-0589	FUTURE PIER WALL REINFORCEMENT DETAILS			
			NL2-AAJ-DRG-0120-BR-0145	1830-0630	FUTURE ELECTRIFICATION PROTECTION SCI
SUPERSTRUCTURE			NL2-AAJ-DRG-0120-BR-0146	1830-0631	FUTURE ELECTRIFICATION PROTECTION SCI
NL2-AAJ-DRG-0120-BR-0045	1830-0590	BEARING DETAILS - SHEET 1			
NL2-AAJ-DRG-0120-BR-0046	1830-0591	BEARING DETAILS - SHEET 2	NL2-AAJ-DRG-0120-BR-0155	1830-0632	DESIGN SUMMARY SHEET - SHEET 1
NL2-AAJ-DRG-0120-BR-0047	1830-0592	BEARING DETAILS - SHEET 3	NL2-AAJ-DRG-0120-BR-0156	1830-0633	DESIGN SUMMARY SHEET - SHEET 2
NL2-AAJ-DRG-0120-BR-0050	1830-0593	PRECAST TEEROFF BEAM LAYOUT			
			MRWA STANDARD		
NL2-AAJ-DRG-0120-BR-0052	1830-0594	PRECAST TEEROFF - CONCRETE DETAILS - SHEET 1	DRAWINGS		
NL2-AAJ-DRG-0120-BR-0053	1830-0595	PRECAST TEEROFF - CONCRETE DETAILS - SHEET 2		0630-1901	BRIDGE LIGHT POLE BASE – SHEET 1
NL2-AAJ-DRG-0120-BR-0054	1830-0596	PRECAST TEEROFF - CONCRETE DETAILS - SHEET 3		0630-1902	BRIDGE LIGHT POLE BASE - SHEET 2
NL2-AAJ-DRG-0120-BR-0055	1830-0597	PRECAST TEEROFF - CONCRETE DETAILS - SHEET 4		0530-1457-3	ROAD-SIDE SLIP BASE AND BRIDGE MOUNT LIGHT POLE DETAILS – SHEET 2
NL2-AAJ-DRG-0120-BR-0056	1830-0598	PRECAST TEEROFF - PRESTRESSING DETAILS - SHEET 1			
NL2-AAJ-DRG-0120-BR-0057	1830-0599	PRECAST TEEROFF - PRESTRESSING DETAILS - SHEET 2			


THIS DRAWING IS AN AMENDMENT OF THE APPROVED DRAWING. M. Kakulas METADATA DRAWN W. DRUMMY 25.07.17 GROUND SURVEY STANDARD DESIGNED S. SERGEEV 25.07.17 GHD DATE OF CAPTURE: 25.07.17 CHECKED M. KAKULAS MAPPING SURVEY STANDARD: AS CONSTRUCTED - NO CHANGES M.N.K. 23.11.18 DATE OF CAPTURE: PPROVED M. KAKULAS 25.07.17 INFRASTRUCTURE DELIVERY DIRECTORATE Northern ISSUED FOR CONSTRUCTION M.N.K. 24.01.18 APPROVED & DATE MAIN ROADS PROJECT ZONE: PCG94 RIFIED G. JOYNSON CONTRACT MANAGER G. XANTHIS PROJECT DIRECTOR R. ARNOTT DESCRIPTION CONNEC 08.12.17 date IFC HEIGHT DATUM: AHD AMENDMENTS DESIGN MANAGER D. SULLIVAN 22.12.17

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WESTERN AUSTRALIA
                                       NORTHLINK WA CENTRAL SECTION
                                      <sup>E</sup> TONKIN HIGHWAY (H017)
REID / TONKIN INTERCHANGE
BRIDGE №. 1779
INDEX
                                 RAWING TITLE
                      16.01.18 DATE DRAWING No.
                                              NL2-AAJ-DRG-0120-BR-0002
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16.01.18 date







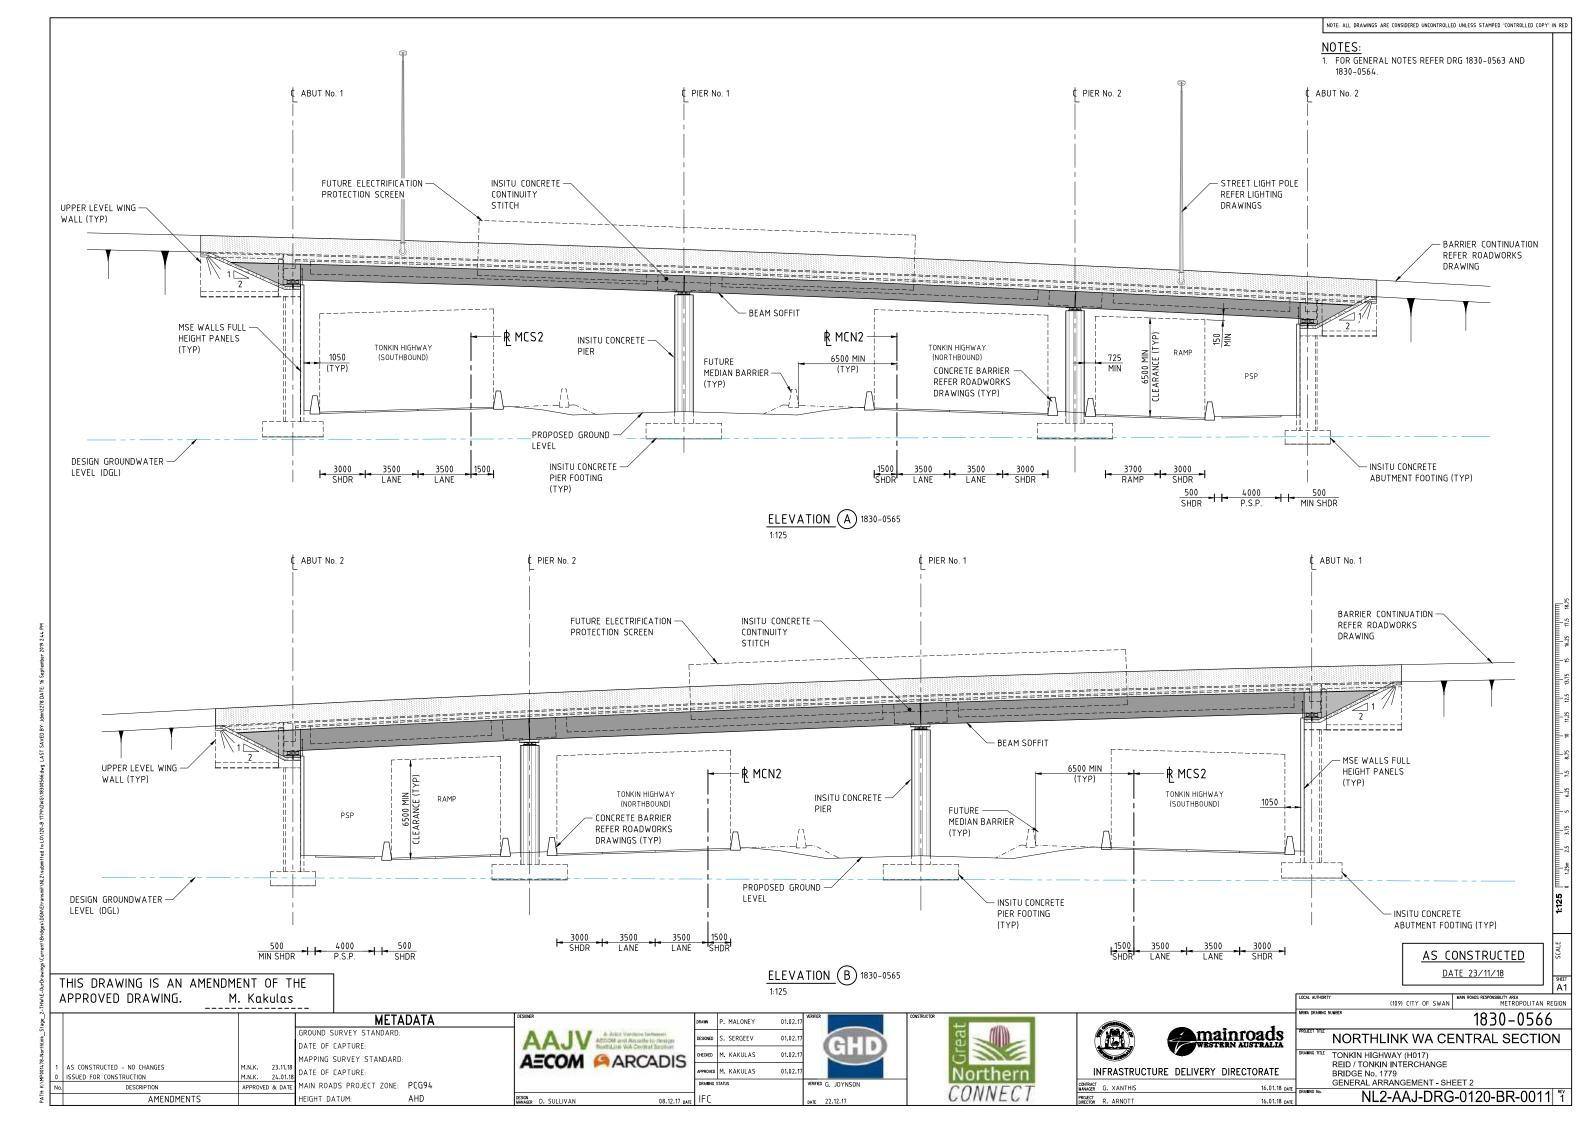


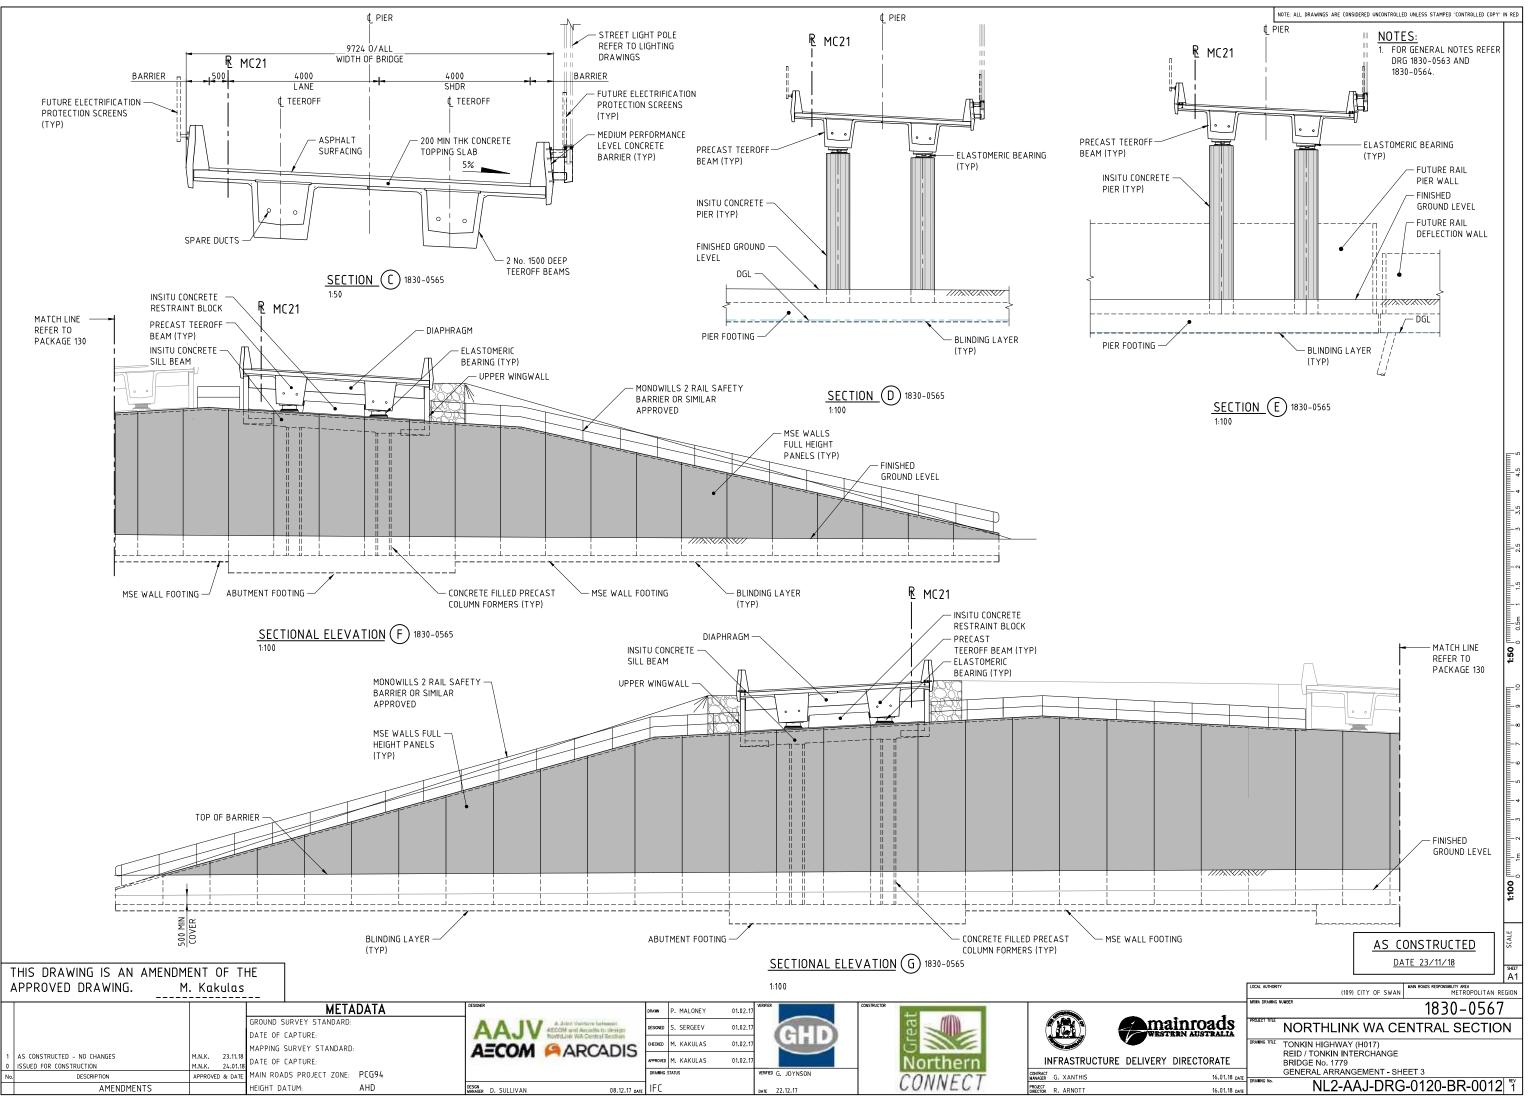								NOTE: ALL DRAWINGS ARE CONSIDERED UNCONTROLLED UNLESS STAMPED 'CONTROLLED COPY' IN RED
DRAWING NUMBER	<u>MRWA DRG No.</u>	DRAWING DESCRIPTION	DRAWING NUMBER	MRWA DRG No.	DRAWING DESCRIPTION	DRAWING NUMBER	MRWA DRG No.	DRAWING DESCRIPTION
GENERAL			NL2-AAJ-DRG-0130-BR-0057	1830-0673	PRECAST TEEROFF - PRESTRESSING DETAILS - SHEET 1	NL2-AAJ-DRG-0130-BR-0151	1830-0716	ANTI-GLARE SCREEN NORTH WALL ELEVATION – SHEET 2
NL2-AAJ-DRG-0130-BR-0001	1830-0634	LOCALITY PLAN	NL2-AAJ-DRG-0130-BR-0058	1830-0674	PRECAST TEEROFF - PRESTRESSING DETAILS - SHEET 2	NL2-AAJ-DRG-0130-BR-0152	1830-0717	ANTI-GLARE SCREEN SOUTH WALL ELEVATION
NL2-AAJ-DRG-0130-BR-0002	1830-0635	INDEX	NL2-AAJ-DRG-0130-BR-0059	1830-0675	PRECAST TEEROFF - PRESTRESSING DETAILS - SHEET 3	NL2-AAJ-DRG-0130-BR-0155	1830-0718	DESIGN SUMMARY - SHEET 1
			NL2-AAJ-DRG-0130-BR-0060	1830-0676	PRECAST TEEROFF - PRESTRESSING DETAILS - SHEET 4	NL2-AAJ-DRG-0130-BR-0156	1830-0719	DESIGN SUMMARY - SHEET 2
NL2-AAJ-DRG-0130-BR-0005	1830-0636	GENERAL NOTES – SHEET 1	NL2-AAJ-DRG-0130-BR-0061	1830-0677	PRECAST TEEROFF - REINFORCEMENT DETAILS - SHEET 1			
NL2-AAJ-DRG-0130-BR-0006	1830-0637	GENERAL NOTES - SHEET 2	NL2-AAJ-DRG-0130-BR-0062	1830-0678	PRECAST TEEROFF - REINFORCEMENT DETAILS - SHEET 2	MRWA STANDARD		
			NL2-AAJ-DRG-0130-BR-0063	1830-0679	PRECAST TEEROFF - REINFORCEMENT DETAILS - SHEET 3	DRAWINGS		ROAD-SIDE SLIP-BASE AND BRIDGE MOUNTED OCTAGONAL LIGHT
NL2-AAJ-DRG-0130-BR-0010	1830-0638	GENERAL ARRANGEMENT - SHEET 1	NL2-AAJ-DRG-0130-BR-0064	1830-0680	PRECAST TEEROFF - REINFORCEMENT DETAILS - SHEET 4	-	0530-1457-3	POLE DETAILS - SHEET 2
NL2-AAJ-DRG-0130-BR-0011	1830-0639	GENERAL ARRANGEMENT - SHEET 2	NL2-AAJ-DRG-0130-BR-0065	1830-0681	PRECAST TEEROFF - REINFORCEMENT DETAILS - SHEET 5	-	0630-1901	BRIDGE LIGHT POLE BASE - SHEET 1
NL2-AAJ-DRG-0130-BR-0012	1830-0640	GENERAL ARRANGEMENT - SHEET 3	NL2-AAJ-DRG-0130-BR-0066	1830-0682	PRECAST TEEROFF - REINFORCEMENT DETAILS - SHEET 6	-	0630-1902	BRIDGE LIGHT POLE BASE - SHEET 2
			NL2-AAJ-DRG-0130-BR-0067	1830-0683	PRECAST TEEROFF - REINFORCEMENT DETAILS - SHEET 7			
SUBSTRUCTURE			NL2-AAJ-DRG-0130-BR-0068	1830-0684	PRECAST TEEROFF - REINFORCEMENT DETAILS - SHEET 8			
NL2-AAJ-DRG-0130-BR-0015	1830-0641	BORE INFORMATION - SHEET 1						
NL2-AAJ-DRG-0130-BR-0016	1830-0642	BORE INFORMATION - SHEET 2	NL2-AAJ-DRG-0130-BR-0070	1830-0685	DECK CONCRETE DETAILS - SHEET 1			
NL2-AAJ-DRG-0130-BR-0017	1830-0643	GEOMETRIC DATA	NL2-AAJ-DRG-0130-BR-0071	1830-0686	DECK CONCRETE DETAILS - SHEET 2			
			NL2-AAJ-DRG-0130-BR-0072	1830-0687	DECK CONCRETE DETAILS – SHEET 3			
NL2-AAJ-DRG-0130-BR-0020	1830-0644	ABUTMENT – MSE WALL LAYOUT		40.20 07.00				
NL2-AAJ-DRG-0130-BR-0021	1830-0645	ABUTMENT No.1 & 2 - MSE WALL ELEVATIONS	NL2-AAJ-DRG-0130-BR-0075	1830-0688	DECK REINFORCEMENT DETAILS - SHEET 1			
			NL2-AAJ-DRG-0130-BR-0076	1830-0689	DECK REINFORCEMENT DETAILS - SHEET 2			
NL2-AAJ-DRG-0130-BR-0023	1830-0646	ABUTMENTS - MSE WALL TYPICAL DETAILS	NL2-AAJ-DRG-0130-BR-0077	1830-0690	DIAPHRAGM DETAILS - SHEET 1			
NL2-AAJ-DRG-0130-BR-0024	1830-0647	COLUMN FORMER DETAILS	NL2-AAJ-DRG-0130-BR-0078	1830-0691	DIAPHRAGM DETAILS - SHEET 2			
NL2-AAJ-DRG-0130-BR-0025	1830-0648	ABUTMENT No. 1 - CONCRETE DETAILS	NL2-AAJ-DRG-0130-BR-0079	1830-0692	CONTINUITY STITCH REINFORCEMENT DETAILS			
NL2-AAJ-DRG-0130-BR-0026	1830-0649	ABUTMENT No. 2 - CONCRETE DETAILS	NL2-AAJ-DRG-0130-BR-0090	1830-0693	APPROACH SLAB CONCRETE DETAILS			
NL2-AAJ-DRG-0130-BR-0027	1830-0650	ABUTMENT - TYPICAL CONCRETE DETAILS	NL2-AAJ-DRG-0130-BR-0090	1830-0694	APPROACH SLAB REINFORCEMENT DETAILS			
NL2-AAJ-DRG-0130-BR-0028	1830-0651	WING WALL DETAILS		1050-0074	AFFROACT SLAD KLINI OKCLI LINI DETAILS			
NL2-AAJ-DRG-0130-BR-0029	1830-0652	WING WALL - REINFORCEMENT DETAILS	NL2-AAJ-DRG-0130-BR-0100	1830-0695	EXPANSION JOINT DETAILS			
NL2-AAJ-DRG-0130-BR-0030	1830-0653	ABUTMENT REINFORCEMENT DETAILS - SHEET 1		1090-0095				
NL2-AAJ-DRG-0130-BR-0031	1830-0654	ABUTMENT REINFORCEMENT DETAILS - SHEET 2	NL2-AAJ-DRG-0130-BR-0105	1830-0696	COVER PLATE DETAILS - SHEET 1			
NL2-AAJ-DRG-0130-BR-0032	1830-0655	ABUTMENT REINFORCEMENT DETAILS - SHEET 3	NL2-AAJ-DRG-0130-BR-0106	1830-0697	COVER PLATE DETAILS - SHEET 2			
NL2-AAJ-DRG-0130-BR-0033	1830-0656	ABUTMENT REINFORCEMENT DETAILS - SHEET 4						
			NL2-AAJ-DRG-0130-BR-0110	1830-0698	PRECAST BARRIER LAYOUT AND DETAILS – SHEET 1			
NL2-AAJ-DRG-0130-BR-0035	1830-0657	PIER CONCRETE DETAILS - SHEET 1	NL2-AAJ-DRG-0130-BR-0111	1830-0699	PRECAST BARRIER LAYOUT AND DETAILS – SHEET 2			
NL2-AAJ-DRG-0130-BR-0036	1830-0658	PIER - CONCRETE DETAILS - SHEET 2						
NL2-AAJ-DRG-0130-BR-0037	1830-0659	PIER - REINFORCEMENT DETAILS - SHEET 1	NL2-AAJ-DRG-0130-BR-0115	1830-0700	INSITU BARRIER LAYOUT AND DETAILS - SHEET 1			
NL2-AAJ-DRG-0130-BR-0038	1830-0660	PIER - REINFORCEMENT DETAILS - SHEET 2	NL2-AAJ-DRG-0130-BR-0116	1830-0701	INSITU BARRIER LAYOUT AND DETAILS - SHEET 2			
NL2-AAJ-DRG-0130-BR-0040	1830-0661	FUTURE PIER DEFLECTION WALL - SHEET 1	NL2-AAJ-DRG-0130-BR-0135	1830-0702	UNDER BRIDGE LIGHTING DETAILS			
NL2-AAJ-DRG-0130-BR-0041	1830-0662	FUTURE PIER DEFLECTION WALL - SHEET 2	NL2-AAJ-DRG-0130-BR-0136	1830-0703	JUNCTION BOX DETAILS - SHEET 1			
			NL2-AAJ-DRG-0130-BR-0137	1830-0704	JUNCTION BOX DETAILS - SHEET 2			
SUPERSTRUCTURE			NL2-AAJ-DRG-0130-BR-0138	1830-0705	LIGHTING POLE TO BARRIER FIXING DETAILS			
NL2-AAJ-DRG-0130-BR-0045	1830-0663	BEARING DETAILS - SHEET 1	NL2-AAJ-DRG-0130-BR-0139	1830-0706	LUMINAIRE BRACKET DETAILS			
NL2-AAJ-DRG-0130-BR-0046	1830-0664	BEARING DETAILS - SHEET 2	NL2-AAJ-DRG-0130-BR-0140	1830-0707	EARTHING & BONDING DETAILS - SHEET 1			
NL2-AAJ-DRG-0130-BR-0047	1830-0665	BEARING DETAILS - SHEET 3	NL2-AAJ-DRG-0130-BR-0141	1830-0708	EARTHING & BONDING DETAILS - SHEET 2			
			NL2-AAJ-DRG-0130-BR-0142	1830-0709	EARTHING & BONDING DETAILS - SHEET 3			
NL2-AAJ-DRG-0130-BR-0050	1830-0666	PRECAST TEEROFF BEAM LAYOUT						
NL2-AAJ-DRG-0130-BR-0051	1830-0667	PRECAST TEEROFF - CONCRETE DETAILS - SHEET 1	NL2-AAJ-DRG-0130-BR-0145	1830-0710	ANTI-GLARE & ELECT. PROTECTION SCREEN LAYOUT PLAN			
NL2-AAJ-DRG-0130-BR-0052	1830-0668	PRECAST TEEROFF - CONCRETE DETAILS - SHEET 2	NL2-AAJ-DRG-0130-BR-0146	1830-0711	ANTI-GLARE & ELECT. PROTECTION SCREEN - SHEET 1			
NL2-AAJ-DRG-0130-BR-0053	1830-0669	PRECAST TEEROFF - CONCRETE DETAILS - SHEET 3	NL2-AAJ-DRG-0130-BR-0147	1830-0712	ANTI-GLARE & ELECT. PROTECTION SCREEN - SHEET 2			
NL2-AAJ-DRG-0130-BR-0054	1830-0670	PRECAST TEEROFF - CONCRETE DETAILS - SHEET 4	NL2-AAJ-DRG-0130-BR-0148	1830-0713	ANTI-GLARE & ELECT. PROTECTION SCREEN - SHEET 3			
NL2-AAJ-DRG-0130-BR-0055	1830-0671	PRECAST TEEROFF - CONCRETE DETAILS - SHEET 5	NL2-AAJ-DRG-0130-BR-0149	1830-0714	ANTI-GLARE SCREEN OFF BRIDGE DETAILS			
NL2-AAJ-DRG-0130-BR-0056	1830-0672	PRECAST TEEROFF - CONCRETE DETAILS - SHEET 6	NL2-AAJ-DRG-0130-BR-0150	1830-0715	ANTI-GLARE SCREEN NORTH WALL ELEVATION - SHEET 1			
								AS CONSTRUCTED
								DATE 23/11/18
THIS DRAWING IS AN A								
APPROVED DRAWING.	M. Ka							LOCH AUTHORITY (109) CITY OF SWAN MAIN ROADS RESPONSIBILITY AREA METROPOLITAN REGION
		METADATA	DESIGNER	DRAWN P. MORRISON	01.08.17 VERIFER CONSTRUCTOR			MRNA DRAWNG NUMBER 1830-0635
		GROUND SURVEY STANDARD: DATE OF CAPTURE:	AAJV Adust Variante heteret ACCOM and Arreste in design Notifiante WA Contral Section	DESIGNED W. GALLAGER			Mainro WESTERN AUST	ads NORTHLINK WA CENTRAL SECTION
		MAPPING SURVEY STANDARD:	AECOM ARCADIS	CHECKED N. KEAGE	01.08.17		The second rule	DRAWING TITLE TONKIN HIGHWAY (H017)
1 AS CONSTRUCTED - NO CHANGES 0 ISSUED FOR CONSTRUCTION	M.N.K. M.N.K.	23.11.18 24.01.18 DATE OF CAPTURE:		APPROVED M. KAKULAS	01.08.17 Northern	INFRASTRUCTURE DE	LIVERY DIRECTO	BRIDGETTE
No. DESCRIPTION		ED & DATE MAIN ROADS PROJECT ZONE: PCG94 HEIGHT DATUM: AHD	DESIGN DESIGN	DRAWING STATUS	VERIFIED G. JOYNSON	CONTRACT MANAGER G. XANTHIS PROJECT R. ARNOTT		16.01.18 DATE DECEMBRING No. INDEX
AMENUMEN			DESIGN MANAGER D. SULLIVAN 18.12.17 da	πεμ II C	DATE 22.12.17	DIRECTOR R. ARNOTT		16.01.18 DATE NLZ-ARJ-DING-0150-DIN-0002 1

		ASC	UNSTRUCTED	Ň
		<u>D</u> /	TE 23/11/18	SHEET
				A1
	LOCAL AUTHORITY	109) CITY OF SWAN	MAIN ROADS RESPONSIBILITY AREA METROPOLITAN	REGION
	MRWA DRAWING NUMBER		1830-063	5
mainroads		NK WA CE	ENTRAL SECTION	ЛС
/ERY DIRECTORATE	DRAWING TITLE TONKIN HIGHW REID / TONKIN I BRIDGE No. 178	NTÈRCHÁNGE		
16.01.18 date				O REV
16.01.18 date	NL2-	AAJ-DRO	G-0130-BR-000	Z 1

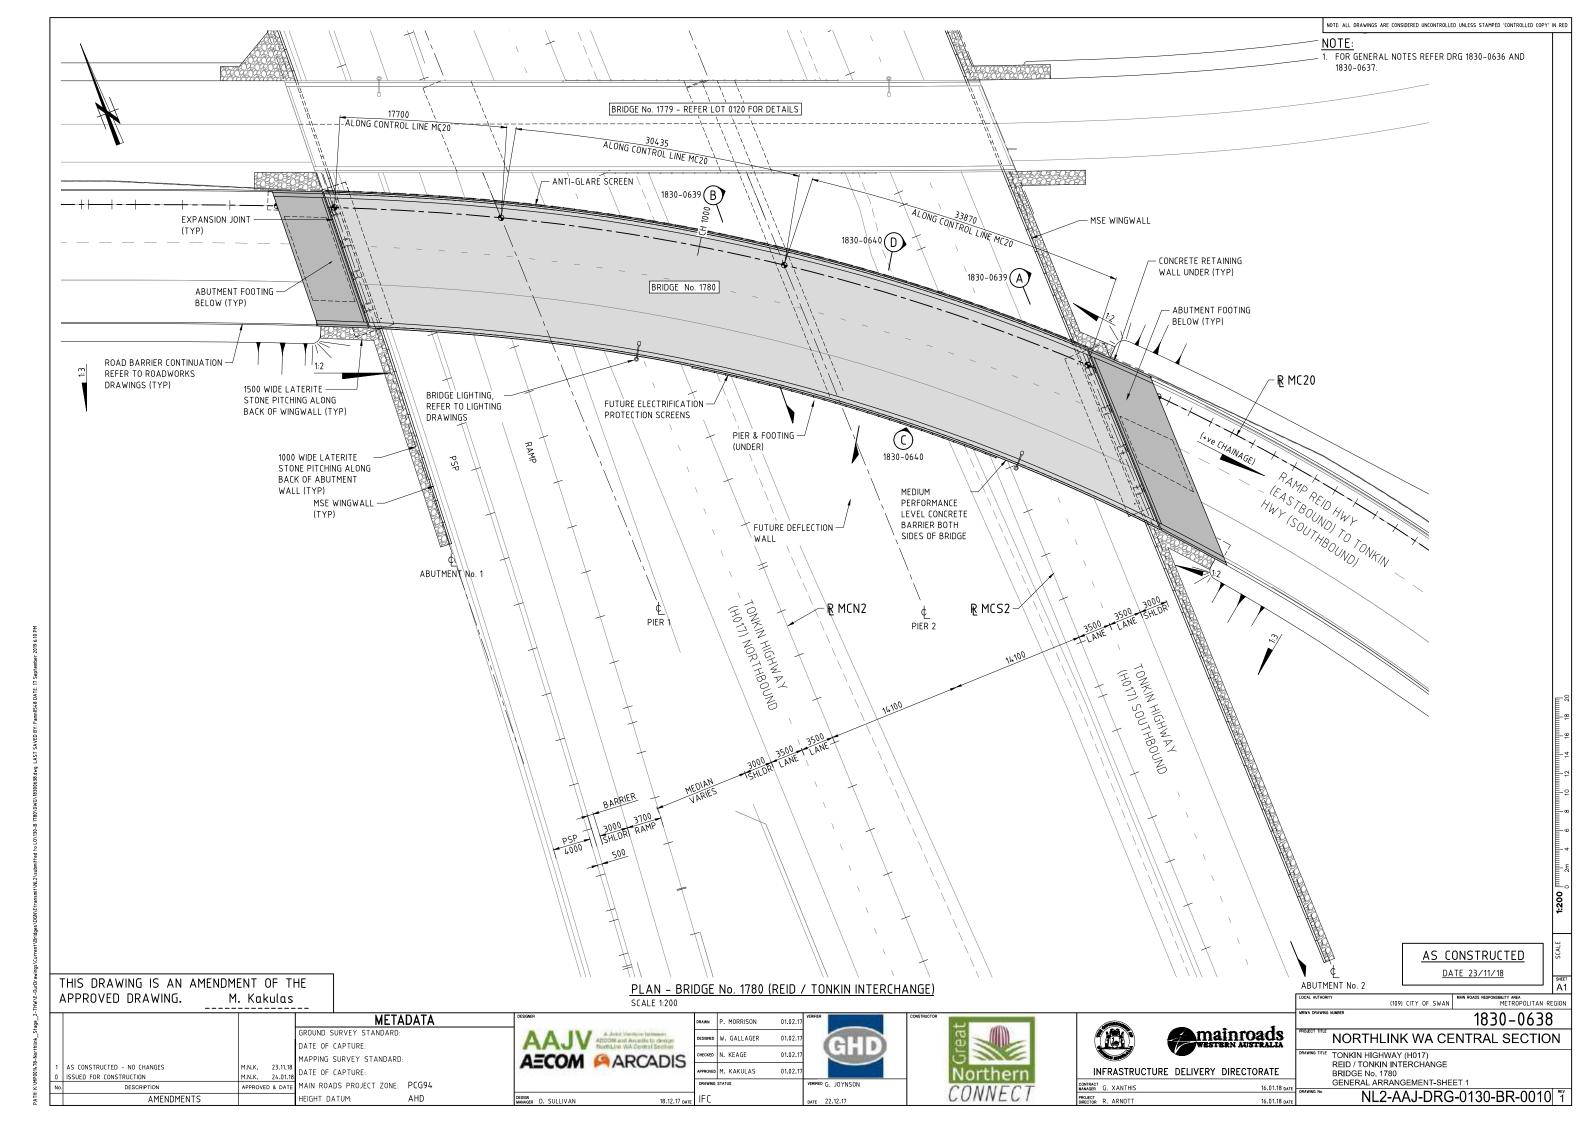

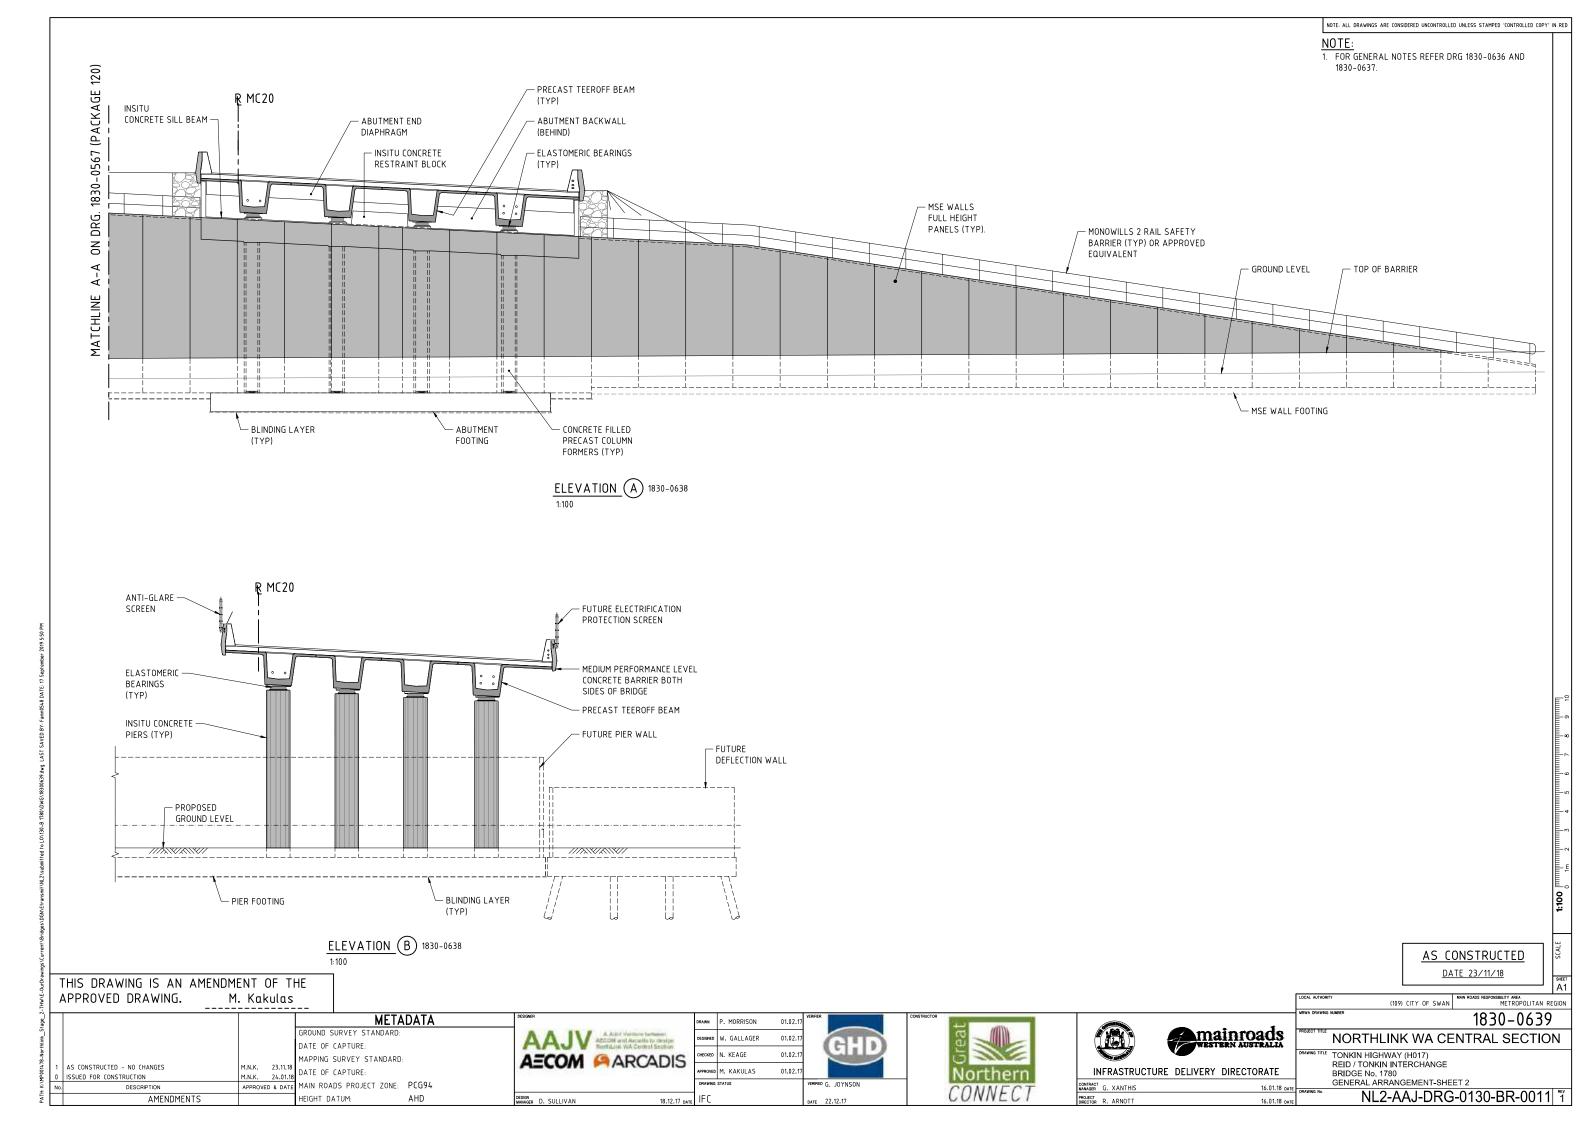


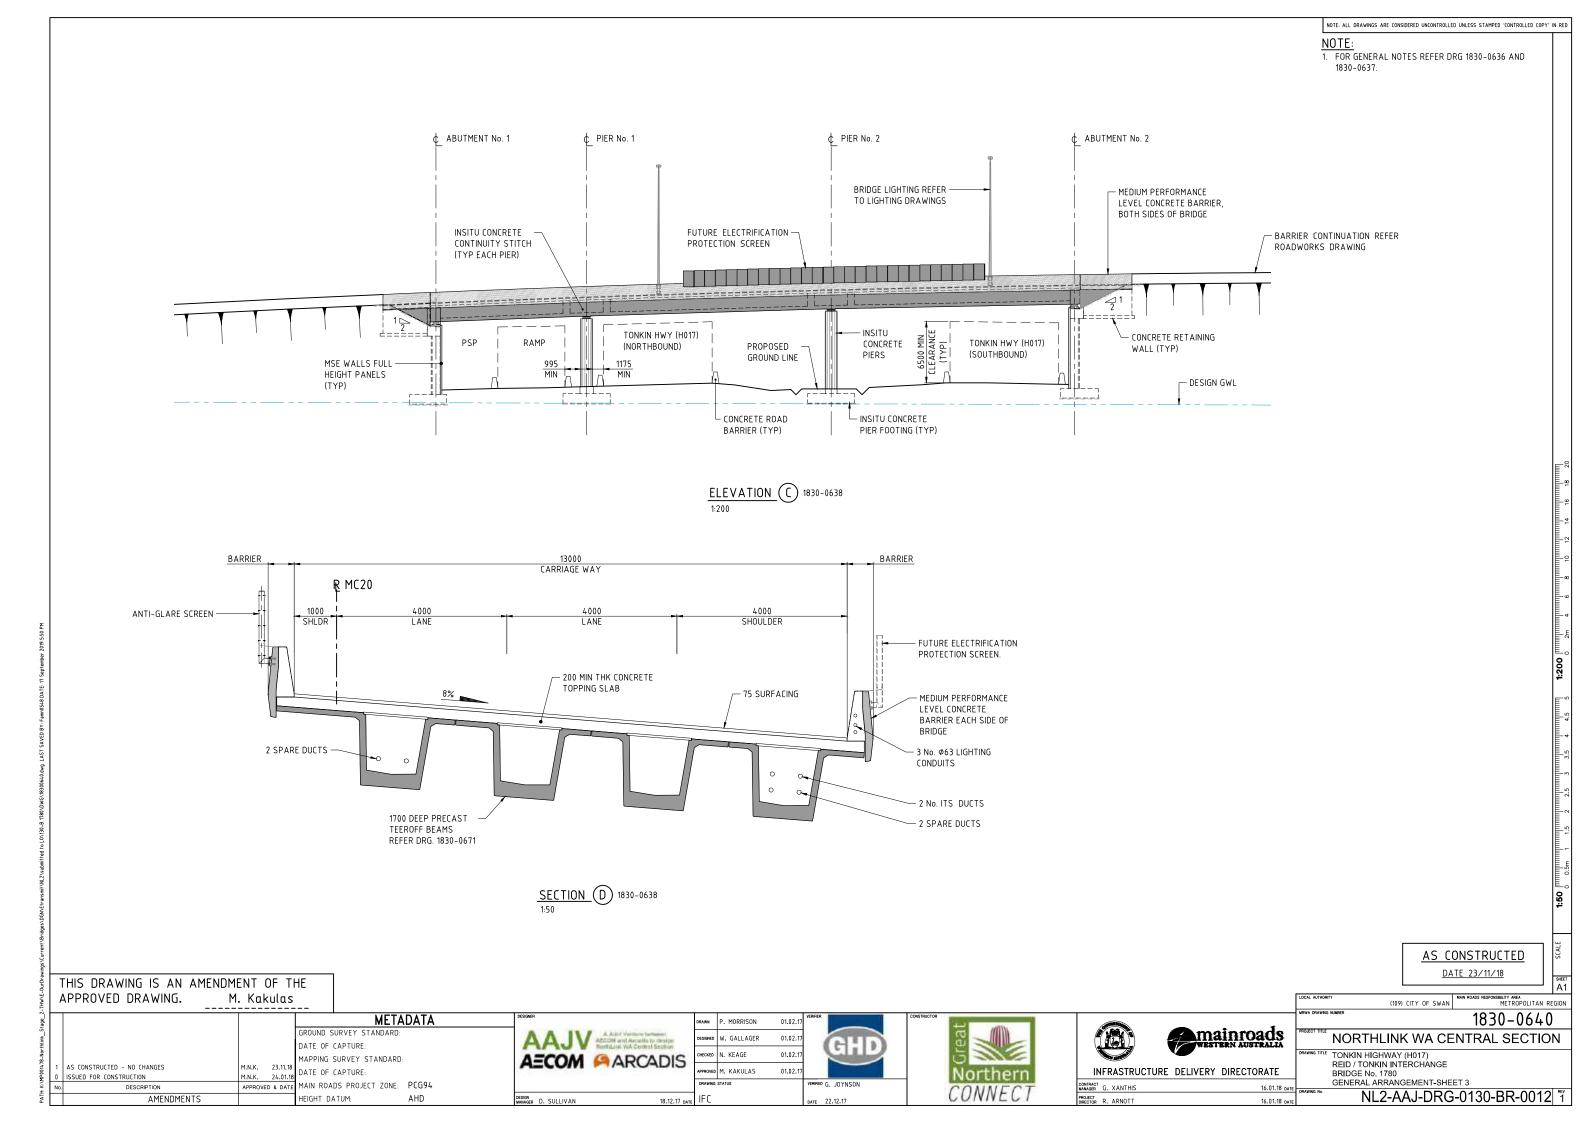

DRAWING INDEX		
DRAWING NUMBER	MRWA DRG No.	DRAWING DESCRIPTION
NL2-AAJ-DRG-0150-UP-0001	1830-0776	LOCALITY PLAN
NL2-AAJ-DRG-0150-UP-0002	1830-0777	INDEX
NL2-AAJ-DRG-0150-UP-0005	1830-0778	GENERAL NOTES
NL2-AAJ-DRG-0150-UP-0010	1830-0779	GENERAL ARRANGEMENT - SHEET 1
NL2-AAJ-DRG-0150-UP-0011	1830-0780	GENERAL ARRANGEMENT - SHEET 2
NL2-AAJ-DRG-0150-UP-0013	1830-0781	BOREHOLE DATA
NL2-AAJ-DRG-0150-UP-0015	1830-0782	FOOTING CONCRETE DETAILS
NL2-AAJ-DRG-0150-UP-0020	1830-0783	FOOTING REINFORCEMENT DETAILS
NL2-AAJ-DRG-0150-UP-0025	1830-0784	TRAPEZOIDAL UNIT LAYOUT AND DETAILS
NL2-AAJ-DRG-0150-UP-0030	1830-0785	TRAPEZOIDAL UNIT CONCRETE DETAILS
NL2-AAJ-DRG-0150-UP-0035	1830-0786	TRAPEZOIDAL UNIT REINFORCEMENT DETAILS - SHEET 1
NL2-AAJ-DRG-0150-UP-0036	1830-0787	TRAPEZOIDAL UNIT REINFORCEMENT DETAILS - SHEET 2
NL2-AAJ-DRG-0150-UP-0040	1830-0788	SPANDREL WALL LAYOUT AND DETAILS
NL2-AAJ-DRG-0150-UP-0045	1830-0789	SPANDREL WALL CONCRETE DETAILS
NL2-AAJ-DRG-0150-UP-0046	1830-0790	SPANDREL WALL REINFORCEMENT DETAILS
NL2-AAJ-DRG-0150-UP-0050	1830-0791	SPANDREL INSTALLATION BRACKET DETAILS
NL2-AAJ-DRG-0150-UP-0051	1830-0792	SPANDREL AND WING WALL ASSEMBLY DETAILS
NL2-AAJ-DRG-0150-UP-0074	1830-0793	WING WALL LAYOUT
NL2-AAJ-DRG-0150-UP-0075	1830-0794	WING WALL CONCRETE DETAILS - SHEET 1
NL2-AAJ-DRG-0150-UP-0076	1830-0795	WING WALL CONCRETE DETAILS - SHEET 2
NL2-AAJ-DRG-0150-UP-0077	1830-0796	WING WALL CONCRETE DETAILS - SHEET 3
	1030-0790	WIND WALL CONCRETE DETAILS - SHEET S
NL2-AAJ-DRG-0150-UP-0080	1830-0797	WING WALL REINFORCEMENT DETAILS - SHEET 1
NL2-AAJ-DRG-0150-UP-0081	1830-0798	WING WALL REINFORCEMENT DETAILS - SHEET 2
10.01-10-0610-010-0101	0710-070	WINS WALL NEW ONCERENT DETAILS - SHELT Z
NL2-AAJ-DRG-0150-UP-0090	1830-0799	LUMINAIRE DETAILS
NL2-AAJ-DRG-0150-UP-0100	1830-0800	DESIGN SUMMARY - SHEET 1 (TO FOLLOW)
NL2-AAJ-DRG-0150-UP-0101	1830-0801	DESIGN SUMMARY - SHEET 2 (TO FOLLOW)
	.550 0001	

2-THW\E-OurDrawings\C	THIS DRAWING IS AN AMENDMI APPROVED DRAWING. M	ENT OF TH . Kakulas	IE 							
PATH: K:\MP001478-Northlink_Stage_2	0 ISSUED FOR CONSTRUCTION	M.N.K. 23.11.18 M.N.K. 25.08.17 APPROVED & DATE	MET GROUND SURVEY STANDARI DATE OF CAPTURE: MAPPING SURVEY STANDAR DATE OF CAPTURE: MAIN ROADS PROJECT ZONE HEIGHT DATUM:	D:	CARED M. CHOWDHURY CARED P. DOBSON ROVED M. KAKULAS	18.04.17 28.04.17 28.04.17 28.04.17 28.04.17	VERFER VERFED G. JOYNSON DATE 17.08.17	orthern DNNECT	INFRASTRUCTUR	RE DELIVER

	AS CONSTRUCTED	SCALE
	<u>DATE 23/11/18</u>	sheet A1
	LOCAL AUTHORITY (109) CITY OF SWAN MAN ROADS RESPONSELITY AREA	
WESTERN AUSTRALIA	NORTHLINK WA CENTRAL SECTIO	
ELIVERY DIRECTORATE		

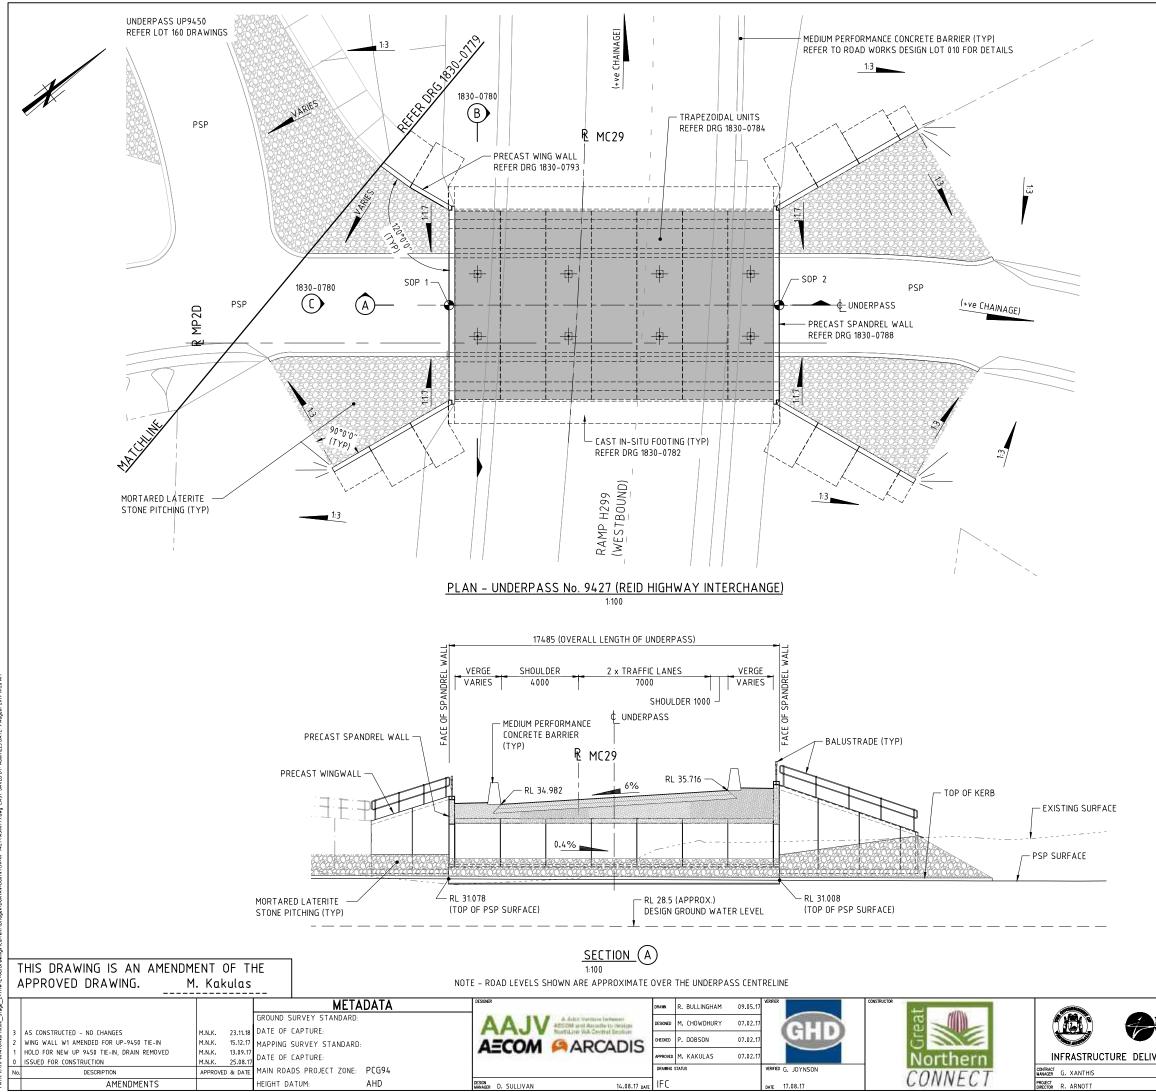


	TO END OF WING N 3. STONE PITCHING SI SPECIFICATION 406	THEN TRANSITION TO 1:3 SLOPE WALLS. HALL BE IN ACCORDANCE WITH - ROCK PROTECTION. 'S TABLE REFER DRG 1830-0782.	
	TION SUMMARY:		
 TRAFFIC LOADS - GROUP 2 VEHICLE ROADS DOCUMENT 	DRDANCE WITH AS 5100-2004 100% SM1600 HLP400 AND 5 HEAVY LOAD PLATFORM V 3912/02-2 . HLP VEHICLES RLINE OF CARRIAGEWAY. 100YRS. 5 LOAD	GROUP 2 VEHICLE 4 AND /EHICLES DETAILED IN MAIN	
	ACENT TO SPANDREL WALL) ULS V2000 SLS V20	5.0kPa. (ELSEWHERE) 10kPa. 48m/s 37m/s.	
ACCELERATION SITE FACTOR, SUB SOIL CLAS SPECTRAL SHA BRIDGE CLASSI IMPORTANCE F, BRIDGE EARTHI	S SS PE FACTOR Ch (T) FICATION	0.09 1.25 Ce 3.68 (1.3) TYPE 2 1.0 BEDC-2 20mm.	ուսորուուր 8 9 10
GEOTECHNICAL S	SUMMARY		6 7
1. BULK SOIL UNIT N		18kN∕m³ (DRY) 20kN∕m³ (SATURATED)	1 5
2. ANGLE OF INTERN 3. COHESION 4. GEOTECHNICAL ST	AL FRICTION RENGTH REDUCTION FACTOR	36° NIL 0.55	1:100 [mmmmmmmmmmmmm] 0 1m 2 3 .
	LOCH, AUTHORITY (100), CL	AS CONSTRUCTED DATE 23/11/18	SCALE SCALE
	MRWA DRAWING NUMBER	1830-0779	,
mainfoads	PROJECT TITLE NORTHLINK	WA CENTRAL SECTIO	N
YERY DIRECTORATE	REID / TONKIN INTÈR UNDERPASS No. 942 GENERAL ARRANGE	RCHÁNGE 7 MENT - SHEET 1	REV
23.08.17 da		J-DRG-0150-UP-0010) ^{REV}

1. FOR GENERAL NOTES REFER DRG 1830-0778.

2. STONE PITCHING BATTER GRADE TO BE 1:1.7

INSIDE UNDERPASS AND EXTEND 2.0m FROM


NOTES:

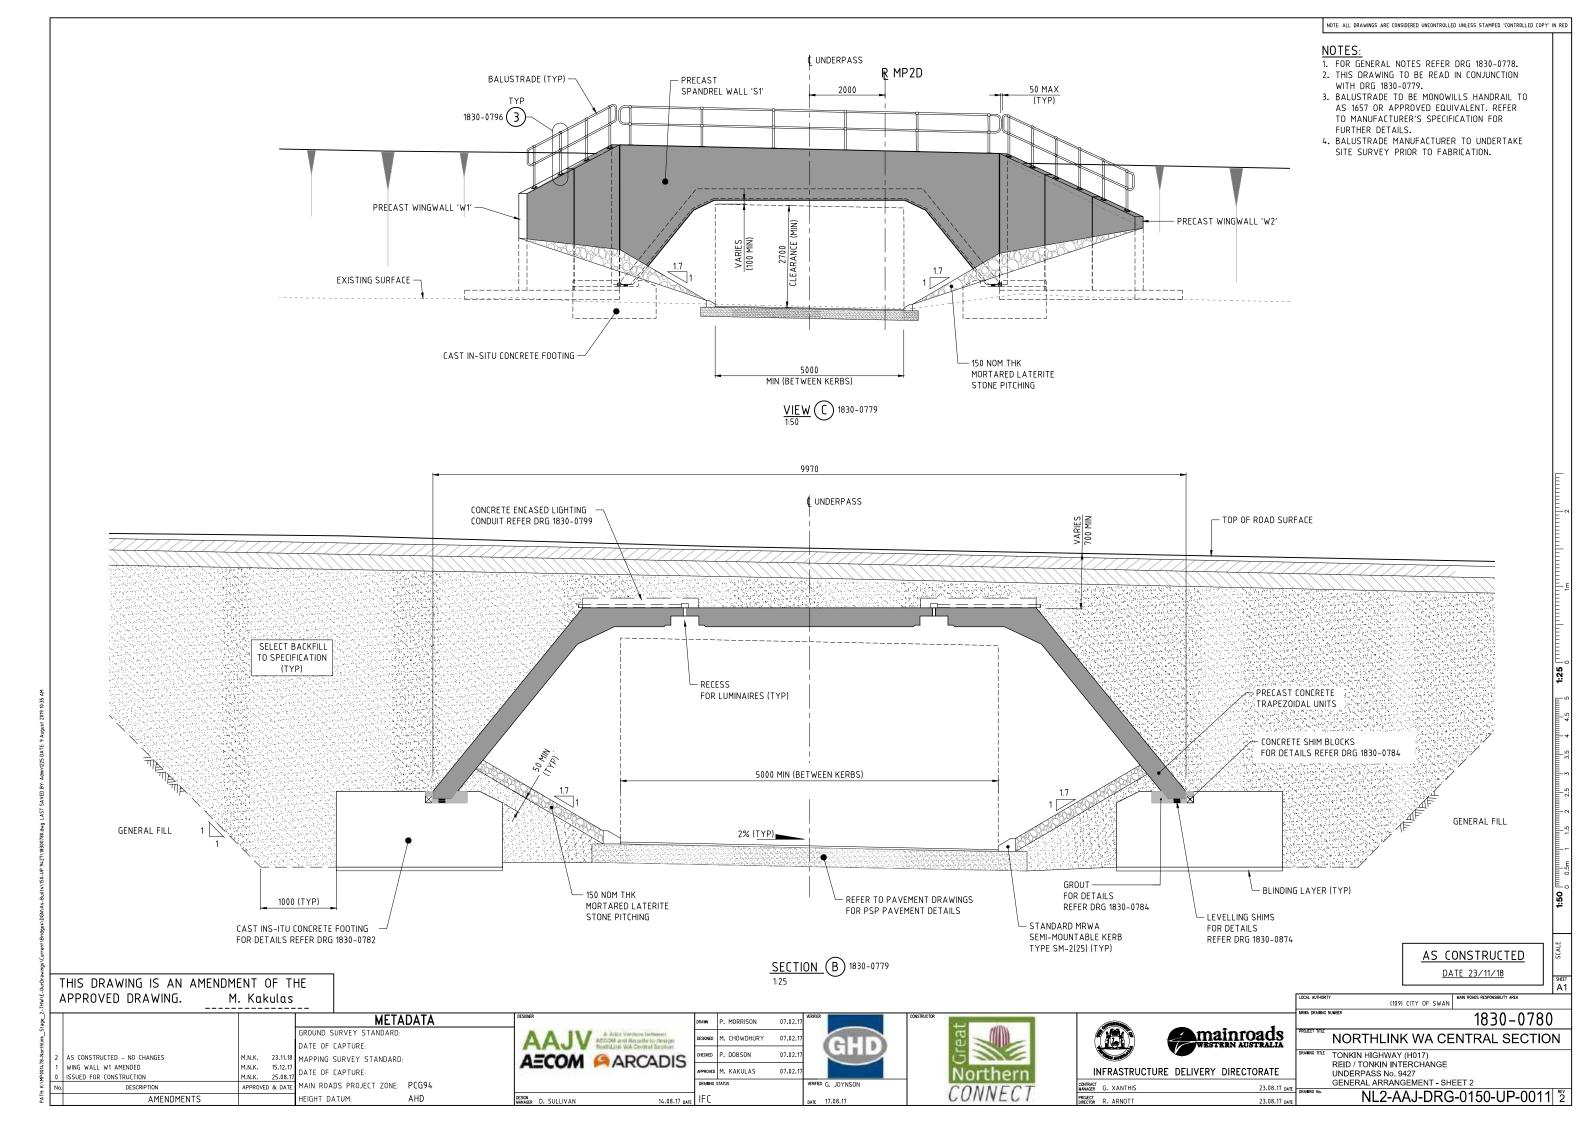

DRAWING INDEX		
DRAWING NUMBER	MRWA DRG No.	DRAWING DESCRIPTION
NL2-AAJ-DRG-0160-UP-0001	1830-0876	LOCALITY PLAN
NL2-AAJ-DRG-0160-UP-0002	1830-0877	INDEX
NL2-AAJ-DRG-0160-UP-0005	1830-0878	GENERAL NOTES
NL2-AAJ-DRG-0160-UP-0010	1830-0879	GENERAL ARRANGEMENT - SHEET 1
NL2-AAJ-DRG-0160-UP-0011	1830-0880	GENERAL ARRANGEMENT - SHEET 2
NL2-AAJ-DRG-0160-UP-0012	1830-0881	GENERAL ARRANGEMENT - SHEET 3
NL2-AAJ-DRG-0160-UP-0013	1830-0882	BOREHOLE DATA
NL2-AAJ-DRG-0160-UP-0015	1830-0883	FOOTING CONCRETE DETAILS
NL2-AAJ-DRG-0160-UP-0020	1830-0884	FOOTING REINFORCEMENT DETAILS
NL2-AAJ-DRG-0160-UP-0025	1830-0885	TRAPEZOIDAL UNIT LAYOUT AND DETAILS
NL2-AAJ-DRG-0160-UP-0030	1830-0886	TRAPEZOIDAL UNIT CONCRETE DETAILS - SHEET 1
NL2-AAJ-DRG-0160-UP-0031	1830-0887	TRAPEZOIDAL UNIT CONCRETE DETAILS - SHEET 2
NLZ-AAJ-DRU-0160-0P-0051	1000-0007	TRAPEZUIDAL UNIT CUNCRETE DETAILS - SHEET Z
NL2-AAJ-DRG-0160-UP-0035	1830-0888	TRAPEZOIDAL UNIT REINFORCEMENT DETAILS – SHEET 1
NL2-AAJ-DRG-0160-UP-0036	1830-0889	TRAPEZOIDAL UNIT REINFORCEMENT DETAILS - SHEET 2
NL2-AAJ-DRG-0160-UP-0040	1830-0890	SPANDREL WALL LAYOUT AND DETAILS
NL2-AAJ-DRG-0160-UP-0045	1830-0891	SPANDREL WALL CONCRETE DETAILS
NL2-AAJ-DRG-0160-UP-0046	1830-0892	SPANDREL WALL REINFORCEMENT DETAILS
NL2-AAJ-DRG-0160-UP-0050	1830-0893	SPANDREL INSTALLATION BRACKET DETAILS
NL2-AAJ-DRG-0160-UP-0073	1830-0894	WING WALL LAYOUT
NL2-AAJ-DRG-0160-UP-0074	1830-0895	WING WALL CONCRETE DETAILS - SHEET 1
NL2-AAJ-DRG-0160-UP-0075	1830-0896	WING WALL CONCRETE DETAILS - SHEET 2
NL2-AAJ-DRG-0160-UP-0076	1830-0897	WING WALL CONCRETE DETAILS - SHEET 3
NL2-AAJ-DRG-0160-UP-0077	1830-0898	WING WALL CONCRETE DETAILS - SHEET 4
NL2-AAJ-DRG-0160-UP-0078	1830-0899	WING WALL CONCRETE DETAILS - SHEET 5
NL2-AAJ-DRG-0160-UP-0079	1830-0900	WING WALL CONCRETE DETAILS - SHEET 6
NL2-AAJ-DRG-0160-UP-0080	1830-0901	WING WALL REINFORCEMENT DETAILS - SHEET 1
NL2-AAJ-DRG-0160-UP-0081	1830-0902	WING WALL REINFORCEMENT DETAILS - SHEET 2
NL2-AAJ-DRG-0160-UP-0090	1830-0903	LUMINAIRE DETAILS
	1020 1001	
NL2-AAJ-DRG-0160-UP-0100	1830-0904	DESIGN SUMMARY - SHEET 1 (TO FOLLOW)
NL2-AAJ-DRG-0160-UP-0101	1830-0905	DESIGN SUMMARY - SHEET 2 (TO FOLLOW)

?-THW\E-OurDrawings\Curr	THIS DRAWING IS AN AMENDMENT OF APPROVED DRAWING. M. Kakul						
4.78-Northlink_Stage_2	1 AS CONSTRUCTED - NO CHANGES M.N.K. 23	METADATA GROUND SURVEY STANDARD: DATE OF CAPTURE: MAPPING SURVEY STANDARD: 3.11.18	AECOM ARCADIS	DRAWN R. BULLINGHAM 11.05.1 DESIGNED M. CHOWDHURY 28.04.1 GHECKED P. DOBSON 28.04.1	GHD	Great	
PATH: K:\MP001	0 ISSUED FOR CONSTRUCTION M.N.K. 25 No. DESCRIPTION APPROVED &		design Wanager D. SULLIVAN 22.12.17 date	DRAWING STATUS	VERFED L. TINLIN DATE 18.01.18	Northern CONNECT	INFRASTRUCTURE DELIVER)

	AS CONSTRUCTED	JUMIC
	LOOL AUTHORIY (112) CITY OF BAYSWATER MAN ROADS RESPONSELUTY AREA METROPOLITAN REG	HEET A1 ION
mainroads	HERA DRAWNO NUMBER 1830-0877 PROZET THE NORTHLINK WA CENTRAL SECTION	1
ERY DIRECTORATE	BRANNET TONKIN HIGHWAY (H017) REID / TONKIN INTERCHANGE UNDERPASS No. 9450 INDEX	
23.01.18 date 23.01.18 date		^{rev}

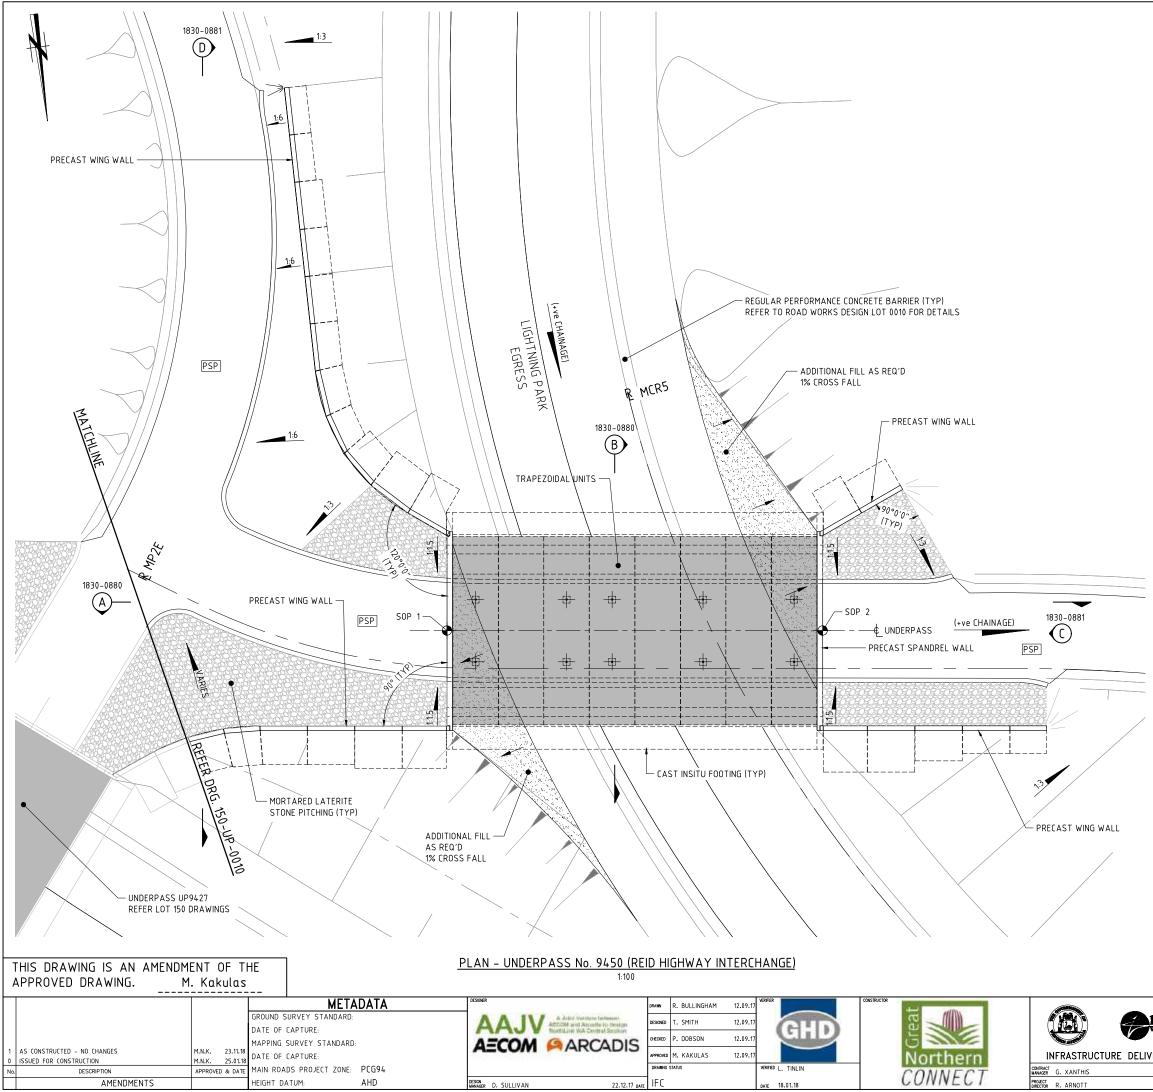

18.01.18


		-	_
		NOTE: ALL DRAWINGS ARE CONSIDERED UNCONTROLLED UNLESS STAMPED 'CONTROLLED COPY' IN REL	D
		 NOTES: FOR GENERAL NOTES REFER DRG 1830-0878. STONE PITCHING BATTER GRADE TO BE 1:1.5 INSIDE UNDERPASS AND EXTEND 2.0m FROM SPANDREL WALL, THEN TRANSITION TO 1:3 SLOPE TO END OF WING WALLS. STONE PITCHING SHALL BE IN ACCORDANCE WITH SPECIFICATION 406 - ROCK PROTECTION. FOR SETOUT POINTS TABLE REFER DRG 1830-0883. 	
DE	SIGN INFORMATI	ON SUMMARY:	
1.	DESIGNED IN ACCORD	ANCE WITH AS 5100-2004 'BRIDGE DESIGN CODE' UNO.	
2.		0% SM1600, HLP400 AND GROUP 2 VEHICLE 4 AND 5	
۷.	AS DETAILED IN MAIN	N ROADS DOCUMENT 3912/02-2. HLP AND GROUP 2 POSITIONED ±1.0m FROM THE CENTERLINE OF	
3.	DESIGN LIFE -	100YRS.	


DESIGN INFO

4.	EMBANKMENT LIVE L	OAD	2.5kPa. (steeper than 1:4) 5.0kPa. (elsewhere)
5.	SURCHARGE (ADJACE	ENT TO SPANDREL WALL)	10kPa.
6.	WIND SPEED -	ULS V2000 SLS V20	48m∕s 37m∕s.
7.	EARTHQUAKE LOADII ACCELERATION CO SITE FACTOR, S SUB SOIL CLASS SPECTRAL SHAPE BRIDGE CLASSIFIC IMPORTANCE FAC BRIDGE EARTHQU	0.09 1.25 Ce 3.68 TYPE 2 1.0 BEDC-2	
8.	DIFFERENTIAL SETTL	EMENT ALLOWANCE	20mm.
<u>GE</u>	OTECHNICAL SU	MMARY_	
1.	BULK SOIL UNIT WE	GHT	18kN∕m³ (DRY) 20kN∕m³ (SATURATED)
2.	ANGLE OF INTERNAL	FRICTION	33° – 38° (SUB SURFACE) 36° (SELECT BACKFILL)
3.	COHESION		NIL

4. GEOTECHNICAL STRENGTH REDUCTION FACTOR 0.55

ESTERN AUSTRALIA NORTHLINK WA CENTRAL SECTION					1:100 ⊓ 0
(112) CITY OF BAYSWATER METROPOLITAN REGION METROPOLITAN REGION 1830-0879 PRECENTINE NORTHLINK WA CENTRAL SECTION					SHEET
1830-0879		(112) CITY			REGION
INORTHLINK WA CENTRAL SECTION				1830-0879)
	mainroads		K WA CEN	ITRAL SECTIC	N
GENERAL ARRANGEMENT - SHEET 1	YERY DIRECTORATE	REID / TONKIN IN UNDERPASS No. GENERAL ARRAN	TÈRCHÁNGE 9450	ET 1	
23.01.16 DATE 23.01.18 DATE NL2-AAJ-DRG-0160-UP-0010		DRAWING No. NL2-A	AJ-DRG-	0160-UP-0010) ^{rev}

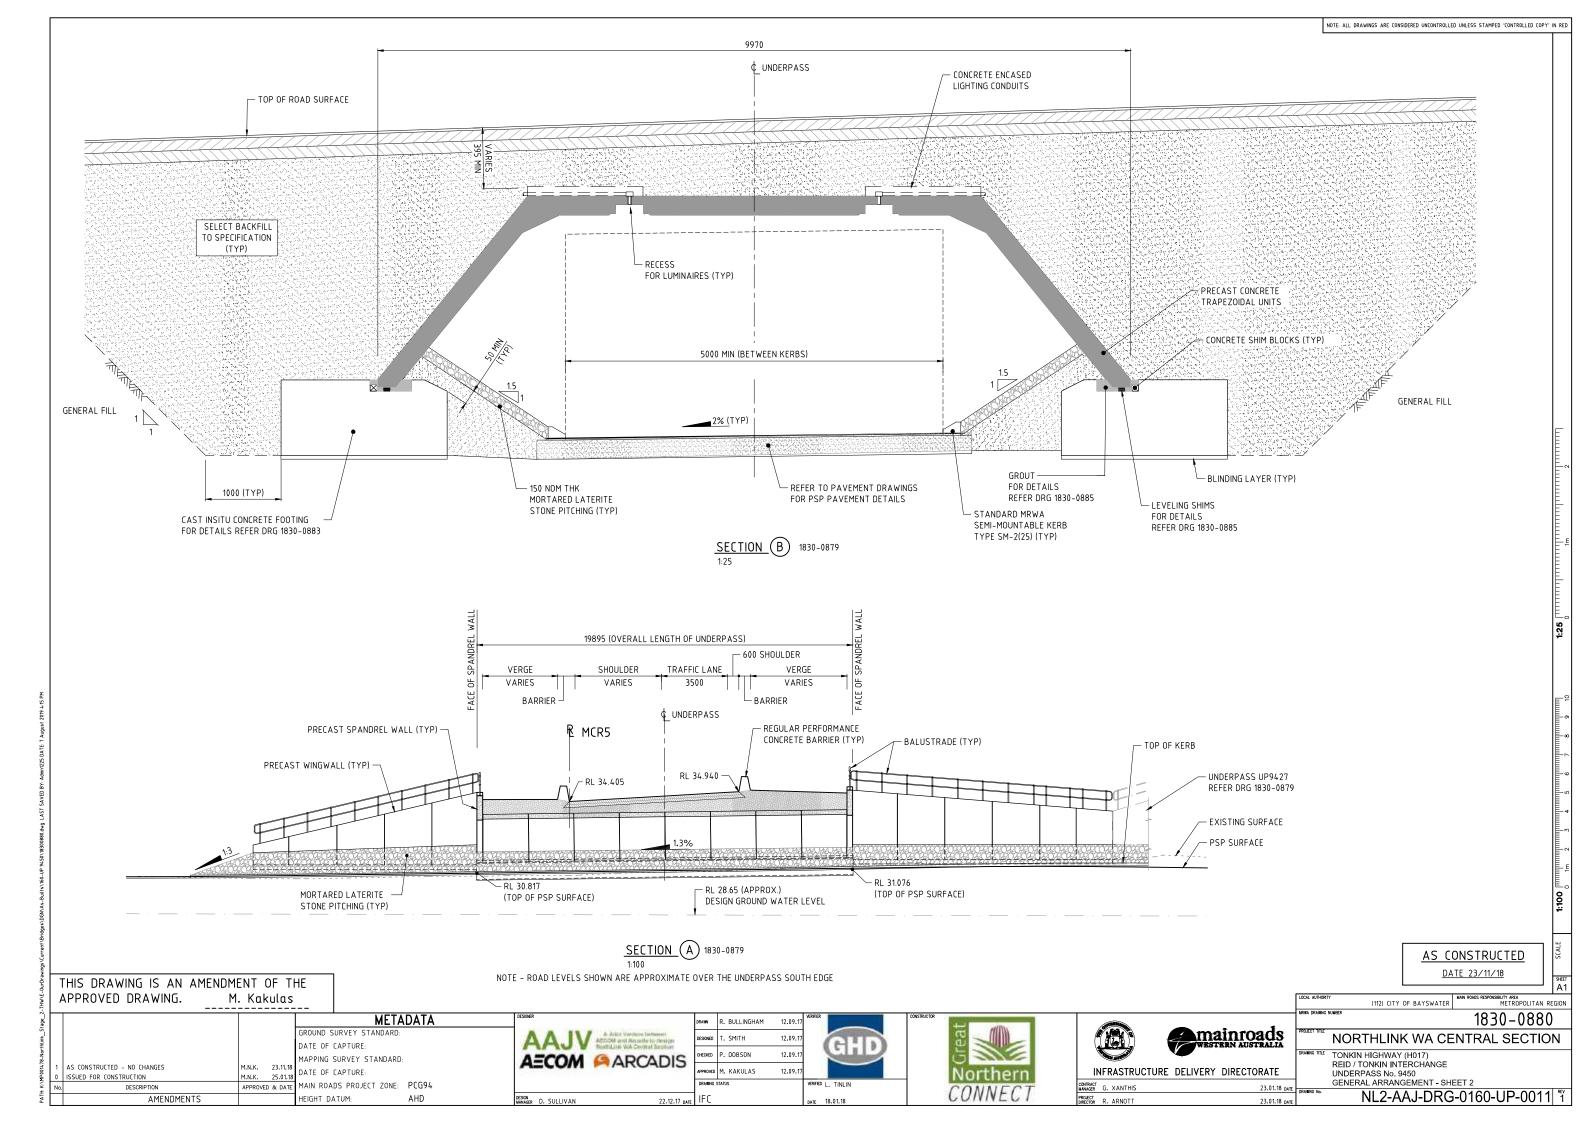


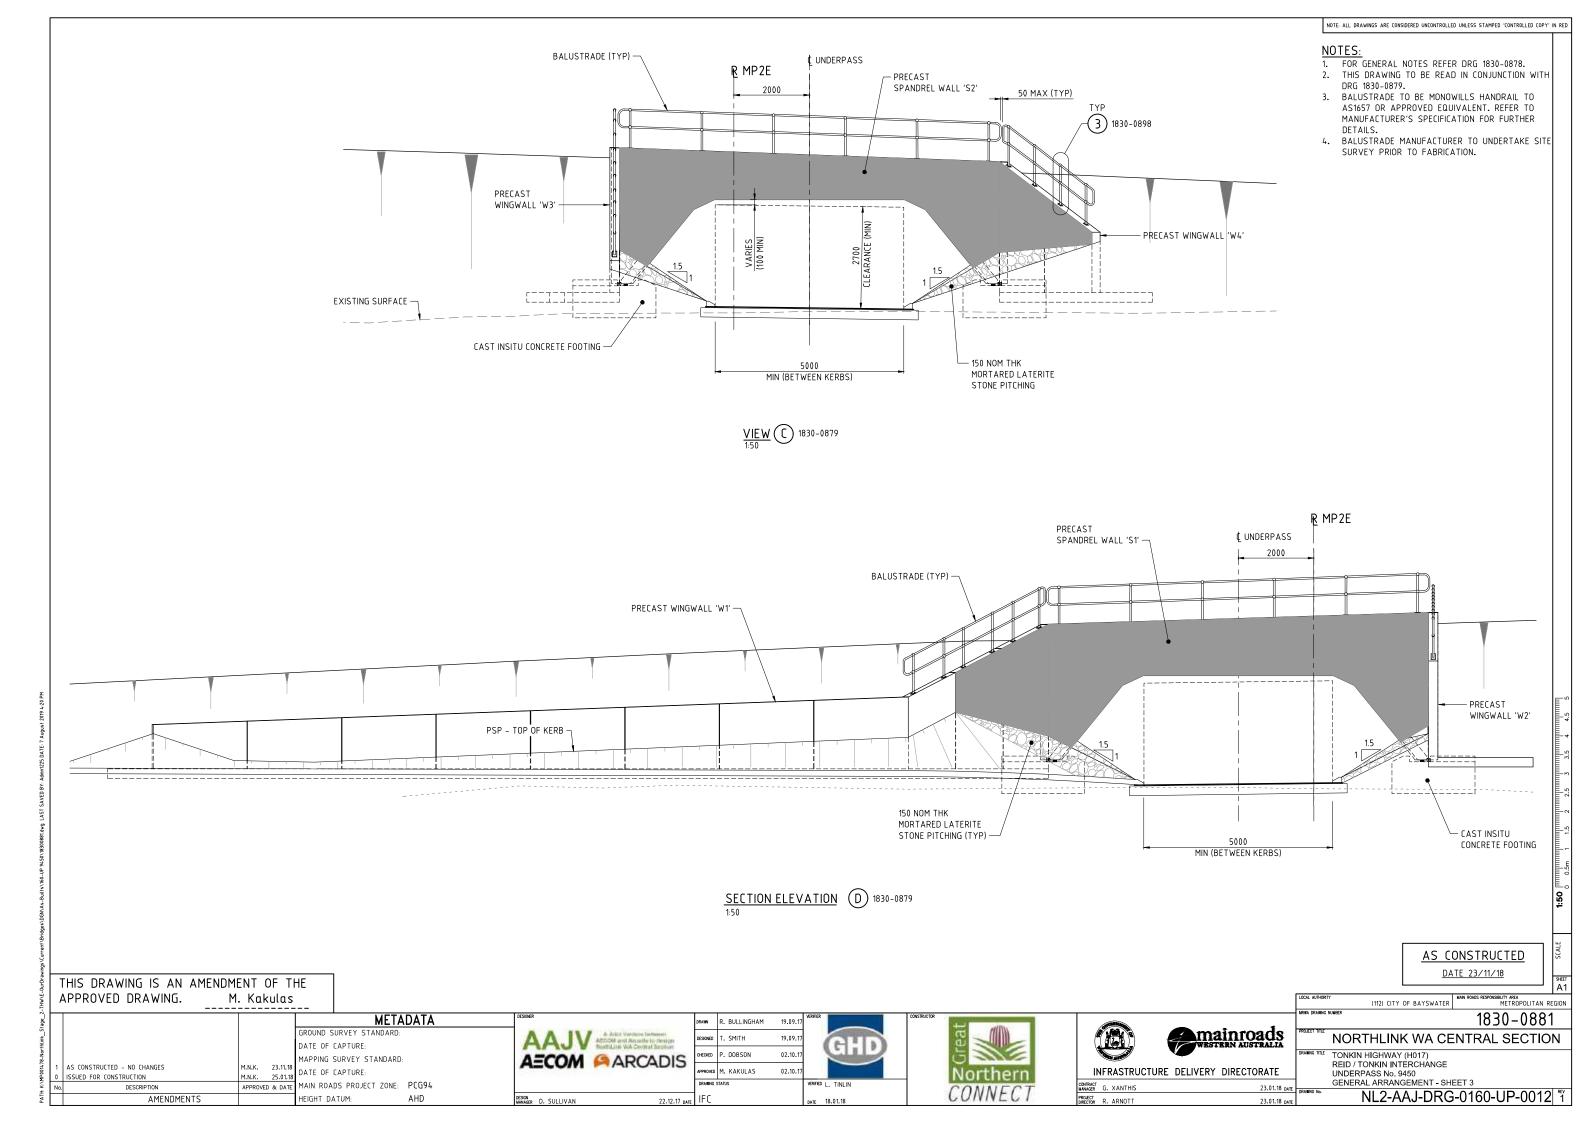

DRAWING INDEX		
DRAWING NUMBER	MRWA DRAWING NUMBER	
NL2-AAJ-DRG-0140-UP-0001	1830-0720	LOCALITY PLAN
NL2-AAJ-DRG-0140-UP-0002	1830-0721	INDEX
NL2-AAJ-DRG-0140-UP-0005	1830-0722	GENERAL NOTES
NL2-AAJ-DRG-0140-UP-0010	1830-0723	GENERAL ARRANGEMENT - SHEET 1
NL2-AAJ-DRG-0140-UP-0011	1830-0724	GENERAL ARRANGEMENT - SHEET 2
NL2-AAJ-DRG-0140-UP-0013	1830-0725	BOREHOLE DATA
NL2-AAJ-DRG-0140-UP-0015	1830-0726	FOOTING CONCRETE DETAILS
NL2-AAJ-DRG-0140-UP-0020	1830-0727	FOOTING REINFORCEMENT DETAILS
NL2-AAJ-DRG-0140-UP-0025	1830-0728	TRAPEZOIDAL UNIT LAYOUT AND DETAILS
NL2-AAJ-DRG-0140-UP-0030	1830-0729	TRAPEZOIDAL UNIT CONCRETE DETAILS
NL2-AAJ-DRG-0140-UP-0035	1830-0730	TRAPEZOIDAL UNIT REINFORCEMENT DETAILS - SHEE
NL2-AAJ-DRG-0140-UP-0036	1830-0731	TRAPEZOIDAL UNIT REINFORCEMENT DETAILS - SHEE
NL2-AAJ-DRG-0140-UP-0040	1830-0732	SPANDREL WALL LAYOUT AND DETAILS
NL2-AAJ-DRG-0140-UP-0045	1830-0733	SPANDREL WALL CONCRETE DETAILS
NL2-AAJ-DRG-0140-UP-0046	1830-0734	SPANDREL WALL REINFORCEMENT DETAILS
NL2-AAJ-DRG-0140-UP-0050	1830-0735	SPANDREL INSTALLATION BRACKET DETAILS
NL2-AAJ-DRG-0140-UP-0074	1830-0736	WING WALL LAYOUT
NL2-AAJ-DRG-0140-UP-0075	1830-0737	WING WALL CONCRETE DETAILS - SHEET 1
NL2-AAJ-DRG-0140-UP-0076	1830-0738	WING WALL CONCRETE DETAILS - SHEET 2
NL2-AAJ-DRG-0140-UP-0077	1830-0739	WING WALL CONCRETE DETAILS – SHEET 3
NL2-AAJ-DRG-0140-UP-0078	1830-0740	WING WALL CONCRETE DETAILS - SHEET 4
NL2-AAJ-DRG-0140-UP-0080	1830-0741	WING WALL REINFORCEMENT DETAILS - SHEET 1
NL2-AAJ-DRG-0140-UP-0081	1830-0742	WING WALL REINFORCEMENT DETAILS - SHEET 2
NL2-AAJ-DRG-0140-UP-0090	1830-0743	LUMINAIRE DETAILS
NL2-AAJ-DRG-0140-UP-0100	1830-0744	DESIGN SUMMARY – SHEET 1 (TO FOLLOW)
NL2-AAJ-DRG-0140-UP-0101	1830-0745	DESIGN SUMMARY - SHEET 2 (TO FOLLOW)




		SCALE
[LOCAL AUTHORITY (109) CITY OF SWAN MAN ROADS RESPONSELITY AREA METROPOLITAN REC	SHEET A1 GION
mainroads	HEYERA DRAVING INMEER 1830-0721 REOJECT TITLE NORTHLINK WA CENTRAL SECTION	N
ERY DIRECTORATE	DRAWING TITLE TONKIN HIGHWAY (H017) REID / TONKIN INTERCHANGE UNDERPASS No. 9430 INDEX	
13.10.17 date	DRAWING No. NL2-AAJ-DRG-0140-UP-0002	^{REV}

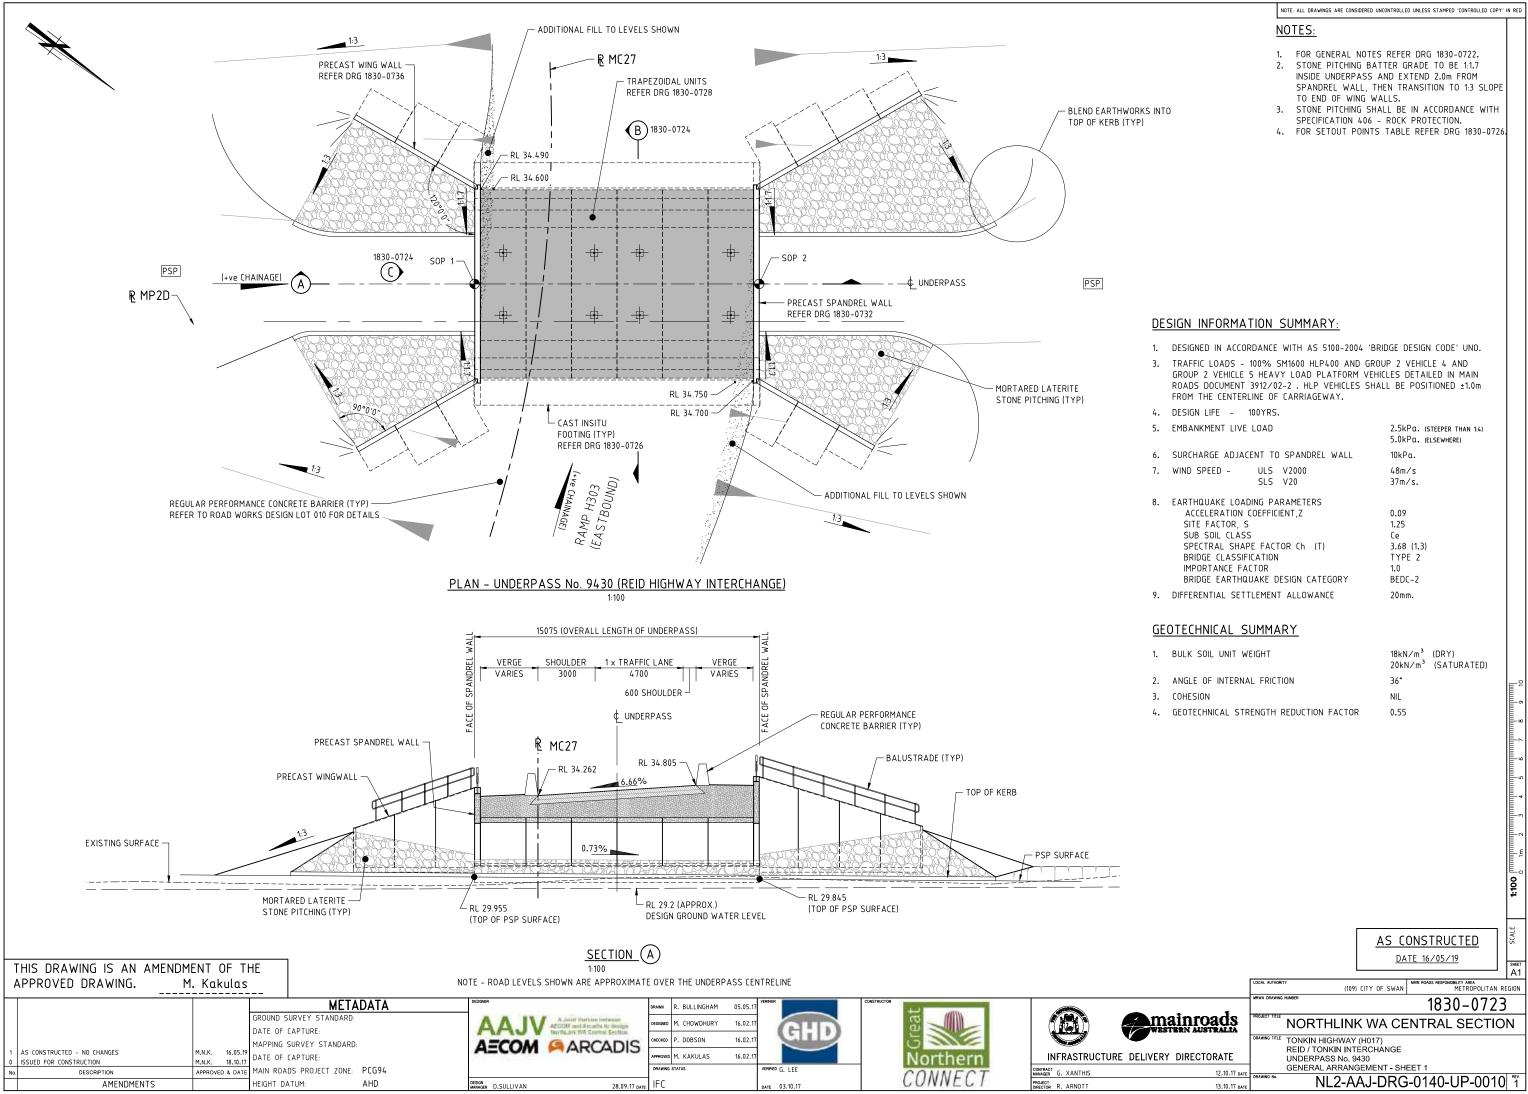

	NOTE: ALL DRAWINGS ARE CONSIDERED UNCONTROLLED UNLESS STAMPED 'CONTROLLED COPY' IN REL
	NOTES:
	 FOR GENERAL NOTES REFER DRG 1830-0722. STONE PITCHING BATTER GRADE TO BE 1:1.7 INSIDE UNDERPASS AND EXTEND 2.0m FROM SPANDREL WALL, THEN TRANSITION TO 1:3 SLOPE TO END OF WING WALLS.
INTO	 STONE PITCHING SHALL BE IN ACCORDANCE WITH SPECIFICATION 406 - ROCK PROTECTION. FOR SETOUT POINTS TABLE REFER DRG 1830-0726.


1.	DESIGNED IN ACCORDANCE WITH AS 5100-2004	BRIDGE DESIGN CODE' LIND	
3.	TRAFFIC LOADS - 100% SM1600 HLP400 AND C GROUP 2 VEHICLE 5 HEAVY LOAD PLATFORM V ROADS DOCUMENT 3912/02-2 . HLP VEHICLES S FROM THE CENTERLINE OF CARRIAGEWAY.	GROUP 2 VEHICLE 4 AND 'EHICLES DETAILED IN MAIN	
4.	DESIGN LIFE - 100YRS.		
5.	EMBANKMENT LIVE LOAD	2.5kPa. (STEEPER THAN 1:4) 5.0kPa. (ELSEWHERE)	
6.	SURCHARGE ADJACENT TO SPANDREL WALL	10kPa.	
7.	WIND SPEED - ULS V2000 SLS V20	48m∕s 37m∕s.	
8.	EARTHQUAKE LOADING PARAMETERS ACCELERATION COEFFICIENT,Z SITE FACTOR, S SUB SOIL CLASS SPECTRAL SHAPE FACTOR (h (T) BRIDGE CLASSIFICATION IMPORTANCE FACTOR BRIDGE EARTHQUAKE DESIGN CATEGORY	0.09 1.25 Ce 3.68 (1.3) TYPE 2 1.0 BEDC-2	
9.	DIFFERENTIAL SETTLEMENT ALLOWANCE	20mm.	
<u>GE</u>	DTECHNICAL SUMMARY		
1.	BULK SOIL UNIT WEIGHT	18kN∕m³ (DRY) 20kN∕m³ (SATURATED)	
2.	ANGLE OF INTERNAL FRICTION	36°	F
3.	COHESION	NIL	E
4.	GEOTECHNICAL STRENGTH REDUCTION FACTOR	0.55	
		AS CONSTRUCTED	SCALE

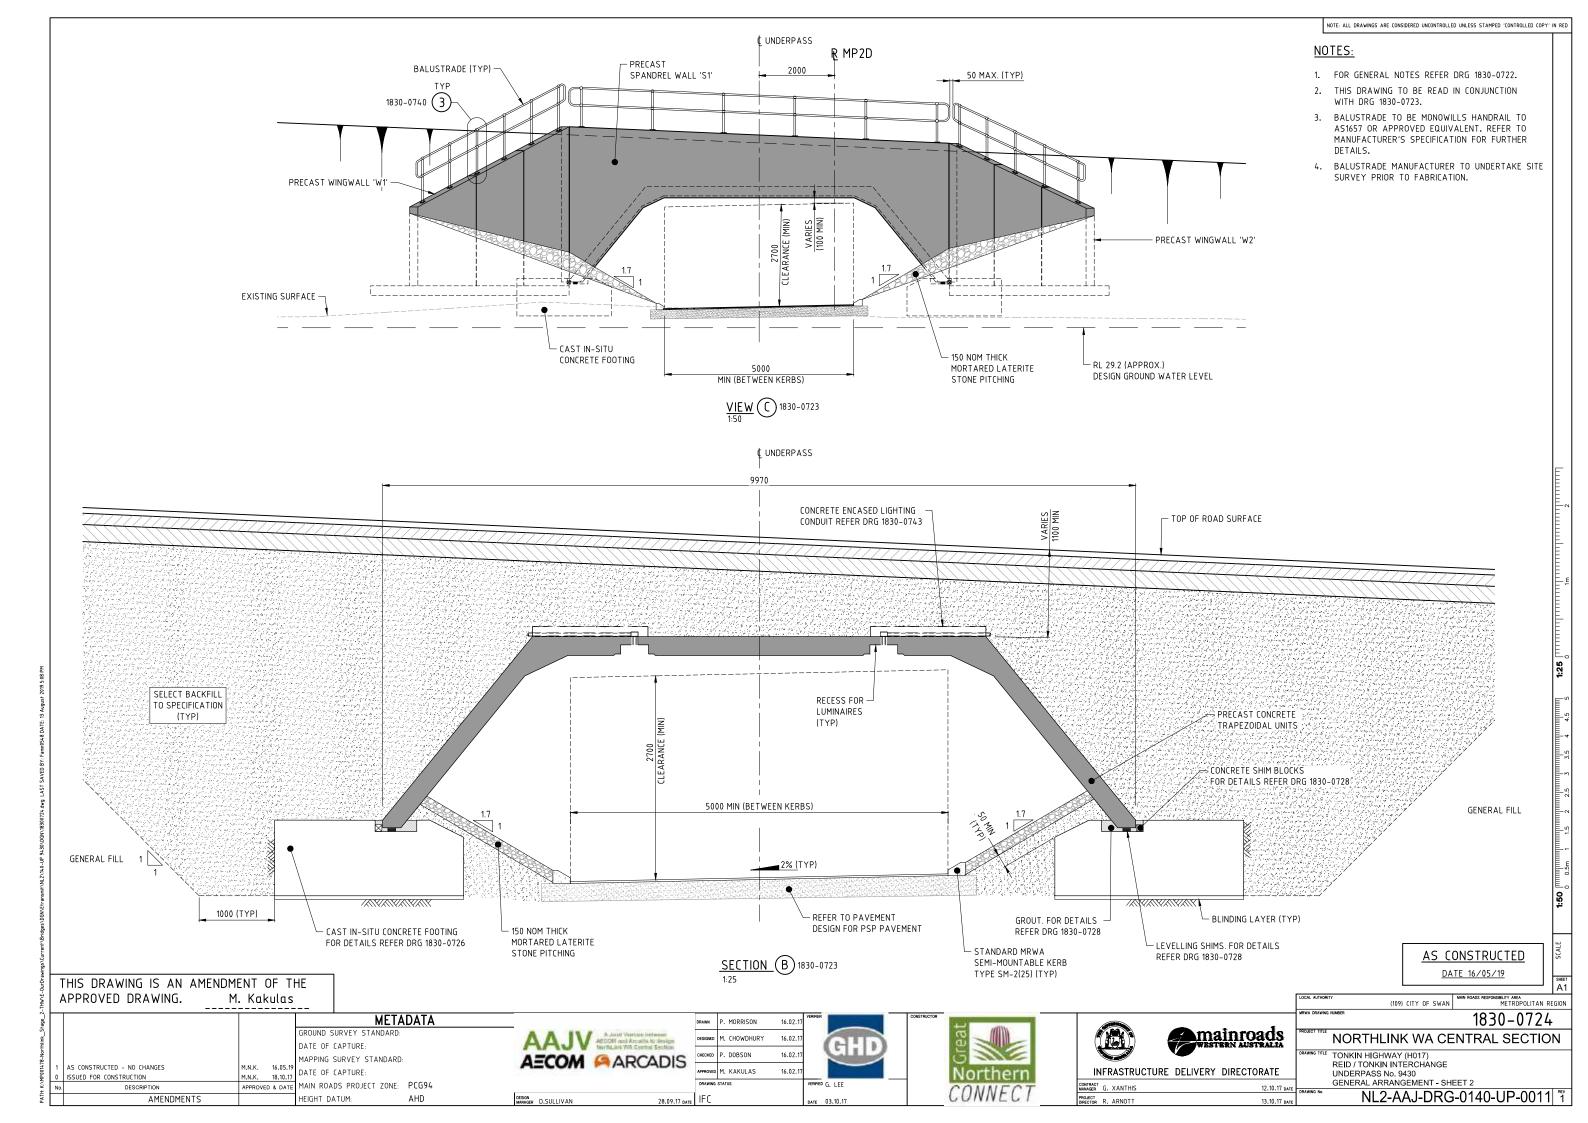


DRAWING INDEX		
DRAWING NUMBER	MRWA DRG No.	DRAWING DESCRIPTION
NL2-AAJ-DRG-0145-UP-0001	1830-0748	LOCALITY PLAN
NL2-AAJ-DRG-0145-UP-0002	1830-0749	INDEX
NL2-AAJ-DRG-0145-UP-0005	1830-0750	GENERAL NOTES
NL2-AAJ-DRG-0145-UP-0010	1830-0751	GENERAL ARRANGEMENT - SHEET 1
NL2-AAJ-DRG-0145-UP-0011	1830-0752	GENERAL ARRANGEMENT - SHEET 2
NL2-AAJ-DRG-0145-UP-0013	1830-0753	BOREHOLE DATA
NL2-AAJ-DRG-0145-UP-0015	1830-0754	FOOTING CONCRETE DETAILS
NL2-AAJ-DRG-0145-UP-0020	1830-0755	FOOTING REINFORCEMENT DETAILS
NL2-AAJ-DRG-0145-UP-0025	1830-0756	TRAPEZOIDAL UNIT LAYOUT AND DETAILS
NL2-AAJ-DRG-0145-UP-0030	1830-0757	TRAPEZOIDAL UNIT CONCRETE DETAILS
NL2-AAJ-DRG-0145-UP-0035	1830-0758	TRAPEZOIDAL UNIT REINFORCEMENT DETAILS - SHEET 1
NL2-AAJ-DRG-0145-UP-0036	1830-0759	TRAPEZOIDAL UNIT REINFORCEMENT DETAILS - SHEET 2
NL2-AAJ-DRG-0145-UP-0040	1830-0760	SPANDREL WALL LAYOUT AND DETAILS
NL2-AAJ-DRG-0145-UP-0045	1830-0761	SPANDREL WALL CONCRETE DETAILS
NL2-AAJ-DRG-0145-UP-0046	1830-0762	SPANDREL WALL REINFORCEMENT DETAILS
NL2-AAJ-DRG-0145-UP-0050	1830-0763	SPANDREL INSTALLATION BRACKET DETAILS
NL2-AAJ-DRG-0145-UP-0074	1830-0764	WING WALL LAYOUT
NL2-AAJ-DRG-0145-UP-0075	1830-0765	WING WALL CONCRETE DETAILS - SHEET 1
NL2-AAJ-DRG-0145-UP-0076	1830-0766	WING WALL CONCRETE DETAILS - SHEET 2
NL2-AAJ-DRG-0145-UP-0077	1830-0767	WING WALL CONCRETE DETAILS - SHEET 3
NL2-AAJ-DRG-0145-UP-0078	1830-0768	WING WALL CONCRETE DETAILS - SHEET 4
NL2-AAJ-DRG-0145-UP-0080	1830-0769	WING WALL REINFORCEMENT DETAILS - SHEET 1
NL2-AAJ-DRG-0145-UP-0081	1830-0770	WING WALL REINFORCEMENT DETAILS - SHEET 2
NL2-AAJ-DRG-0145-UP-0090	1830-0771	LUMINAIRE DETAILS
NL2-AAJ-DRG-0145-UP-0100	1830-0772	DESIGN SUMMARY - SHEET 1 (TO FOLLOW)
NL2-AAJ-DRG-0145-UP-0101	1830-0773	DESIGN SUMMARY - SHEET 2 (TO FOLLOW)



	AS CONSTRUCTED	SCALE
	LOCH. AUTHORTY (109) CITY OF SWAN MAIN ROADS RESPONSIBILITY AREA METROPOLITAN RE	SHEET A1
	MRRA DRAINING NAMEER 1830-0749	
MAINFOADS	DRAINING TILE TONKIN HIGHWAY (H017)	N
ERY DIRECTORATE	REID / TONKIN INTERCHANGE UNDERPASS No. 9431	
26.10.17 date 31.10.17 date	INDEX INDEX NL2-AAJ-DRG-0145-UP-0002	^{rev}

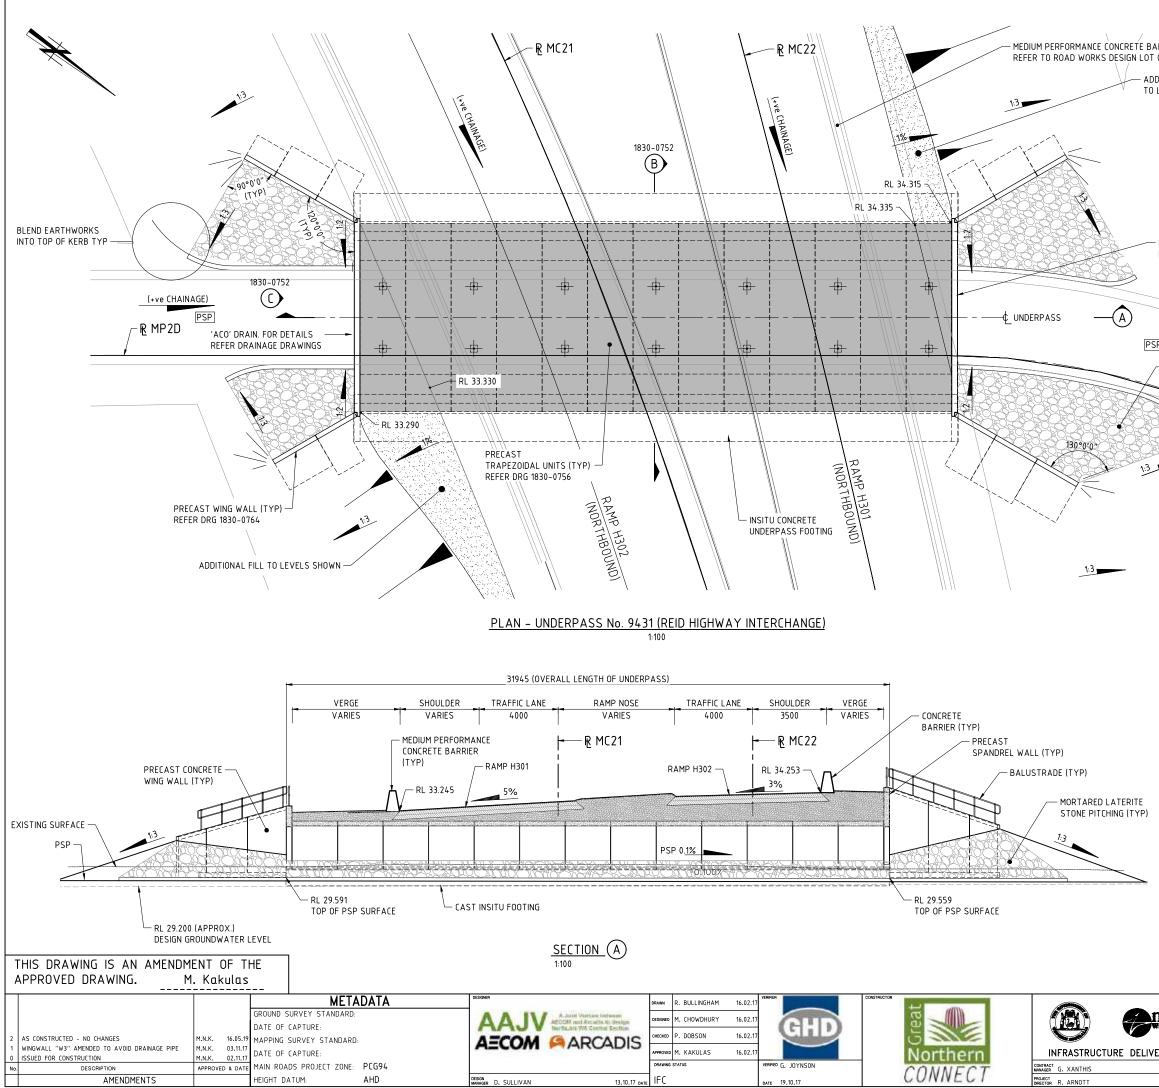


ARRIER (TYP) 010 FOR DETAILS DITIONAL FILL LEVELS SHOWN	SPANDREL WALL, THE TO END OF WING WAL 3. STONE PITCHING SHAL SPECIFICATION 406 -	ER GRADE TO BE 1:2 ID EXTEND 2.0m FROM N TRANSITION TO 1:3 SLOPE LS. L BE IN ACCORDANCE WITH	
- PRECAST SPANDREL WAL REFER DRG 1830–0760	L (TYP)		
Ī			
/ MORTARED LATERITE STONEPITCHING (TYP)			
DESIGN INFORMA	TION SUMMARY:		
 TRAFFIC LOADS - GROUP 2 VEHICLE ROADS DOCUMENT FROM THE CENTER 	DRDANCE WITH AS 5100-2004 100% SM1600 HLP400 AND 5 HEAVY LOAD PLATFORM 3912/02-2 . HLP VEHICLES RLINE OF CARRIAGEWAY.	GROUP 2 VEHICLE 4 AND /EHICLES DETAILED IN MAIN	
4. DESIGN LIFE – 5. EMBANKMENT LIVI		2.5kPa. (STEEPER THAN 1:4) 5.0kPa. (ELSEWHERE)	
 SURCHARGE ADJA WIND SPEED - 	CENT TO SPANDREL WALL ULS V2000 SLS V20	10kPa. 48m/s 37m/s.	10
ACCELERATION SITE FACTOR, SUB SOIL CLAS SPECTRAL SHA BRIDGE CLASSI IMPORTANCE F/	S SS PE FACTOR Ch (T) FICATION	0.09 1.25 Ce 3.68 (1.3) TYPE 2 1.0 BEDC-2	1111111111111111111111111111111111111
	TLEMENT ALLOWANCE	20mm.	7 4
<u>GEOTECHNICAL</u>	SUMMARY		2 2
1. BULK SOIL UNIT V	VEIGHT	18kN∕m³ (DRY) 20kN∕m³ (SATURATED)	0 1m
 ANGLE OF INTERN COHESION 	AL FRICTION	36° NIL	1:100
	RENGTH REDUCTION FACTOR	0.55	
		AS CONSTRUCTED DATE 16/05/19	SCALE
			sheet A1
	CAL AUTHORITY (109) CITY O	F SWAN MAN ROADS RESPONSIBILITY AREA METROPOLITAN R 1830-075'	
MAINIOAUS Western Australia		A CENTRAL SECTIO	
	AWWIG TITLE TONKIN HIGHWAY (H017 REID / TONKIN INTERCH UNDERPASS No. 9431		
26.10.17 date dr		NT - SHEET 1 DRG-0145-UP-0010	^{REV} 2
31.10.17 date			 ∠

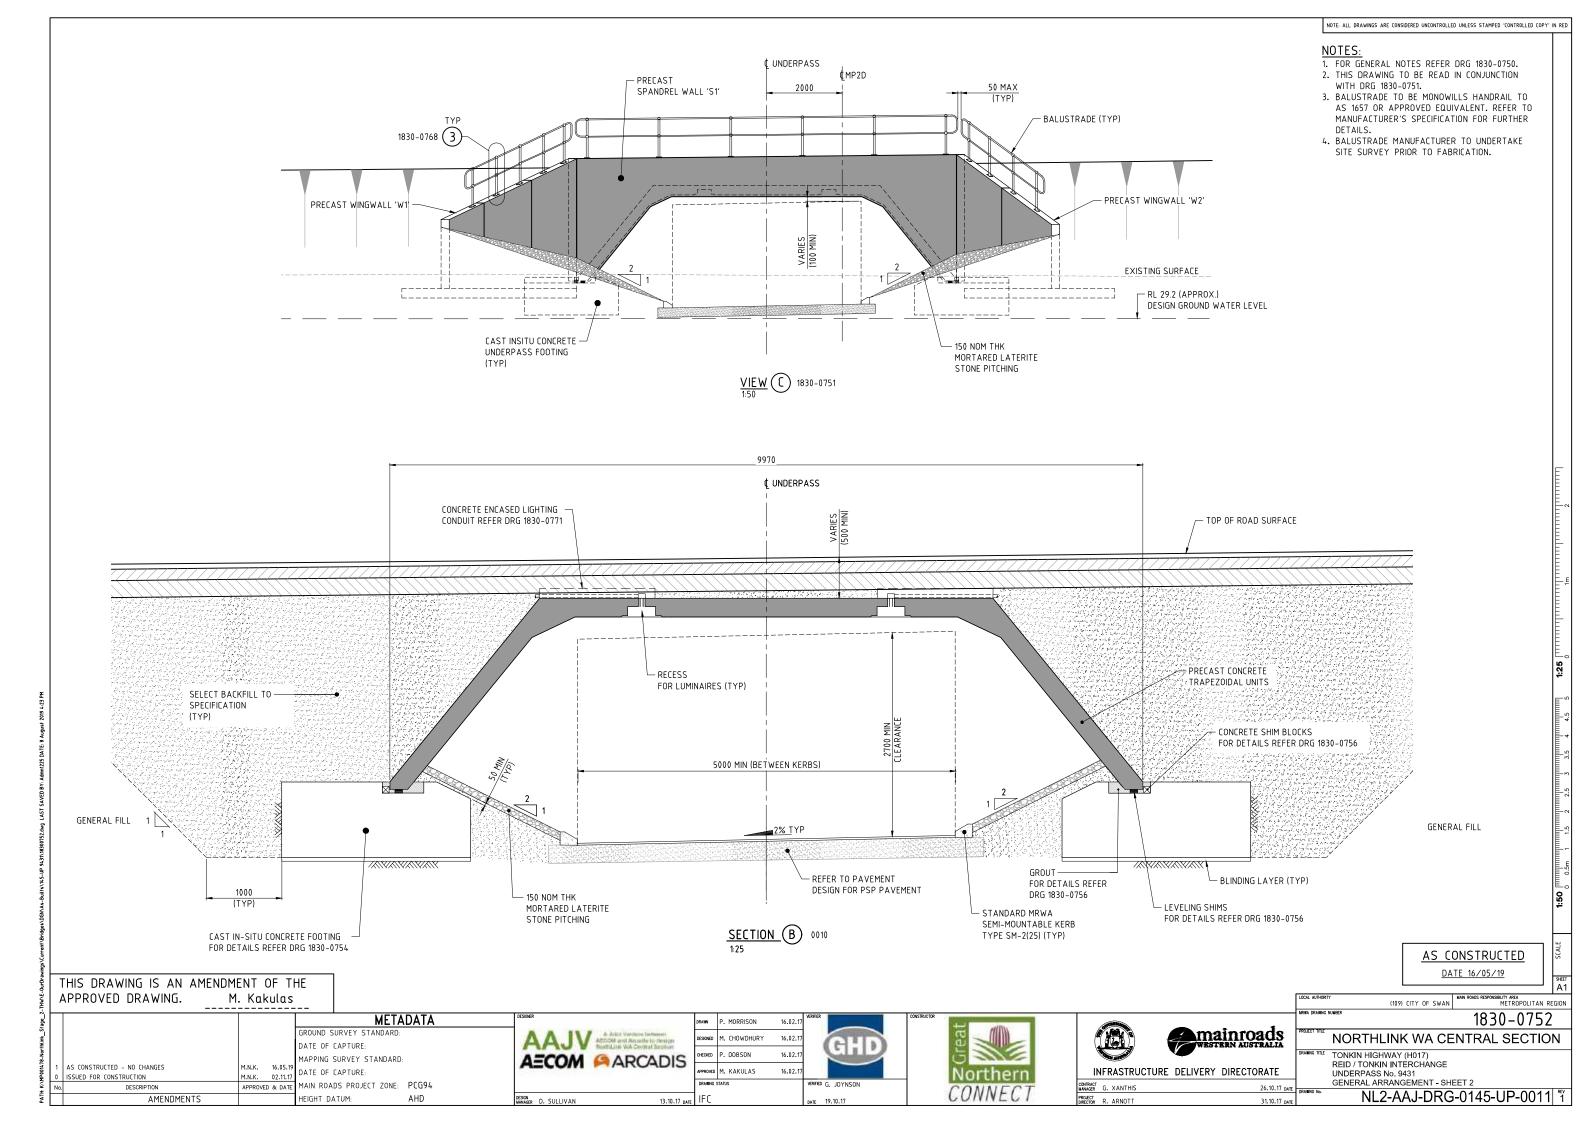



DRAWING NUMBER	MRWA DRAWING No	DRAWING DESCRIPTION	DRAWING NUMBER	MRWA DRAWING No	DRAWING DESCRIPTION
GENERAL					
NL2-AAJ-DRG-0170-BR-0001	1830-0908	LOCALITY PLAN	NL2-AAJ-DRG-0170-BR-0090	1830-0950	APPROACH SLAB CONCRETE DETAILS
NL2-AAJ-DRG-0170-BR-0007	1830-0909	INDEX	NL2-AAJ-DRG-0170-BR-0091	1830-0951	APPROACH SLAB REINFORCEMENT DETAILS
NEZ-AAJ-DRU-0170-DR-0002	10,50-0,50,5	INDEX			
NL2-AAJ-DRG-0170-BR-0005	1830-0910	GENERAL NOTES – SHEET 1	NL2-AAJ-DRG-0170-BR-0100	1830-0952	EXPANSION JOINT DETAILS - SHEET 1
NL2-AAJ-DRG-0170-BR-0006	1830-0911	GENERAL NOTES - SHEET 2	NL2-AAJ-DRG-0170-BR-0101	1830-0953	EXPANSION JOINT DETAILS - SHEET 2
NL2-AAJ-DRG-0170-BR-0010	1830-0912	GENERAL ARRANGEMENT - SHEET 1	NL2-AAJ-DRG-0170-BR-0105	1830-0954	COVER PLATE DETAILS - SHEET 1
NL2-AAJ-DRG-0170-BR-0011	1830-0913	GENERAL ARRANGEMENT - SHEET 2	NL2-AAJ-DRG-0170-BR-0106	1830-0955	COVER PLATE DETAILS - SHEET 2
NL2-AAJ-DRG-0170-BR-0012	1830-0914	GENERAL ARRANGEMENT - SHEET 3			
			NL2-AAJ-DRG-0170-BR-0110	1830-0956	BARRIER LAYOUT
SUBSTRUCTURE			NL2-AAJ-DRG-0170-BR-0111	1830-0957	BARRIER DETAILS – SHEET 1
	10.20 0.015		NL2-AAJ-DRG-0170-BR-0112	1830-0958	BARRIER DETAILS – SHEET 2
NL2-AAJ-DRG-0170-BR-0015	1830-0915	BORE INFORMATION - SHEET 1			
NL2-AAJ-DRG-0170-BR-0016	1830-0916	BORE INFORMATION - SHEET 2	NL2-AAJ-DRG-0170-BR-0115	1830-0959	PRECAST CONCRETE PARAPET DETAILS – SHEET 1
NL2-AAJ-DRG-0170-BR-0017	1830-0917	GEOMETRIC DATA	NL2-AAJ-DRG-0170-BR-0116	1830-0960	PRECAST CONCRETE PARAPET DETAILS - SHEET 2
NL2-AAJ-DRG-0170-BR-0020	1830-0918	ABUTMENT – MSE WALL LAYOUT	NL2-AAJ-DRG-0170-BR-0135	1830-0961	LIGHTING AND ELECTRICAL LAYOUT
NL2-AAJ-DRG-0170-BR-0020	1830-0919	ABUTMENT PHISE WALL LATOOT	NL2-AAJ-DRG-0170-BR-0136	1830-0962	UNDER BRIDGE LIGHTING DETAILS
NL2-AAJ-DRG-0170-BR-0022	1830-0920	ABUTMENT No. 2 - MSE WALL	NL2-AAJ-DRG-0170-BR-0137	1830-0963	LUMINAIRE BRACKET DETAILS
NI 2-AA J-DRG-0170-BR-0023	1830-0921	ABUTMENT - MSE WALL TYPICAL DETAILS		1050-0705	
NL2-AAJ-DRG-0170-BR-0024	1830-0922	COLUMN FORMER DETAILS	NL2-AAJ-DRG-0170-BR-0145	1830-0964	PRIVACY SCREEN DETAILS – SHEET 1
NL2-AAJ-DRG-0170-BR-0025	1830-0923	ABUTMENT No. 1 - CONCRETE DETAILS	NL2-AAJ-DRG-0170-BR-0146	1830-0965	PRIVACY SCREEN DETAILS - SHEET 2
NL2-AAJ-DRG-0170-BR-0026	1830-0924	ABUTMENT No. 2 - CONCRETE DETAILS	NL2-AAJ-DRG-0170-BR-0147	1830-0966	PRIVACY SCREEN DETAILS - SHEET 3
NL2-AAJ-DRG-0170-BR-0027	1830-0925	ABUTMENT - TYPICAL CONCRETE DETAILS		1050-0700	TRIVACT SCREEN DETAILS - SHEET S
NL2-AAJ-DRG-0170-BR-0028	1830-0926	WING WALL DETAILS	NL2-AAJ-DRG-0170-BR-0150	1830-0967	STAIRS PLAN & PROFILE – SHEET 1
NL2-AAJ-DRG-0170-BR-0029	1830-0927	WING WALL REINFORCEMENT DETAILS	NL2-AAJ-DRG-0170-BR-0151	1830-0968	STAIRS PLAN & PROFILE - SHEET 2
NL2-AAJ-DRG-0170-BR-0030	1830-0928	ABUTMENT - REINFORCEMENT DETAILS - SHEET 1	NL2-AAJ-DRG-0170-BR-0152	1830-0969	STAIRS REINFORCEMENT
NL2-AAJ-DRG-0170-BR-0031	1830-0929	ABUTMENT - REINFORCEMENT DETAILS - SHEET 2	NL2-AAJ-DRG-0170-BR-0153	1830-0970	STAIRS DETAILS & HANDRAIL – SHEET 1
			NL2-AAJ-DRG-0170-BR-0154	1830-0971	STAIRS DETAILS & HANDRAIL - SHEET 2
NL2-AAJ-DRG-0170-BR-0033	1830-0930	COLUMN REINFORCEMENT DETAILS			
			NL2-AAJ-DRG-0170-BR-0155	1830-0972	DESIGN SUMMARY – SHEET 1
NL2-AAJ-DRG-0170-BR-0035	1830-0931	PIER – CONCRETE DETAILS – SHEET 1	NL2-AAJ-DRG-0170-BR-0156	1830-0973	DESIGN SUMMARY – SHEET 2
NL2-AAJ-DRG-0170-BR-0036	1830-0932	PIER – CONCRETE DETAILS – SHEET 2			
NL2-AAJ-DRG-0170-BR-0037	1830-0933	PIER – REINFORCEMENT DETAILS – SHEET 1	MRWA STANDARD		
NL2-AAJ-DRG-0170-BR-0038	1830-0934	PIER – REINFORCEMENT DETAILS – SHEET 2	DRAWINGS		
			Browniese	0430-0760	REGULAR PERFORMANCE LEVEL BARRIER
SUPERSTRUCTURE					RAIL ELEVATIONS AND DETAILS
	1020 0025		_	0430-0761-1	REGULAR PERFORMANCE LEVEL BARRIER
NL2-AAJ-DRG-0170-BR-0045	1830-0935	BEARING DETAILS - SHEET 1			TRANSITION RAIL ELEVATIONS
NL2-AAJ-DRG-0170-BR-0046	1830-0936	BEARING DETAILS - SHEET 2	-	0430-0762-1	REGULAR PERFORMANCE LEVEL BARRIER
	1020 0027				GUARDRAIL POST DETAILS
NL2-AAJ-DRG-0170-BR-0050	1830-0937	PRECAST TEEROFF BEAM LAYOUT	-	0430-0766-2	REGULAR PERFORMANCE LEVEL BARRIER
	1020 0020				THREE AND FOUR RAIL BARRIER TRANSITION
NL2-AAJ-DRG-0170-BR-0052 NL2-AAJ-DRG-0170-BR-0053	1830-0938 1830-0939	PRECAST TEEROFF - TYPICAL DETAILS PRECAST TEEROFF - CONCRETE DETAILS	-	0430-1213-1	REGULAR PERFORMANCE LEVEL BARRIER INSTALLATION DE
NLZ-AAJ-DRG-0170-DR-0055	1020-0229	PRECAST TEEROFF - CONCRETE DETAILS	-	0430-1314	PRECAST PARAPET PANELS
NL2-AAJ-DRG-0170-BR-0057	1830-0940	PRECAST TEEROFF - PRESTRESSING DETAILS - SHEET 1	-	0530-1087-1	BRIDGE BALUSTRADE FOR PRINCIPAL SHARED PATHS - SH
NL2-AAJ-DRG-0170-BR-0058	1830-0941	PRECAST TEEROFF - PRESTRESSING DETAILS - SHEET 2	-	0530-1307-1	BRIDGE BALUSTRADE FOR PRINCIPAL SHARED PATHS - SH
	1030-0941	FRECAST TELEVIT - FRESTRESSING DETAILS - SHELT Z	-	0630-1901	BRIDGE LIGHT POLE BASE – SHEET 1
NL2-AAJ-DRG-0170-BR-0060	1830-0942	PRECAST TEEROFF - REINFORCEMENT DETAILS - SHEET 1	-	0630-1902	BRIDGE LIGHT POLE BASE – SHEET 2
NL2-AAJ-DRG-0170-BR-0060	1830-0942	PRECAST TEEROFF - REINFORCEMENT DETAILS - SHEET T			
NL2-AAJ-DRG-0170-BR-0061	1830-0944	PRECAST TEEROFF - REINFORCEMENT DETAILS - SHEET 2 PRECAST TEEROFF - REINFORCEMENT DETAILS - SHEET 3			
	1030-0744	TREAST TERMIT REIN ORCHENT DETAILS - SHEET J			
NL2-AAJ-DRG-0170-BR-0070	1830-0945	DECK CONCRETE DETAILS – SHEET 1			
NL2-AAJ-DRG-0170-BR-0071	1830-0946	DECK CONCRETE DETAILS - SHEET 2			
NL2-AAJ-DRG-0170-BR-0072	1830-0947	DECK CONCRETE DETAILS - SHEET 3			
NL2-AAJ-DRG-0170-BR-0073	1830-0948	DECK REINFORCEMENT DETAILS - SHEET 1			
NL2-AAJ-DRG-0170-BR-0074	1830-0949	DECK REINFORCEMENT DETAILS - SHEET 2			

2-THW\E-OurDrawin	THIS DRAWING IS A	AN AMENDMENT OF TH G. M. Kakulas													
-Northlink_Stage_		C	META GROUND SURVEY STANDARD: DATE OF CAPTURE: MAPPING SURVEY STANDARD:		AAJV	A Adol Various between ACCOM and Accellents Design Notificies WA Contral Section	DESIGNED S	. ALPAPARA 5. SERGEEV 1. KAKULAS	19.09.17 19.09.17 19.09.17 19.09.17	GHD	CONSTRUCTOR	ireat			
4: K:\MP001478	1 AS CONSTRUCTED - NO CHANGES 0 ISSUED FOR CONSTRUCTION No. DESCRIPTION	M.N.K. 30.01.19 M.N.K. 21.02.18	MAPPING SORVET STANDARD DATE OF CAPTURE: MAIN ROADS PROJECT ZONE:		A=COM	ARCADIS	APPROVED M	1. KAKULAS TUS	19.09.17 VER	SFIED L. TINLIN	_	Northern		INFRASTRUCT	URE DELIVER
PATH	AMEN	DMENTS +	HEIGHT DATUM:	AHD	DESIGN MANAGER D. SULLIVAN	02.02.18 date	IFC		DAT	E 08.02.18		CONNECT	PROJECT	R R. ARNOTT	

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	A	₩ ₩ 1 1
	LOCAL AUTHORITY (109) CITY OF SWAN MAIN ROADS RESPONSEURY AREA MERROPOLITAN REGIL	лс
mainroads	1830-0909 PROJECT THE NORTHLINK WA CENTRAL SECTION	-
WESTERN AUSTRALIA	DRAWING TITLE TONKIN HIGHWAY (H017)	\neg
LIVERY DIRECTORATE	BEECHBORO ROAD BRIDGE No. 1781 INDEX	
14.02.18 date 20.02.18 date		_{ЕV} 1
20.02.10 DAIE		

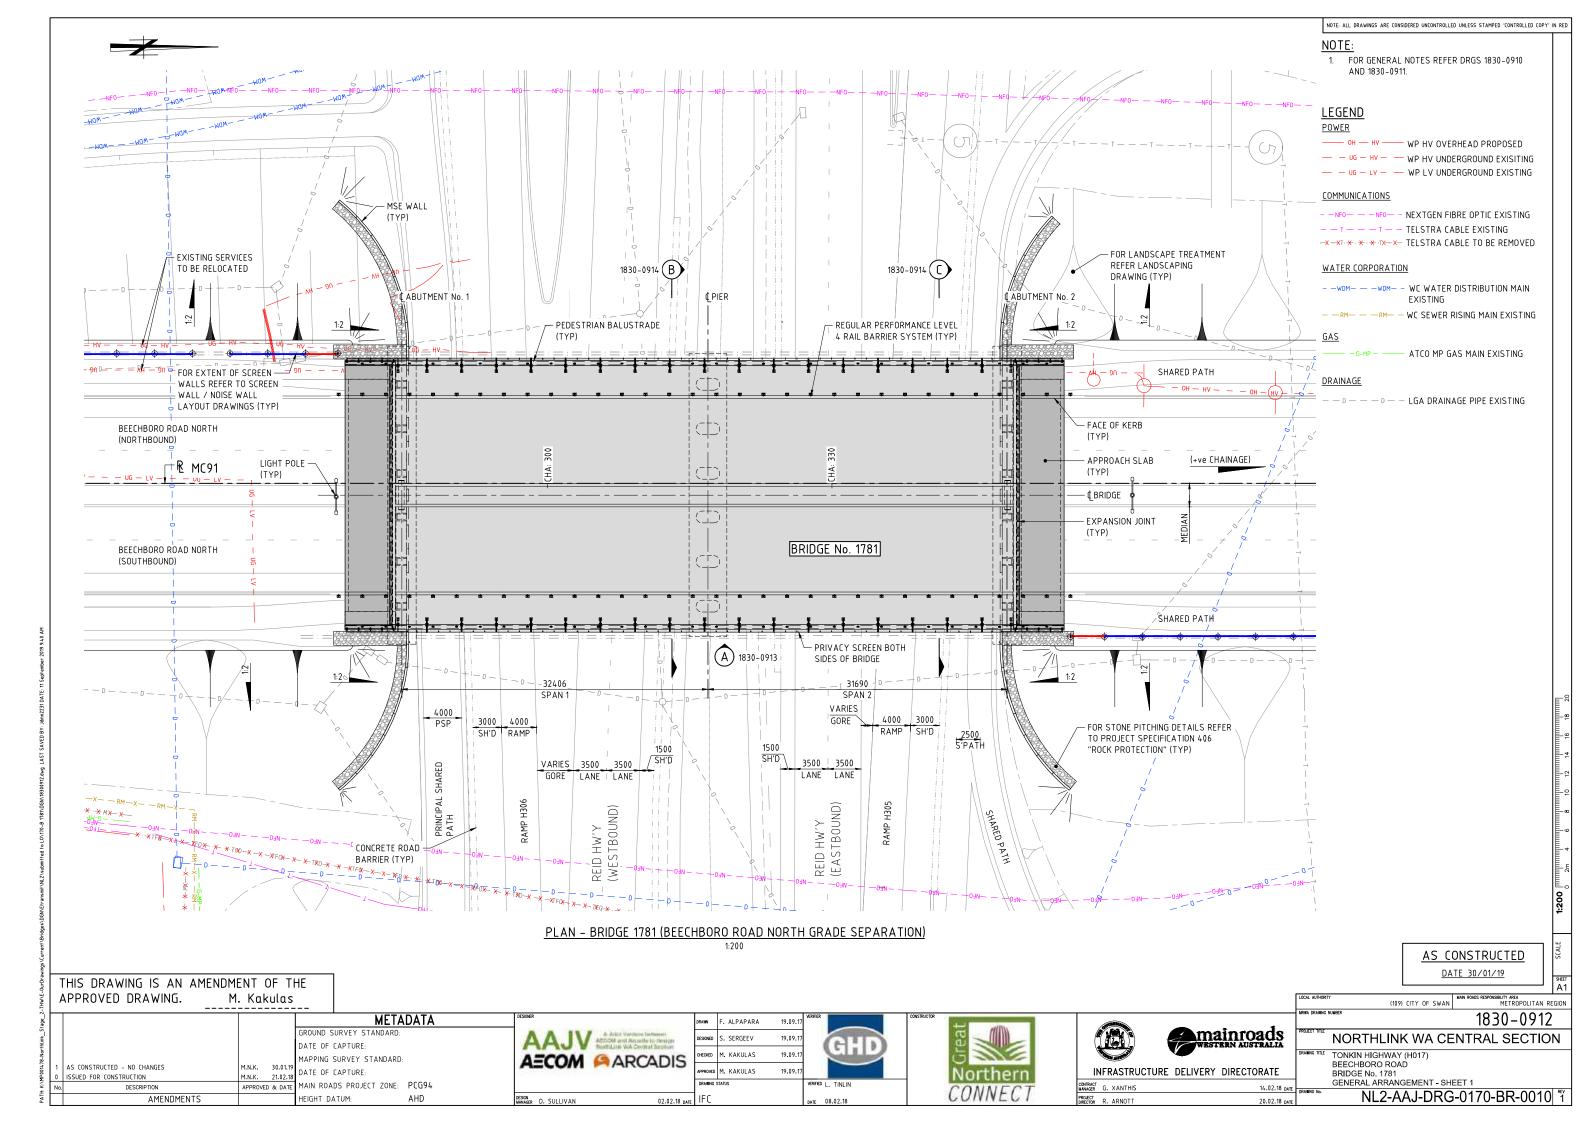

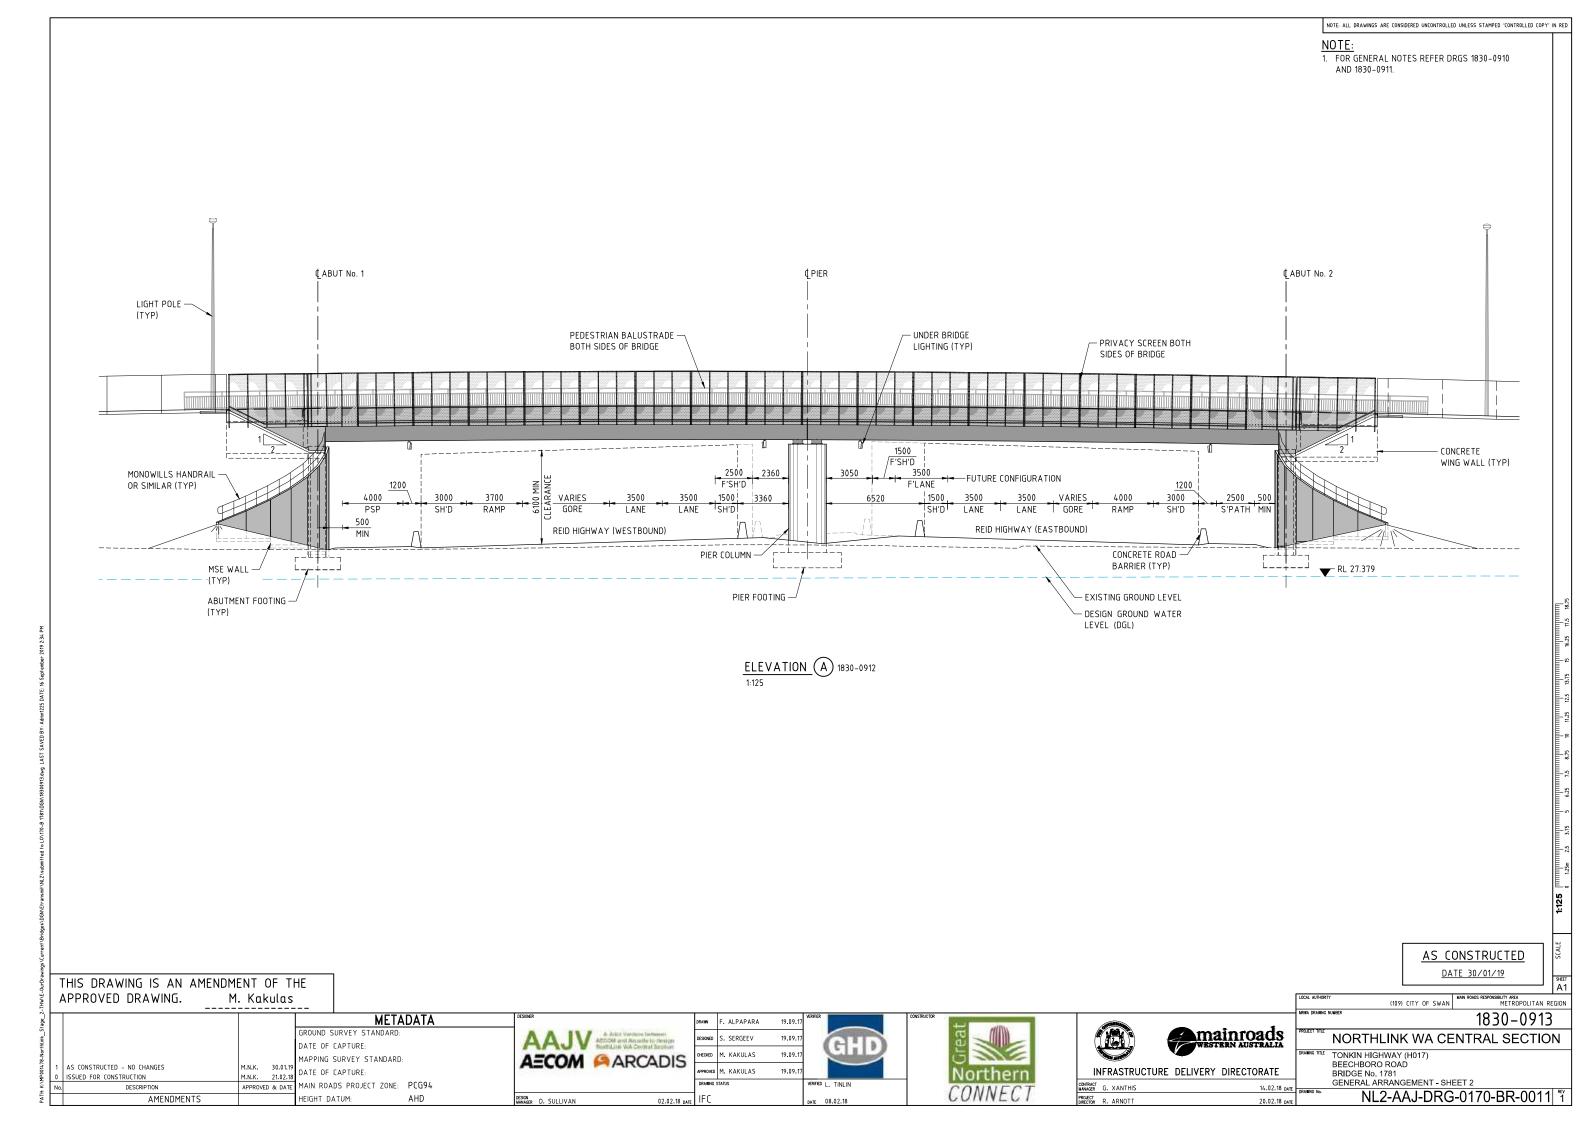

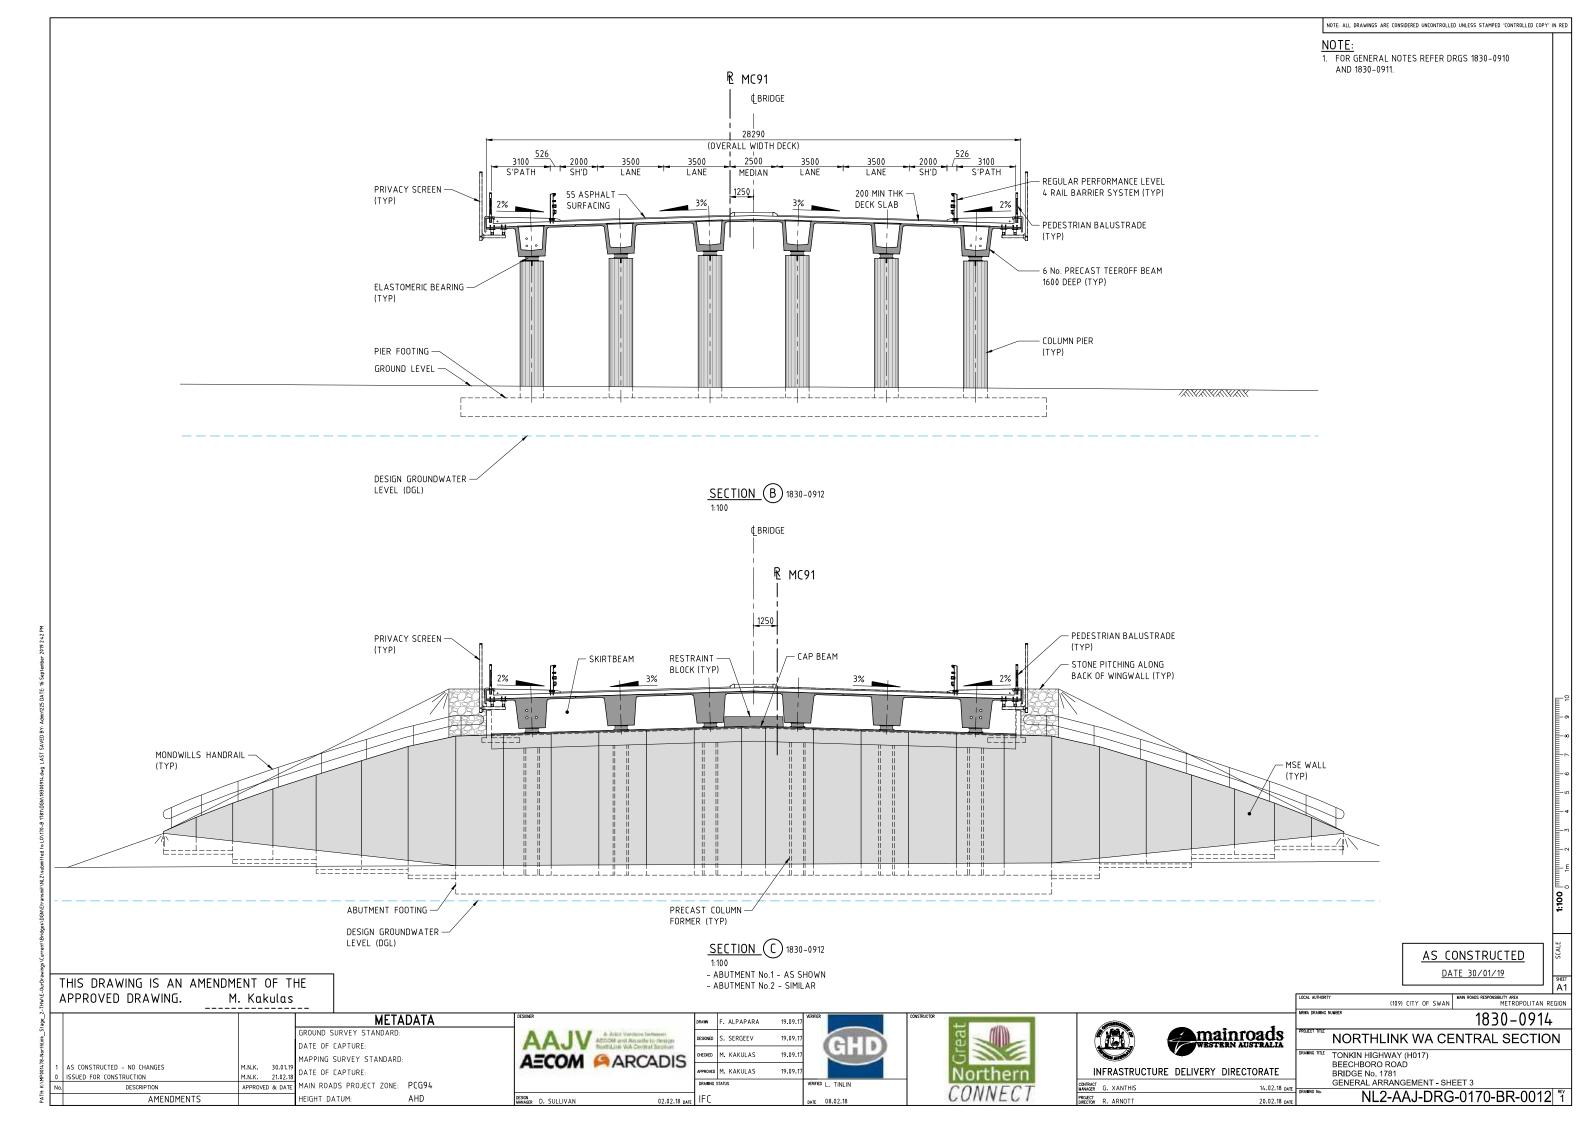


DRAWING INDEX					
DRAWING NUMBER	MRWA DRG No.	DRAWING DESCRIPTION	DRAWING NUMBER	MRWA DRG No.	DRAWING DESCRIPTION
GENERAL					
NL2-AAJ-DRG-0180-BR-0001	1830-0975	LOCALITY PLAN	NL2-AAJ-DRG-0180-BR-0073	1830-1016	DECK REINFORCEMENT DETAILS - SHEET 1
NL2-AAJ-DRG-0180-BR-0002	1830-0976	INDEX	NL2-AAJ-DRG-0180-BR-0074	1830-1017	DECK REINFORCEMENT DETAILS - SHEET 2
	1050-0770				
NL2-AAJ-DRG-0180-BR-0005	1830-0977	GENERAL NOTES - SHEET 1	NL2-AAJ-DRG-0180-BR-0090	1830-1018	APPROACH SLAB CONCRETE DETAILS
NL2-AAJ-DRG-0180-BR-0006	1830-0978	GENERAL NOTES - SHEET 2	NL2-AAJ-DRG-0180-BR-0091	1830-1019	APPROACH SLAB REINFORCEMENT DETAILS
NL2-AAJ-DRG-0180-BR-0010	1830-0979	GENERAL ARRANGEMENT – SHEET 1	NL2-AAJ-DRG-0180-BR-0100	1830-1020	EXPANSION JOINT DETAILS
NL2-AAJ-DRG-0180-BR-0011	1830-0980	GENERAL ARRANGEMENT - SHEET 2			
NL2-AAJ-DRG-0180-BR-0012	1830-0981	GENERAL ARRANGEMENT - SHEET 3	NL2-AAJ-DRG-0180-BR-0105	1830-1021	COVER PLATE DETAILS - SHEET 1
			NL2-AAJ-DRG-0180-BR-0106	1830-1022	COVER PLATE DETAILS - SHEET 2
SUBSTRUCTURE				4020 4022	
NL2-AAJ-DRG-0180-BR-0015	1830-0982	BORE INFORMATION - SHEET 1	NL2-AAJ-DRG-0180-BR-0110	1830-1023	
NL2-AAJ-DRG-0180-BR-0016	1830-0983	BORE INFORMATION - SHEET 2	NL2-AAJ-DRG-0180-BR-0111	1830-1024	PRECAST PARAPET CONCRETE DETAILS
NL2-AAJ-DRG-0180-BR-0017	1830-0984	GEOMETRIC DATA	NL2-AAJ-DRG-0180-BR-0112	1830-1025	INSITU BARRIER CONCRETE AND REINFORCEMENT DET
			NL2-AAJ-DRG-0180-BR-0113	1830-1026	TYPE 1 – BARRIER TRANSITION DETAILS
NL2-AAJ-DRG-0180-BR-0020	1830-0985	ABUTMENT – MSE WALL LAYOUT	NL2-AAJ-DRG-0180-BR-0114	1830-1027	TYPE 2 - BARRIER TRANSITION DETAILS
NL2-AAJ-DRG-0180-BR-0021	1830-0986	ABUTMENT No. 1 - MSE WALL	NL2-AAJ-DRG-0180-BR-0115	1830-1028	PEDESTRIAN BALUSTRADE DETAILS
NL2-AAJ-DRG-0180-BR-0022	1830-0987	ABUTMENT No. 2 - MSE WALL			
NL2-AAJ-DRG-0180-BR-0023	1830-0988	ABUTMENT - MSE WALL TYPICAL DETAILS	NL2-AAJ-DRG-0180-BR-0135	1830-1029	LIGHTING AND ELECTRICAL LAYOUT
			NL2-AAJ-DRG-0180-BR-0136	1830-1030	LIGHTING AND ELECTRICAL DETAILS
NL2-AAJ-DRG-0180-BR-0024	1830-0989		NL2-AAJ-DRG-0180-BR-0137	1830-1031	LUMINAIRE BRACKET DETAILS
NL2-AAJ-DRG-0180-BR-0025	1830-0990	ABUTMENT No. 1 - CONCRETE DETAILS			
NL2-AAJ-DRG-0180-BR-0026	1830-0991	ABUTMENT No. 2 - CONCRETE DETAILS	NL2-AAJ-DRG-0180-BR-0140	1830-1032	EARTHING & BONDING DETAILS – SHEET 1
NL2-AAJ-DRG-0180-BR-0027	1830-0992	ABUTMENT - TYPICAL CONCRETE DETAILS	NL2-AAJ-DRG-0180-BR-0141	1830-1033	EARTHING & BONDING DETAILS – SHEET 2
NL2-AAJ-DRG-0180-BR-0028	1830-0993	WINGWALL DETAILS	NL2-AAJ-DRG-0180-BR-0142	1830-1034	EARTHING & BONDING DETAILS – SHEET 3
NL2-AAJ-DRG-0180-BR-0029	1830-0994	WING WALL REINFORCEMENT DETAILS			
NL2-AAJ-DRG-0180-BR-0030	1830-0995	ABUTMENT - REINFORCEMENT DETAILS - SHEET 1	NL2-AAJ-DRG-0180-BR-0145	1830-1035	ELECTRIFICATION PROTECTION SCREEN
NL2-AAJ-DRG-0180-BR-0031	1830-0996	ABUTMENT – REINFORCEMENT DETAILS – SHEET 2	NL2-AAJ-DRG-0180-BR-0146	1830-1036	ELECTRIFICATION PROTECTION SCREEN DETAILS
NL2-AAJ-DRG-0180-BR-0033	1830-0997	COLUMN REINFORCEMENT DETAILS	NL2-AAJ-DRG-0180-BR-0150	1830-1037	STAIRS – PLAN & PROFILE
			NL2-AAJ-DRG-0180-BR-0151	1830-1038	STAIRS - REINFORCEMENT
NL2-AAJ-DRG-0180-BR-0035	1830-0998	PIER – CONCRETE DETAILS – SHEET 1			
NL2-AAJ-DRG-0180-BR-0036	1830-0999	PIER – CONCRETE DETAILS – SHEET 2	NL2-AAJ-DRG-0180-BR-0152	1830-1039	STAIRS - DETAILS & HANDRAIL
NL2-AAJ-DRG-0180-BR-0037	1830-1000	PIER – REINFORCEMENT DETAILS – SHEET 1			
NL2-AAJ-DRG-0180-BR-0038	1830-1001	PIER – REINFORCEMENT DETAILS – SHEET 2	NL2-AAJ-DRG-0180-BR-0155	1830-1040	DESIGN SUMMARY – SHEET 1
			NL2-AAJ-DRG-0180-BR-0156	1830-1041	DESIGN SUMMARY - SHEET 2
NL2-AAJ-DRG-0180-BR-0040	1830-1002	FUTURE PIER WALL DETAILS - SHEET 1			
NL2-AAJ-DRG-0180-BR-0041	1830-1003	FUTURE PIER WALL DETAILS - SHEET 2	MRWA STANDARD		
			DRAWINGS		
SUPERSTRUCTURE					
NL2-AAJ-DRG-0180-BR-0045	1830-1004	BEARING DETAILS - SHEET 1	-	0430-1314	PRECAST PARAPET PANELS
NL2-AAJ-DRG-0180-BR-0046	1830-1005	BEARING DETAILS - SHEET 2			
	1050 1005		-	0530-1087-1	BRIDGE BALUSTRADE FOR PSP - SHEET No 1
NL2-AAJ-DRG-0180-BR-0050	1830-1006	PRECAST TEEROFF BEAM LAYOUT	-	0530-1307-1	BRIDGE BALUSTRADE FOR PSP – SHEET No 2
NL2-AAJ-DRG-0180-BR-0051	1830-1007	PRECAST TEEROFF - CONCRETE DETAILS - SHEET 1			
NL2-AAJ-DRG-0180-BR-0052	1830-1008	PRECAST TEEROFF - CONCRETE DETAILS - SHEET 7	-	0630-1901	BRIDGE LIGHT POLE BASE – SHEET No 1
			-	0630-1902	BRIDGE LIGHT POLE BASE – SHEET No 2
NL2-AAJ-DRG-0180-BR-0053	1830-1009	PRECAST TEEROFF - CONCRETE DETAILS - SHEET 3			
NL2-AAJ-DRG-0180-BR-0057	1830-1010	PRECAST TEEROFF - PRESTRESSING DETAILS	-	200331-019-1	'THRIEBEAM' FABRICATION DETAILS
NEZ-ARJ-DRU-V 10V-DR-VVD/	עו עו – עכטו	TRECAST TEEROTT - FRESTRESSING DETAILS	-	200331-021-3	GENERAL ARRANGEMENT
	1020 4044			-	W' BEAM TO CONCRETE BARRIER CONNECTION
NL2-AAJ-DRG-0180-BR-0060	1830-1011	PRECAST TEEROFF - REINFORCEMENT DETAILS - SHEET 1	_	200331-022-3	GENERAL ARRANGEMENT
NL2-AAJ-DRG-0180-BR-0061	1830-1012	PRECAST TEEROFF - REINFORCEMENT DETAILS - SHEET 2			THRIEBEAM' TO CONCRETE BARRIER CONNECTION
NL2-AAJ-DRG-0180-BR-0062	1830-1013	PRECAST TEEROFF - REINFORCEMENT DETAILS - SHEET 3			
NL2-AAJ-DRG-0180-BR-0070	1830-1014	DECK CONCRETE DETAILS - SHEET 1			
	10 20 - 10 14				


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8-Nort			MAPPING SURVEY STANDARE):	AECOM	ARCADIS	CHECKED	N. KEAGE	11.09.17	CITE		6		
IP 0014	1 AS CONSTRUCTED - NO CHANGES 0 ISSUED FOR CONSTRUCTION	M.N.K. 21.11.18 M.N.K. 21.02.18	DATE OF CAPTURE:		A_COM		APPROVED	M.KAKULAS	11.09.17			Northern	INFRASTRUCT	TURE DELIVER
H: K:\N	No. DESCRIPTION	APPROVED & DATE	MAIN ROADS PROJECT ZONE:	PCG94			DRAWING S	STATUS	VE	RIFIED G. JOYNSON		CONNECT	CONTRACT MANAGER G. XANTHIS	
PATH	AMENDMENTS		HEIGHT DATUM:	AHD	DESIGN MANAGER D. SULLIVAN	02.02.18 date	IFC		DA	NTE 06.02.18		CONNECT	PROJECT DIRECTOR R. ARNOTT	


NL2-AAJ-DRG-0180-BR-0071

1830–1015 DECK CONCRETE DETAILS – SHEET 2

	AS CONSTRUCTED	EET
- *	LICOL AUTHORIY (109) CITY OF SWAN MAN ROADS RESPONSELITY MEA. METROPOLITAN REGIO MERKA DRAWNG NUMBER 1830 - 0976	11
WESTERN AUSTRALIA	PROJECT THE NORTHLINK WA CENTRAL SECTION BRANGE TILE TONKIN HIGHWAY (H017) MARSHALL ROAD BRIDGE NO. 1782	
14.02.18 date 20.02.18 date	IRVERS No. NL2-AAJ-DRG-0180-BR-0002	^{EV}

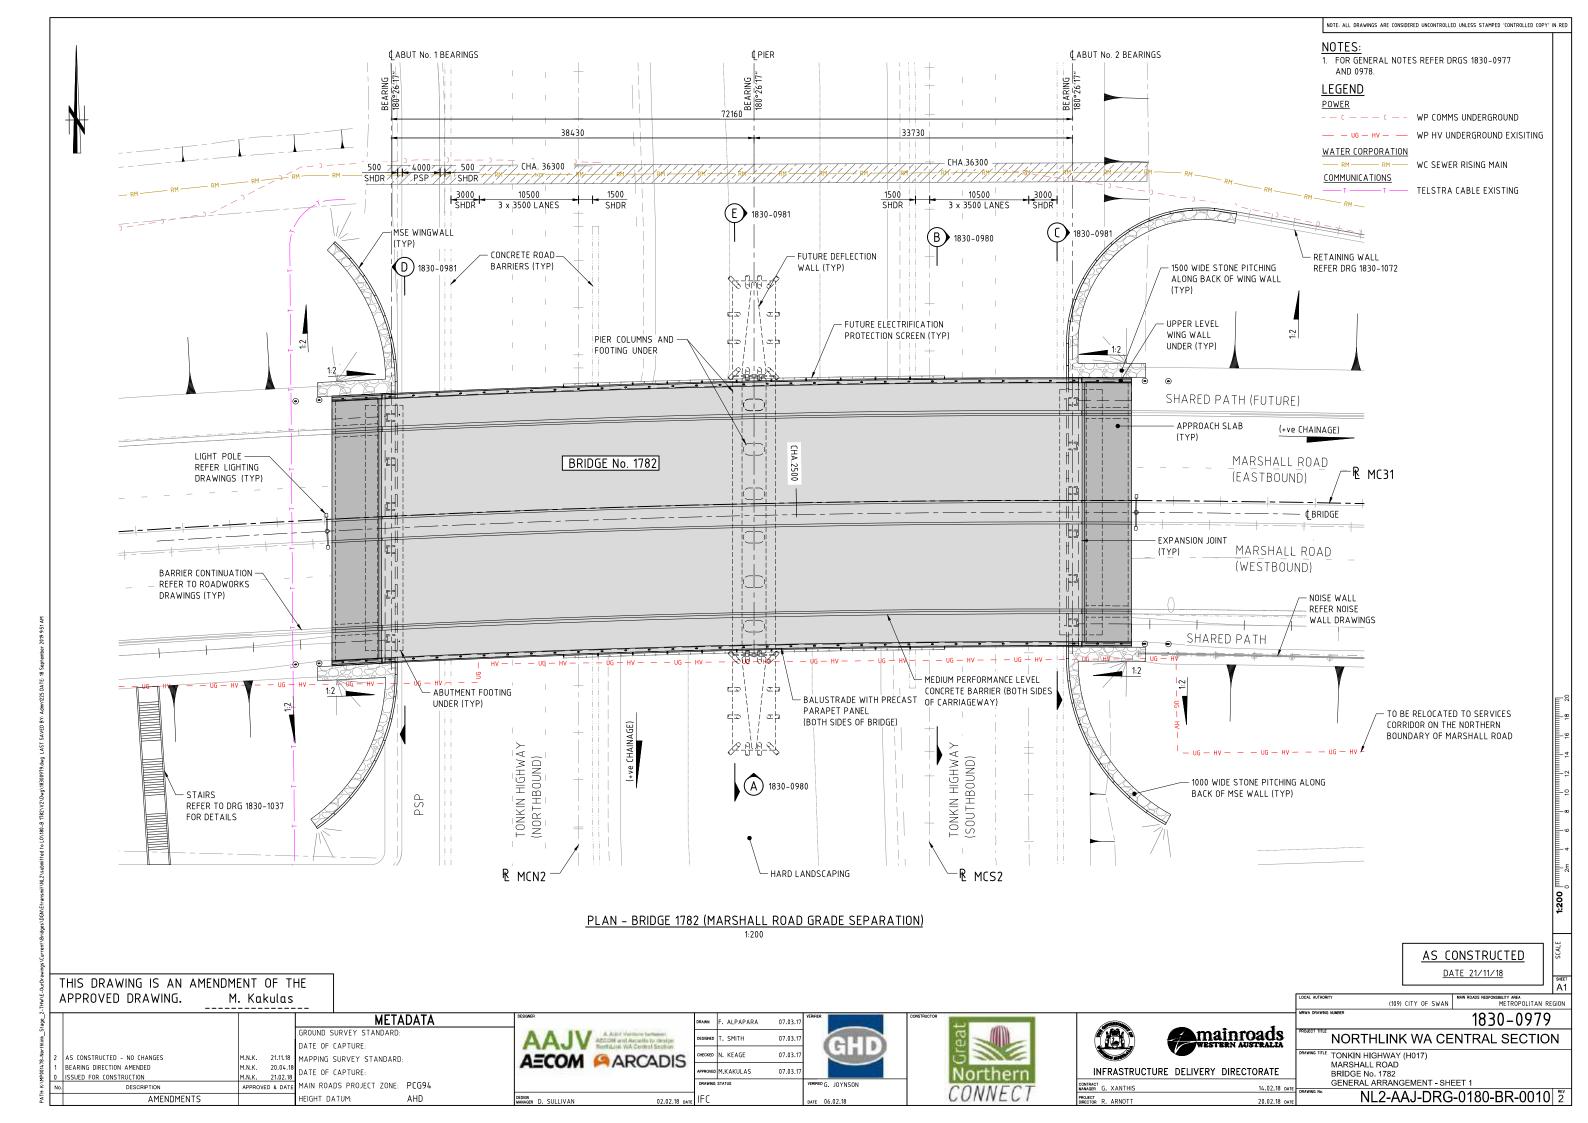

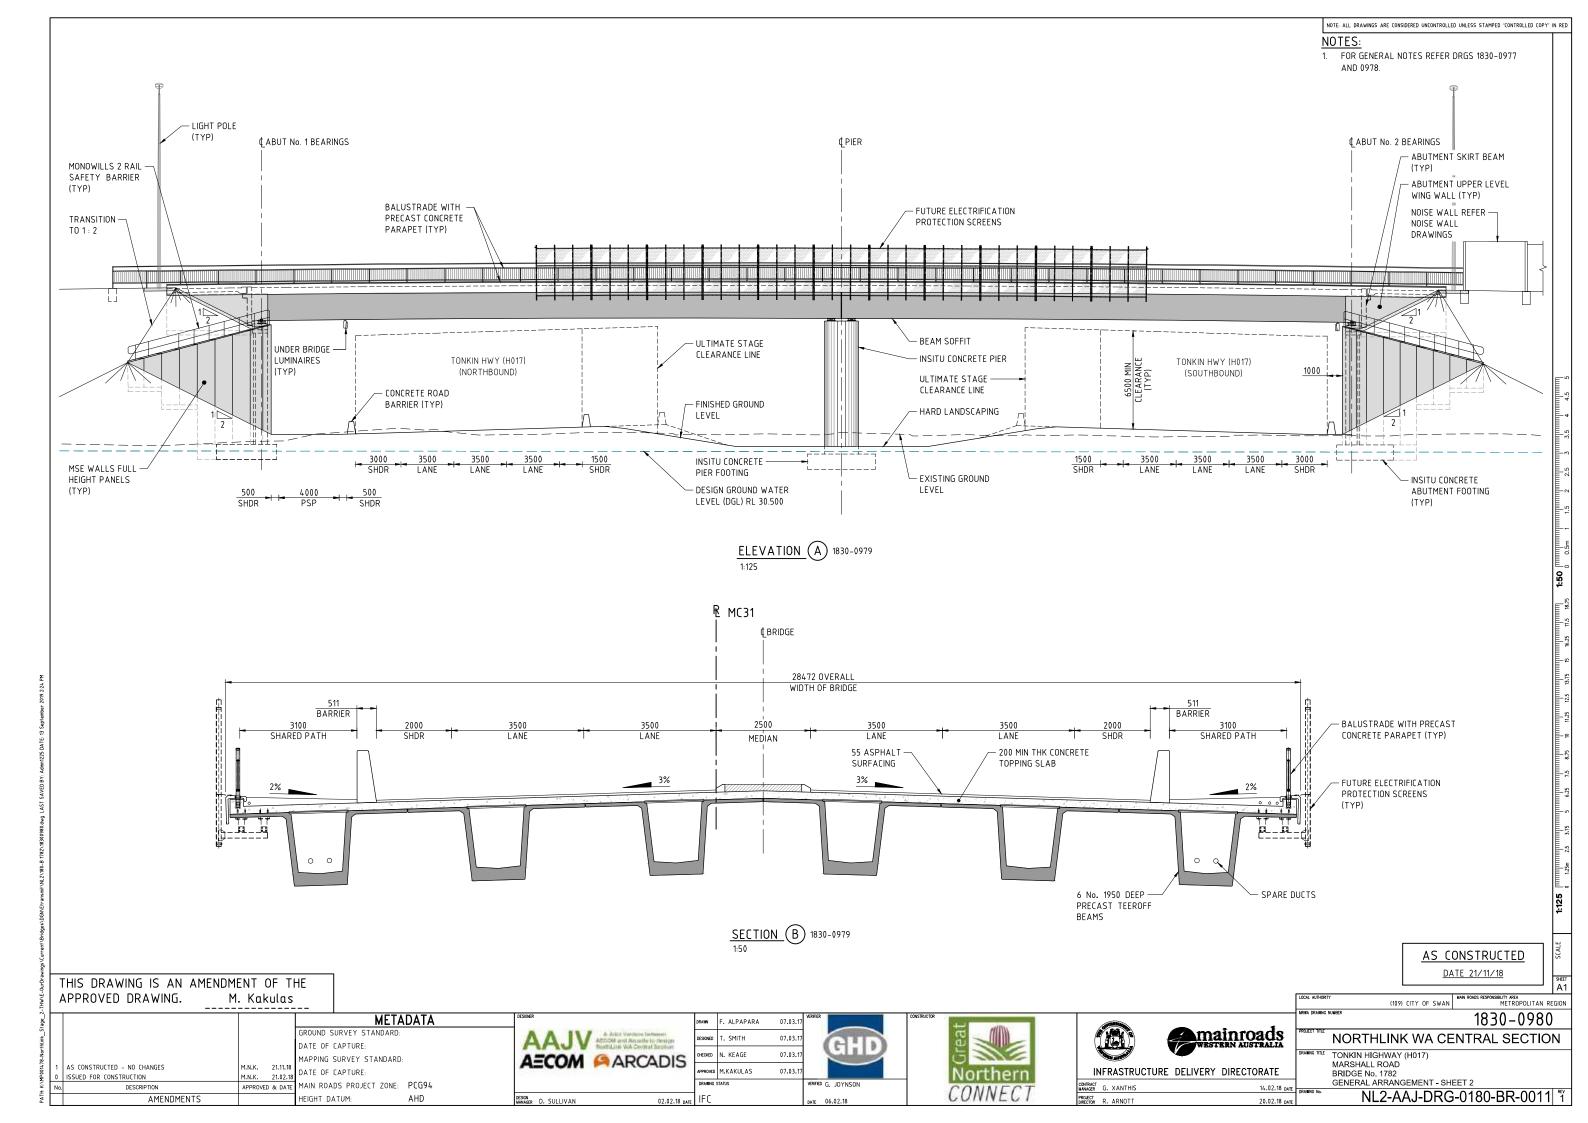

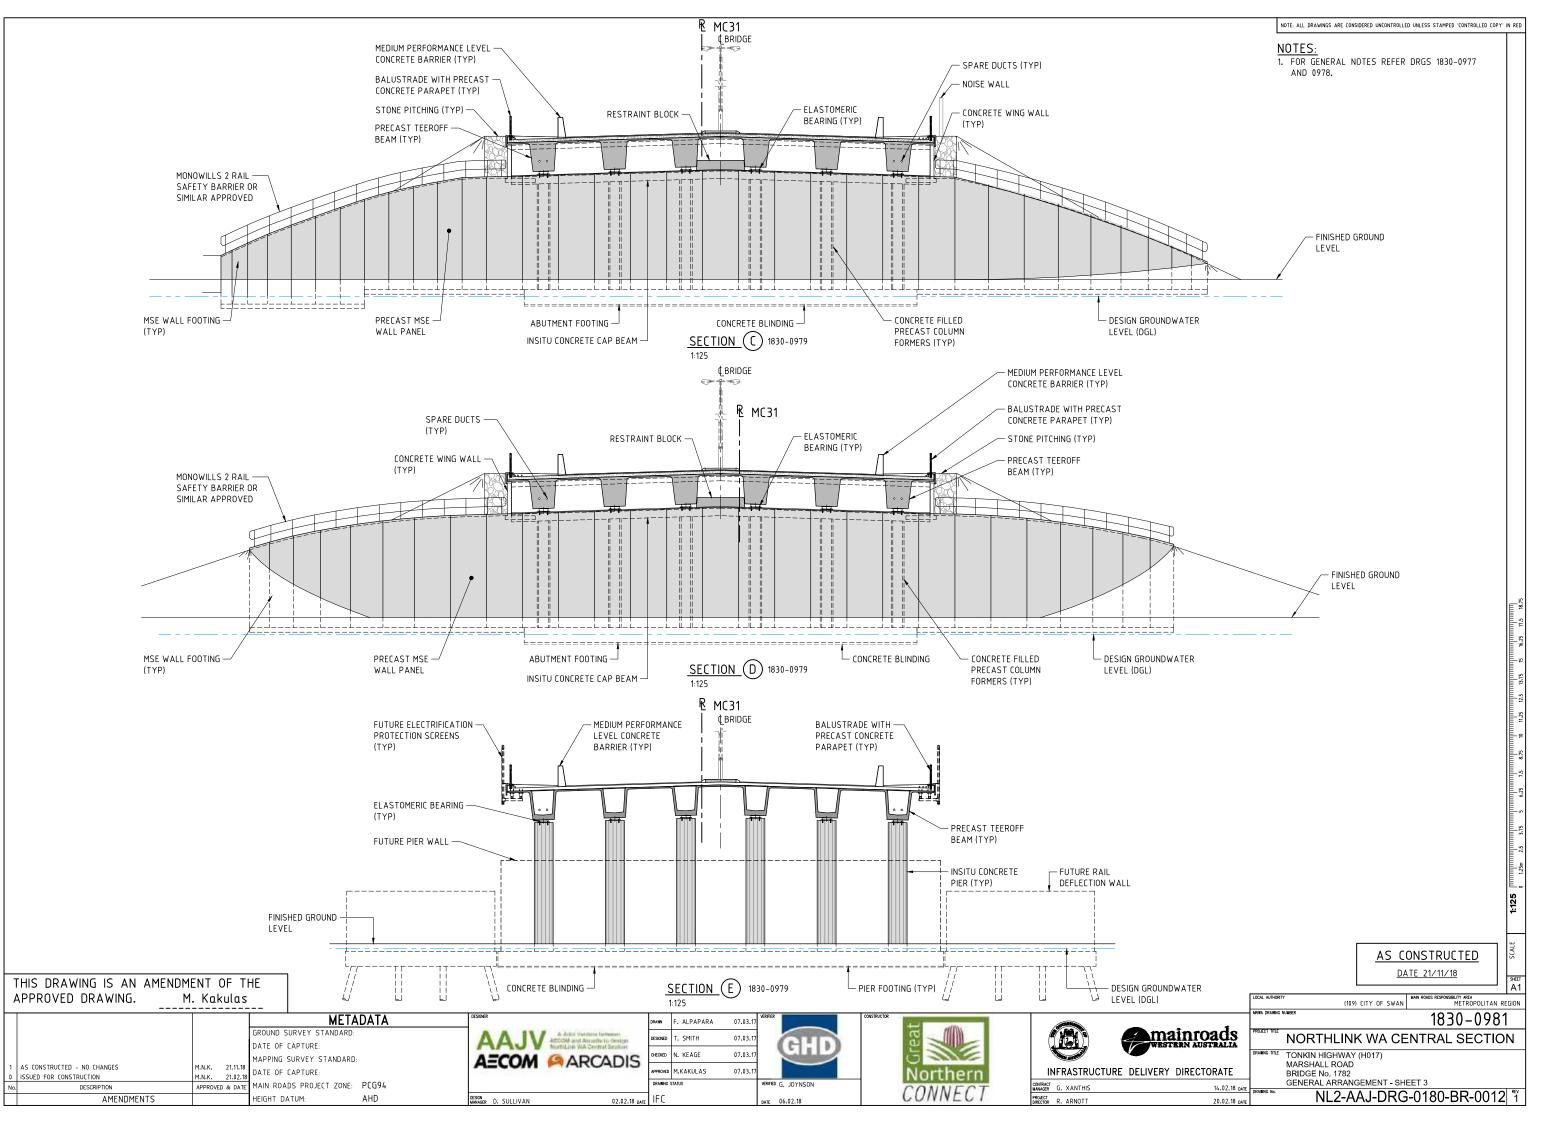

4001/18-Morthink_Stage_2-THWCE-Ou/Drawings/Current/Bridges/DGN/Etransmit/NL2/180-8-1182/18309814ag_LAST SAVED BY: Admit22 DATE: 13 September 20

DRAWING INDEX DRAWING NUMBER GENERAL

NL2-AAJ-DRG-0200-BR-0001 NL2-AAJ-DRG-0200-BR-0002

NL2-AAJ-DRG-0200-BR-0005 NL2-AAJ-DRG-0200-BR-0006

NL2-AAJ-DRG-0200-BR-0010 NL2-AAJ-DRG-0200-BR-0011 NL2-AAJ-DRG-0200-BR-0012 NL2-AAJ-DRG-0200-BR-0013

SUBSTRUCTURE

NL2-AAJ-DRG-0200-BR-0015 NL2-AAJ-DRG-0200-BR-0016 NL2-AAJ-DRG-0200-BR-0017

NL2-AAJ-DRG-0200-BR-0020 NL2-AAJ-DRG-0200-BR-0021 NL2-AAJ-DRG-0200-BR-0022 NL2-AAJ-DRG-0200-BR-0023 NL2-AAJ-DRG-0200-BR-0024 NL2-AAJ-DRG-0200-BR-0025 NL2-AAJ-DRG-0200-BR-0026 NL2-AAJ-DRG-0200-BR-0027 NL2-AAJ-DRG-0200-BR-0028 NL2-AAJ-DRG-0200-BR-0029 NL2-AAJ-DRG-0200-BR-0030

NL2-AAJ-DRG-0200-BR-0032 NL2-AAJ-DRG-0200-BR-0033

NL2-AAJ-DRG-0200-BR-0035 NL2-AAJ-DRG-0200-BR-0036 NL2-AAJ-DRG-0200-BR-0037

MRWA DRG No.	DRAWING DESCRIPTION	DRAWING NUMBER	MRWA DRG No.	DRAWING DESCRIPTION
		SUPERSTRUCTURE		
1830-1131	LOCALITY PLAN	NL2-AAJ-DRG-0200-BR-0045	1830-1158	BEARING DETAILS – SHEET 1
1830-1132	INDEX	NL2-AAJ-DRG-0200-BR-0046	1830-1159	BEARING DETAILS - SHEET 2
1830-1133	GENERAL NOTES - SHEET 1	NL2-AAJ-DRG-0200-BR-0050	1830-1160	PRECAST TEEROFF BEAM LAYOUT
1830-1134	GENERAL NOTES - SHEET 2			
		NL2-AAJ-DRG-0200-BR-0052	1830-1161	PRECAST TEEROFF - CONCRETE DETAILS - SHEET 1
1830-1135	GENERAL ARRANGEMENT - SHEET 1	NL2-AAJ-DRG-0200-BR-0053	1830-1162	PRECAST TEEROFF - CONCRETE DETAILS - SHEET 2
1830-1136	GENERAL ARRANGEMENT - SHEET 2			
1830-1137	GENERAL ARRANGEMENT - SHEET 3	NL2-AAJ-DRG-0200-BR-0057	1830-1163	PRECAST TEEROFF - PRESTRESSING DETAILS
1830-1138	GENERAL ARRANGEMENT - SHEET 4			
		NL2-AAJ-DRG-0200-BR-0060	1830-1164	PRECAST TEEROFF - REINFORCEMENT DETAILS - SHEET 1
		NL2-AAJ-DRG-0200-BR-0061	1830-1165	PRECAST TEEROFF - REINFORCEMENT DETAILS - SHEET 2
1830-1139	BORE INFORMATION - SHEET 1			
1830-1140	BORE INFORMATION - SHEET 2	NL2-AAJ-DRG-0200-BR-0070	1830-1166	DECK CONCRETE DETAILS - SHEET 1
1830-1141	GEOMETRIC DATA	NL2-AAJ-DRG-0200-BR-0071	1830-1167	DECK CONCRETE DETAILS - SHEET 2
1050-1141	deone trie DATA			
1830-1142	ABUTMENT – MSE WALL LAYOUT	NL2-AAJ-DRG-0200-BR-0073	1830-1168	DECK REINFORCEMENT DETAILS - SHEET 1
1830-1142	ABUTMENT No. 1 - MSE WALL	NL2-AAJ-DRG-0200-BR-0074	1830-1169	DECK REINFORCEMENT DETAILS - SHEET 2
1830-1144	ABUTMENT No. 2 - MSE WALL			
1830-1145	ABUTMENT - MSE WALL TYPICAL DETAILS	NL2-AAJ-DRG-0200-BR-0090	1830-1170	APPROACH SLAB CONCRETE DETAILS
1830-1146	ABUTMENT No 1 - CONCRETE DETAILS	NL2-AAJ-DRG-0200-BR-0091	1830-1171	APPROACH SLAB REINFORCEMENT DETAILS
1830-1147	ABUTMENT No 2 – CONCRETE DETAILS			
1830-1148	ABUTMENT TYPICAL CONCRETE DETAILS	NL2-AAJ-DRG-0200-BR-0100	1830-1172	EXPANSION JOINT DETAILS
1830-1149	COLUMN FORMER DETAILS			
1830-1150	ABUTMENT - REINFORCEMENT DETAILS - SHEET 1	NL2-AAJ-DRG-0200-BR-0105	1830-1173	COVER PLATE DETAILS - SHEET 1
1830-1151	ABUTMENT - REINFORCEMENT DETAILS - SHEET 2	NL2-AAJ-DRG-0200-BR-0106	1830-1174	COVER PLATE DETAILS - SHEET 2
1830-1152	COLUMN REINFORCEMENT			
1050 1152		NL2-AAJ-DRG-0200-BR-0110	1830-1175	PRECAST BARRIER LAYOUT AND DETAILS – SHEET 1
1830-1153	WINGWALL DETAILS	NL2-AAJ-DRG-0200-BR-0111	1830-1176	PRECAST BARRIER LAYOUT AND DETAILS – SHEET 2
1830-1154	WINGWALL REINFORCEMENT DETAILS			
		NL2-AAJ-DRG-0200-BR-0115	1830-1177	INSITU BARRIER LAYOUT AND DETAILS
1830-1155	RETAINING WALL DETAILS – SHEET 1	NL2-AAJ-DRG-0200-BR-0116	1830-1178	BARRIER TRANSITION DETAILS - SHEET 1
1830-1156	RETAINING WALL DETAILS - SHEET 2	NL2-AAJ-DRG-0200-BR-0117	1830-1179	BARRIER TRANSITION DETAILS - SHEET 2
1830-1157	RETAINING WALL REINFORCEMENT DETAILS			
		NL2-AAJ-DRG-0200-BR-0135	1830-1180	LIGHTING AND ELECTRICAL LAYOUT
		NL2-AAJ-DRG-0200-BR-0136	1830-1181	LIGHTING AND ELECTRICAL DETAILS
		NL2-AAJ-DRG-0200-BR-0137	1830-1182	LUMINAIRE BRACKET DETAIL
		NL2-AAJ-DRG-0200-BR-0145	1830-1183	PRIVACY SCREEN WALL DETAILS - SHEET 1
		NL2-AAJ-DRG-0200-BR-0146	1830-1184	PRIVACY SCREEN WALL DETAILS – SHEET 2
		NL2-AAJ-DRG-0200-BR-0155	1830-1185	DESIGN SUMMARY - SHEET 1 (TO FOLLOW)
		NL2-AAJ-DRG-0200-BR-0156	1830-1186	DESIGN SUMMARY - SHEET 2 (TO FOLLOW)

MRWA STANDARD DRAWING


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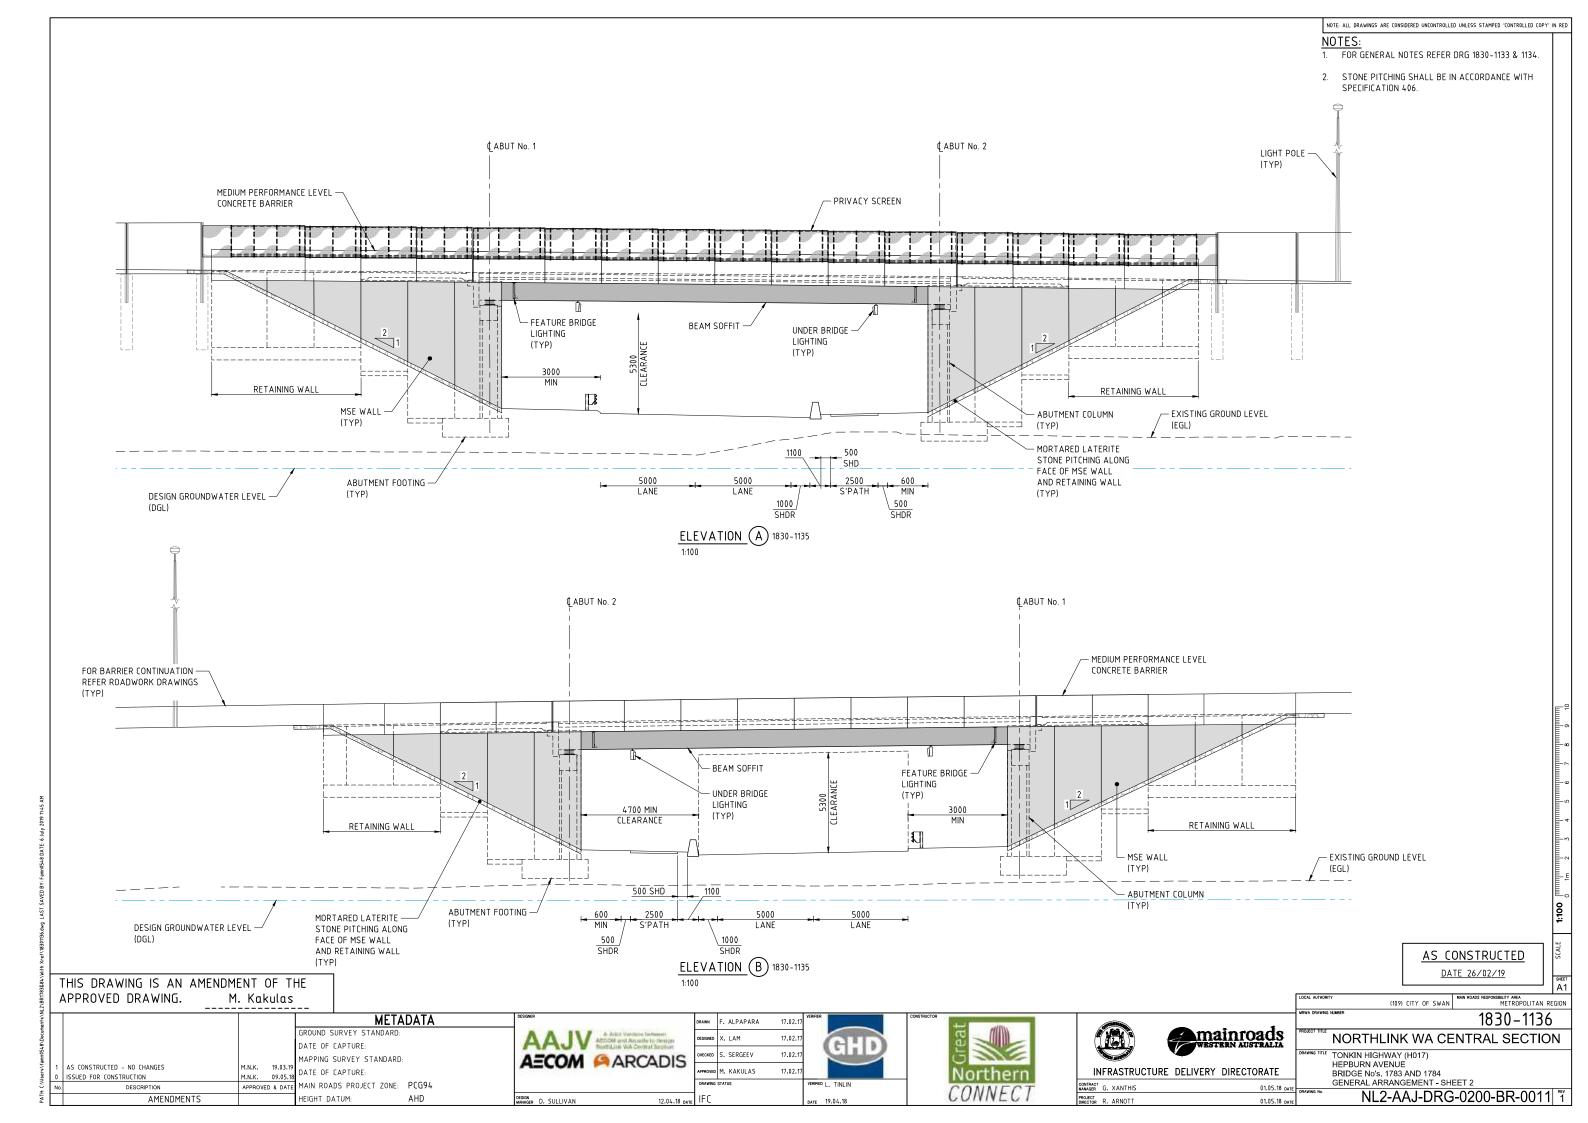
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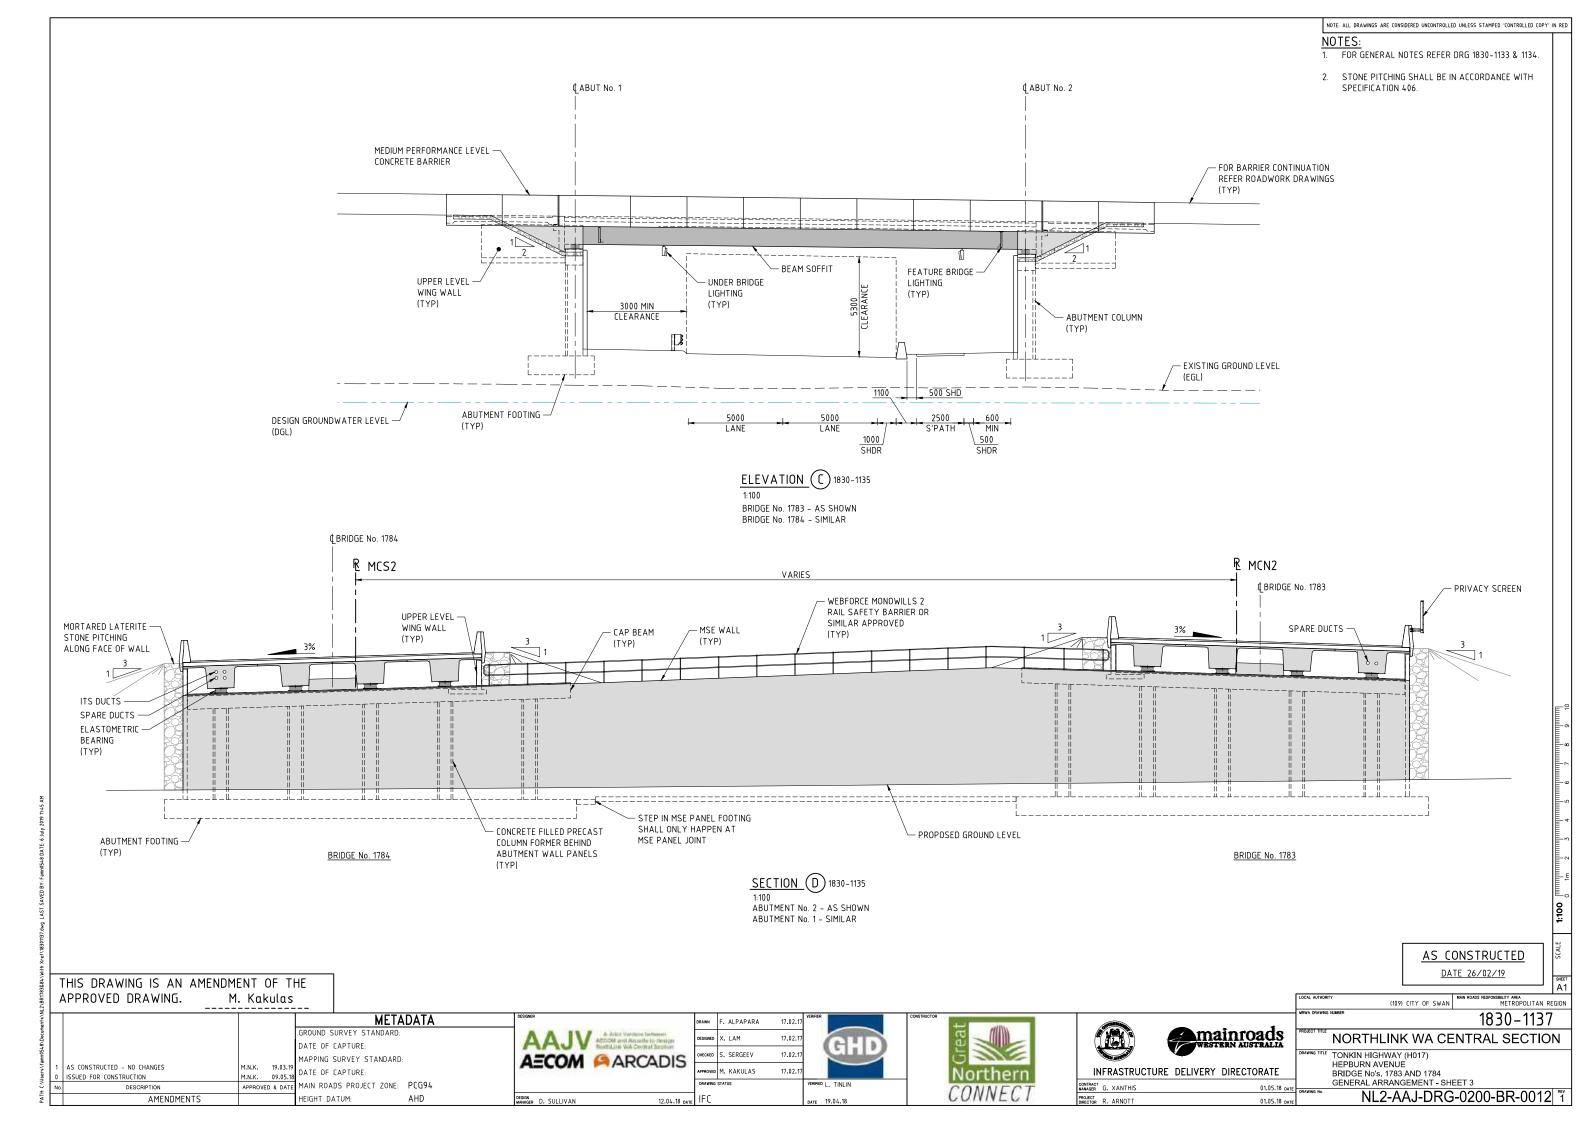
0630-1901	BRIDGE LIGHT POLE BASE - SHEET 1
0630-1902	BRIDGE LIGHT POLE BASE - SHEET 2


4L2\BR1783&84\Wit	THIS DRAWING IS AN AMENDM APPROVED DRAWING. M	ENT OF T I. Kakulas									
.famn0548\Documents\N	1 AS CONSTRUCTED - NO CHANGES		MET GROUND SURVEY STANDARD DATE OF CAPTURE: MAPPING SURVEY STANDAR		AAJV Add are far to being the far and the former to being the far and the former to be the far and the	DRAWN F. ALPAPARA Designed X. LAM Checked S. SERGEEV	27.11.17	GHD	CONSTRUCTOR		
: C:\Users\	0 ISSUED FOR CONSTRUCTION	M.N.K. 19.03.19 M.N.K. 09.05.18 APPROVED & DATE	DATE OF CAPTURE: MAIN ROADS PROJECT ZONE	PCG94		APPROVED M. KAKULAS	27.11.17	VERIFIED L. TINLIN	Northern	INFRASTRUCTUR	E DELIVER
PATH	AMENDMENTS		HEIGHT DATUM:	AHD	DESIGN MANAGER D. SULLIVAN 12.04.18 D	ε IFC		date 19.04.18	CONNECT	PROJECT DIRECTOR R. ARNOTT	


	LOCAL AUTHORITY (109) CITY OF SWAN MAN ROADS RESPONSENTLY AREA METROPOLITAN RE	
WESTERN AUSTRALIA	VEINA DRAWING MAREER 1830 – 1132 PROJECT INTLE NORTHLINK WA CENTRAL SECTION DRAWING TITLE TONKIN HIGHWAY (H017) HEPBURN AVENUE BRIDGE NO'S. 1783 AND 1784 INDEX	
01.05.18 date 01.05.18 date	DRAWING MA. NL2-AAJ-DRG-0200-BR-0002	^{rev}





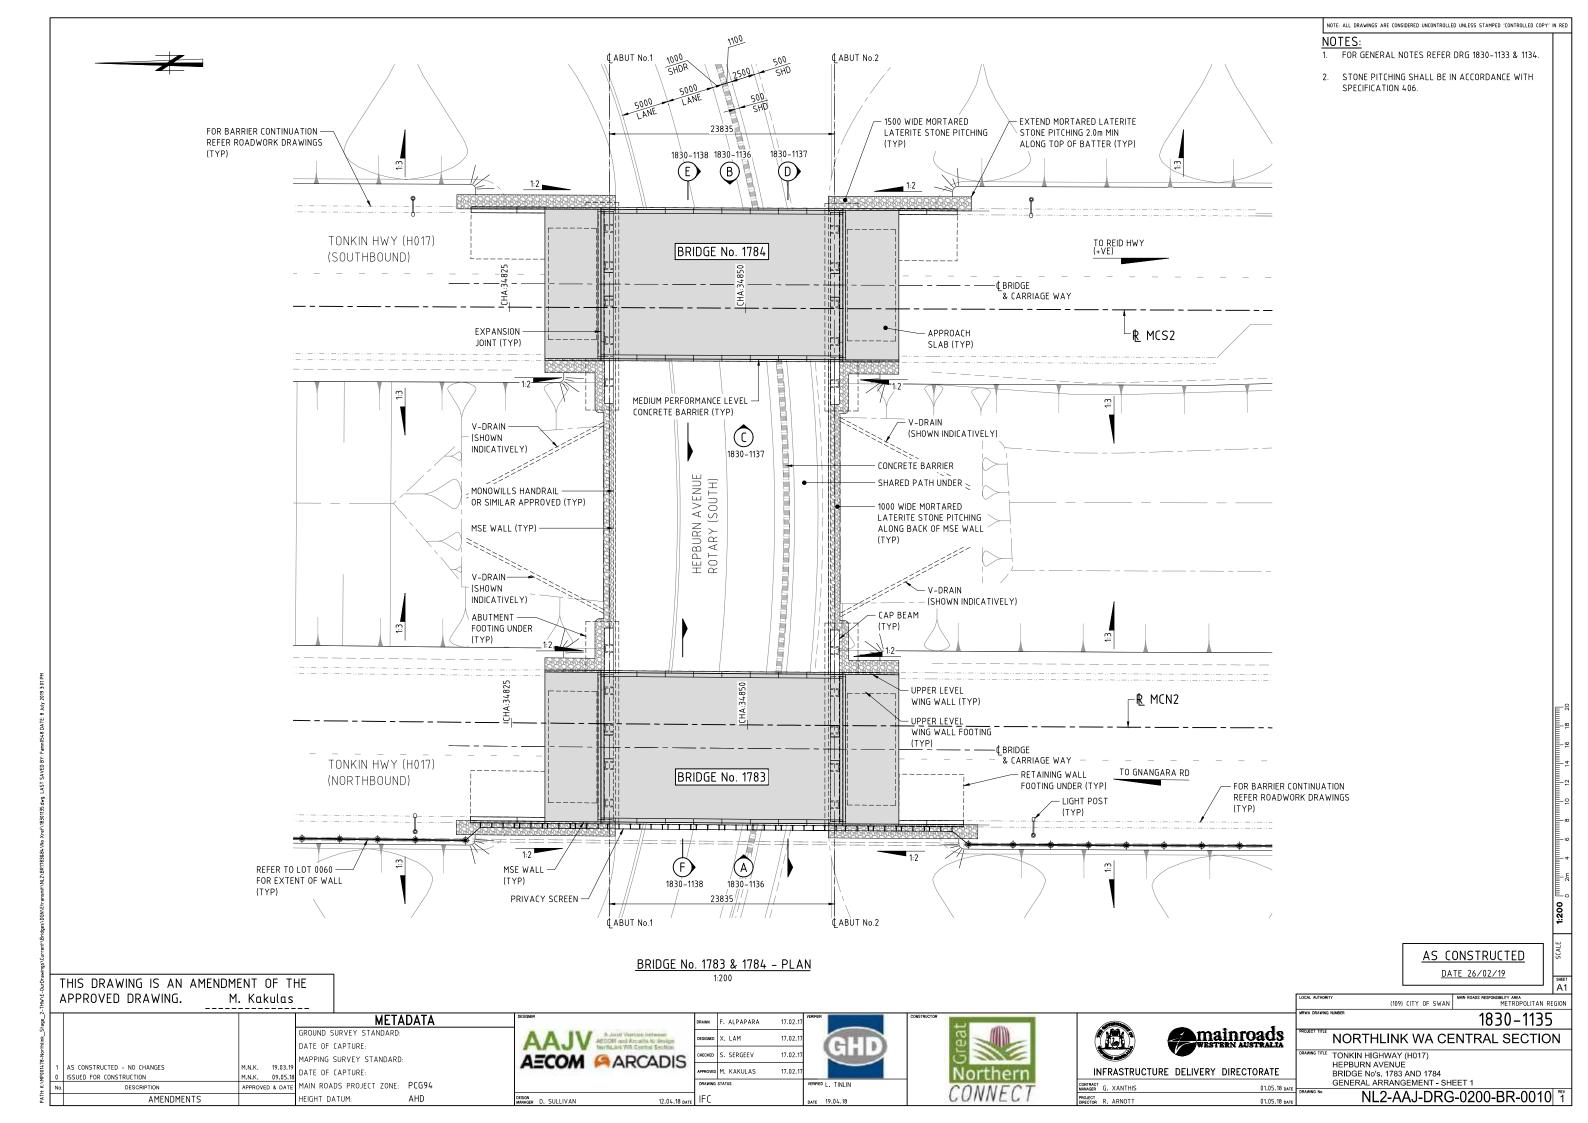

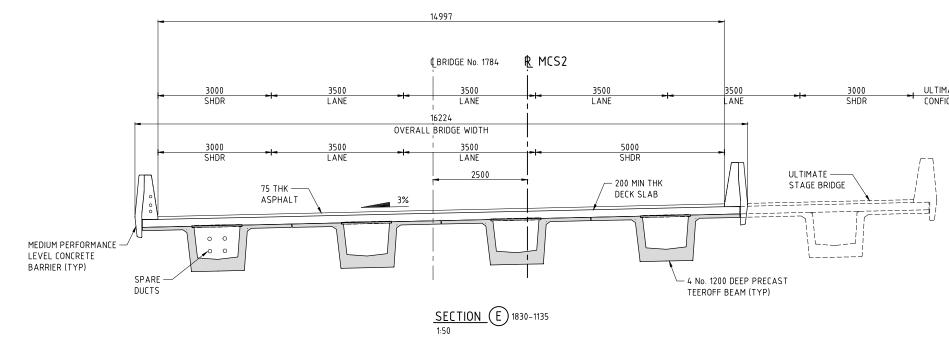

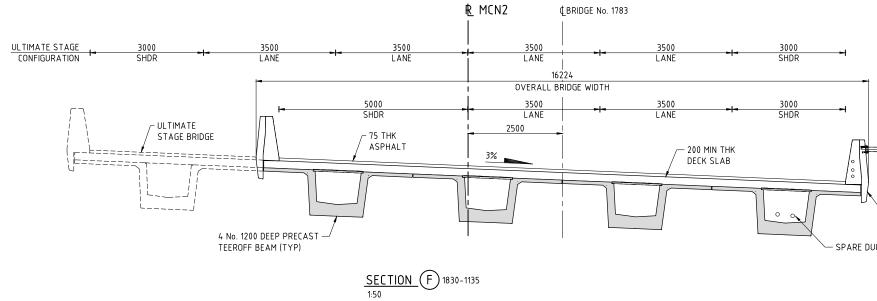



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MAINTOADS WESTERN AUSTRALIA /ERY DIRECTORATE 01.05.18 DATE	AS CONSTRUCTED DATE 26/02/19 LOGA AUTHORITY (109) CITY OF SWAN MORES REPORSEDITY AREA METROPOLITAN RE REWA DRAWING MINEER 1830 – 1138 PROJECT INTLE NORTHLINK WA CENTRAL SECTIO DRAWING TITLE TONKIN HIGHWAY (H017) HEPBURN AVENUE BRIDGE NO'S, 1783 AND 1784 GENERAL ARRANGEMENT - SHEET 4	N
01.05.18 date	NL2-AAJ-DRG-0200-BR-0013	^{REV}

ULTIMATE STAGE CONFIGURATION NOTE: ALL DRAWINGS ARE CONSIDERED UNCONTROLLED UNLESS STAMPED 'CONTROLLED COPY' IN RED NOTE: 1. FOR GENERAL NOTES REFER DRG 1830-1133 & 1134.

DRAWING INDEX

GENERAL

NL2-AAJ-DRG-0210-BR-000 NL2-AAJ-DRG-0210-BR-000

NL2-AAJ-DRG-0210-BR-0005 NL2-AAJ-DRG-0210-BR-0006

NL2-AAJ-DRG-0210-BR-0010 NL2-AAJ-DRG-0210-BR-0011 NL2-AAJ-DRG-0210-BR-0012 NL2-AAJ-DRG-0210-BR-0013

SUBSTRUCTURE

NL2-AAJ-DRG-0210-BR-0015 NL2-AAJ-DRG-0210-BR-0016 NL2-AAJ-DRG-0210-BR-0017

 NL2-AA J-DRG-0210-BR-0020

 NL2-AA J-DRG-0210-BR-0022

 NL2-AA J-DRG-0210-BR-0023

 NL2-AA J-DRG-0210-BR-0023

 NL2-AA J-DRG-0210-BR-0024

 NL2-AA J-DRG-0210-BR-0025

 NL2-AA J-DRG-0210-BR-0026

 NL2-AA J-DRG-0210-BR-0026

 NL2-AA J-DRG-0210-BR-0027

 NL2-AA J-DRG-0210-BR-0028

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 NL2-AA J-DRG-0210-BR-0028

 NL2-AA J-DRG-0210-BR-0029

 NL2-AA J-DRG-0210-BR-0029

 NL2-AA J-DRG-0210-BR-0030

NL2-AAJ-DRG-0210-BR-003 NL2-AAJ-DRG-0210-BR-003

NL2-AAJ-DRG-0210-BR-0035 NL2-AAJ-DRG-0210-BR-0036 NL2-AAJ-DRG-0210-BR-0037

SUPERSTRUCTURE

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NL2-AAJ-DRG-0210-BR-0050


NL2-AAJ-DRG-0210-BR-0052

	MRWA DRG No.	DRAWING DESCRIPTION	DRAWING NUMBER	MRWA DRG No.	DRAWING DESCRIPTION
			NL2-AAJ-DRG-0210-BR-0053	1830-1220	PRECAST TEEROFF - CONCRETE DETAILS - SHEET 2
0-BR-0001	1830-1189	LOCALITY PLAN			
0-BR-0002	1830-1190	INDEX	NL2-AAJ-DRG-0210-BR-0057	1830-1221	PRECAST TEEROFF - PRESTRESSING DETAILS
			NL2-AAJ-DRG-0210-BR-0060	1830-1222	PRECAST TEEROFF - REINFORCEMENT DETAILS - SHEET 1
0-BR-0005	1830-1191	GENERAL NOTES - SHEET 1	NL2-AAJ-DRG-0210-BR-0061	1830-1223	PRECAST TEEROFF - REINFORCEMENT DETAILS - SHEET 2
0-BR-0006	1830-1192	GENERAL NOTES - SHEET 2		1051 1225	
0-BR-0010	1830-1193	GENERAL ARRANGEMENT – SHEET 1	NL2-AAJ-DRG-0210-BR-0070	1830-1224	DECK CONCRETE DETAILS - SHEET 1
0-BR-0011	1830-1194	GENERAL ARRANGEMENT - SHEET 2	NL2-AAJ-DRG-0210-BR-0071	1830-1225	DECK CONCRETE DETAILS - SHEET 2
0-BR-0012	1830-1195	GENERAL ARRANGEMENT - SHEET 3			
0-BR-0013	1830-1196	GENERAL ARRANGEMENT - SHEET 4	NL2-AAJ-DRG-0210-BR-0073	1830-1226	DECK REINFORCEMENT DETAILS - SHEET 1
	1050-1170	denenae Annanderien i - Sheer 4	NL2-AAJ-DRG-0210-BR-0074	1830-1227	DECK REINFORCEMENT DETAILS - SHEET 2
RE					
0-BR-0015	1830-1197	BORE INFORMATION – SHEET 1	NL2-AAJ-DRG-0210-BR-0090	1830-1228	APPROACH SLAB CONCRETE DETAILS
0-BR-0016	1830-1198	BORE INFORMATION - SHEET 2	NL2-AAJ-DRG-0210-BR-0091	1830-1229	APPROACH SLAB REINFORCEMENT DETAILS
0-BR-0017	1830-1199	GEOMETRIC DATA		1020 1020	
			NL2-AAJ-DRG-0210-BR-0100	1830-1230	EXPANSION JOINT DETAILS
0-BR-0020	1830-1200	ABUTMENT - MSE WALL LAYOUT	NL2-AAJ-DRG-0210-BR-0105	1830-1231	COVER PLATE DETAILS - SHEET 1
0-BR-0021	1830-1201	ABUTMENT No. 1 – MSE WALL	NL2-AAJ-DRG-0210-BR-0106	1830-1232	COVER PLATE DETAILS - SHEET 2
0-BR-0022	1830-1202	ABUTMENT No. 2 – MSE WALL			
0-BR-0023	1830-1203	ABUTMENT – MSE WALL TYPICAL DETAILS	NL2-AAJ-DRG-0210-BR-0110	1830-1233	PRECAST BARRIER LAYOUT AND DETAILS – SHEET 1
0-BR-0024	1830-1204	ABUTMENT No 1 - CONCRETE DETAILS	NL2-AAJ-DRG-0210-BR-0111	1830-1234	PRECAST BARRIER LAYOUT AND DETAILS - SHEET 2
0-BR-0025	1830-1205	ABUTMENT No 2 - CONCRETE DETAILS			
0-BR-0026	1830-1206	ABUTMENT TYPICAL CONCRETE DETAILS	NL2-AAJ-DRG-0210-BR-0115	1830-1235	INSITU BARRIER LAYOUT AND DETAILS
0-BR-0027	1830-1207	COLUMN FORMER DETAILS	NL2-AAJ-DRG-0210-BR-0116	1830-1236	BARRIER TRANSITION DETAILS - SHEET 1
0-BR-0028	1830-1208	ABUTMENT - REINFORCEMENT DETAILS - SHEET 1	NL2-AAJ-DRG-0210-BR-0117	1830-1237	BARRIER TRANSITION DETAILS - SHEET 2
0-BR-0029	1830-1209	ABUTMENT - REINFORCEMENT DETAILS - SHEET 2			
0-BR-0030	1830-1210	COLUMN REINFORCEMENT	NL2-AAJ-DRG-0210-BR-0135	1830-1238	LIGHTING AND ELECTRICAL LAYOUT
	1830-1211		NL2-AAJ-DRG-0210-BR-0136	1830-1239	LIGHTING AND ELECTRICAL DETAILS
0-BR-0032	1830-1211	WING WALL DETAILS	NL2-AAJ-DRG-0210-BR-0137	1830-1240	LUMINAIRE BRACKET DETAILS
0-BR-0033	1830-1212	WING WALL REINFORCEMENT DETAILS			
			NL2-AAJ-DRG-0210-BR-0145	1830-1241	PRIVACY SCREEN WALL DETAILS – SHEET 1
0-BR-0035	1830-1213	RETAINING WALL DETAILS - SHEET 1	NL2-AAJ-DRG-0210-BR-0146	1830-1242	PRIVACY SCREEN WALL DETAILS - SHEET 2
0-BR-0036	1830-1214	RETAINING WALL DETAILS - SHEET 2			
0-BR-0037	1830-1215	RETAINING WALL REINFORCEMENT DETAILS	NL2-AAJ-DRG-0210-BR-0155	1830-1243	DESIGN SUMMARY - SHEET 1 (TO FOLLOW)
TUDE			NL2-AAJ-DRG-0210-BR-0156	1830-1244	DESIGN SUMMARY - SHEET 2 (TO FOLLOW)
TURE					
0-BR-0045	1830-1216	BEARING DETAILS - SHEET 1	MRWA STANDARD DRAWING		
0-BR-0046	1830-1217	BEARING DETAILS - SHEET 2	-	0430-0747-1	JUNCTION BOX DETAILS
			-	0630-1901	BRIDGE LIGHT POLE BASE – SHEET 1
0-BR-0050	1830-1218	PRECAST TEEROFF BEAM LAYOUT	-	0630-1902	BRIDGE LIGHT POLE BASE – SHEET 2


0-BR-0052 1830-1219 PRECAST TEEROFF - CONCRETE DETAILS - SHEET 1


JL 2\BR1785&1786\With	THIS DRAWING IS AN AMENDI APPROVED DRAWING.	MENT OF TH M. Kakulas									
lsers\famn0548\Documents\t	1 AS CONSTRUCTED - NO CHANGES 0 ISSUED FOR CONSTRUCTION	M N K 20 02 10	GROUND SURVEY STANDAP DATE OF CAPTURE: MAPPING SURVEY STANDA		AAJV		DRAWN F. ALPAPARA DESKORD X. LAM ONEOKED S. SERGEEV APPROVED M. KAKULAS	04.09.17 04.09.17 04.09.17 04.09.17	Northern		
PATH: C:VI	No. DESCRIPTION AMENDMENTS		MAIN ROADS PROJECT ZON HEIGHT DATUM:	E: PCG94 AHD	DESIGN MMAGER D. SULLIVAN	28.02.18 pare	drawing status	VERIFIED G. JOYNSON	CONNECT	CONTRACT MANAGER G. XANTHIS PROJECT R. ARNOTT	


		SHEET A1
mainroads	Local Authomity (109) CITY OF SWAN Men braces responsedurty area METROPOLITAN REG WINKA GRAVING MARGER 1830 – 1190 1830 – 1190 18000000000000000000000000000000000000	
YERY DIRECTORATE 14.03.18 date 15.03.18 date	HEPBURN AVENUE BRIDGE No's 1785 & 1786 INDEX	^{REV}

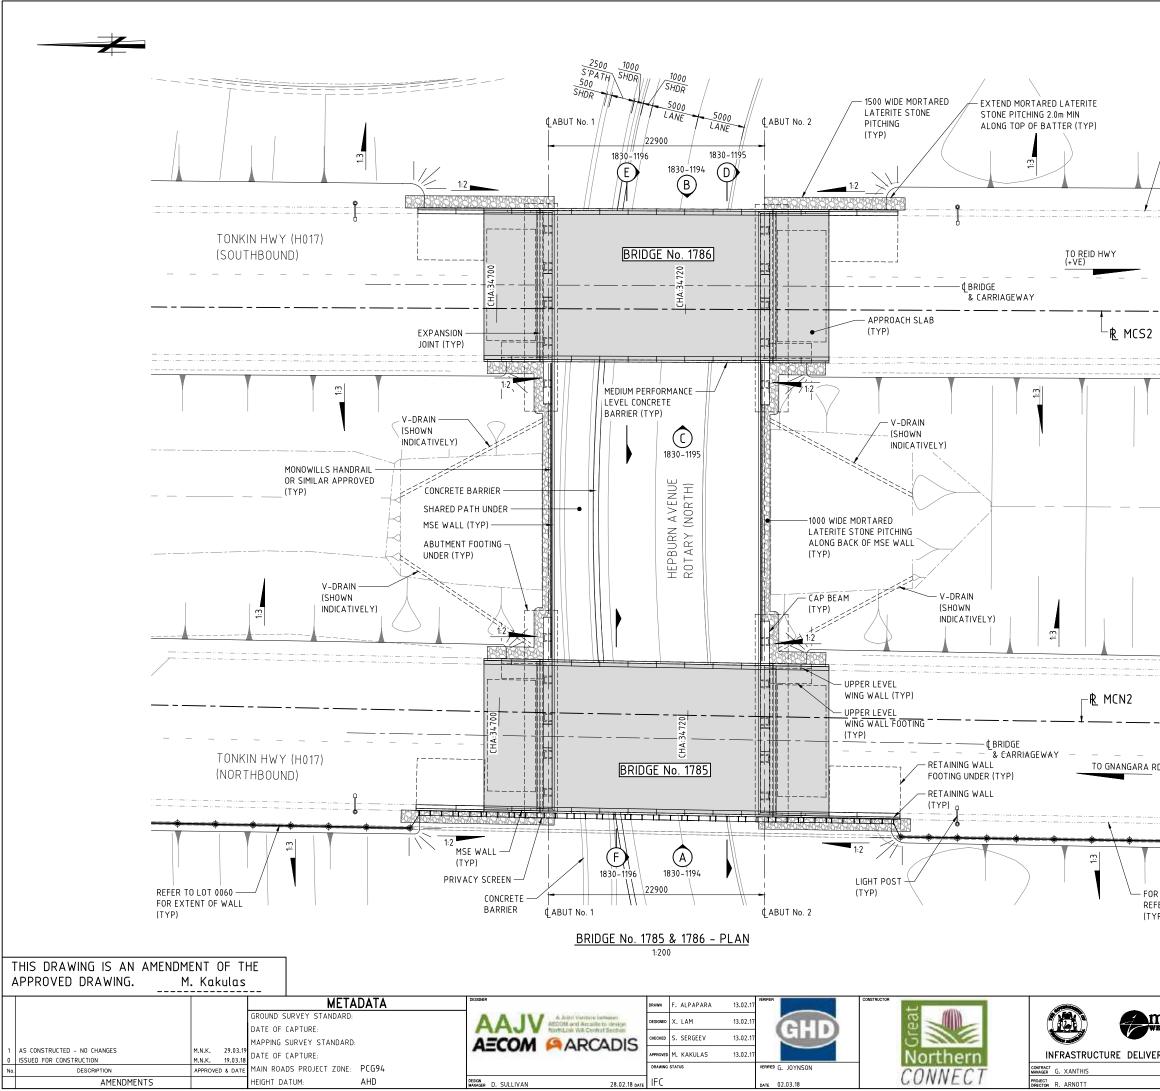

	NOTES: 1. FOR GENERAL NOTES REFER DRG 1830-1191 & 1192.
	2. STONE PITCHING SHALL BE IN ACCORDANCE WITH
	SPECIFICATION 406.
REFER ROADWORK	
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OR BARRIER CONTINUATIO	IN
EFER ROADWORK DRAWIN YP)	
	AS CONSTRUCTED
	<u>DATE 26/02/19</u>
	LOCK AUTHORITY (109) CITY OF SWAN MAN ROADS RESPONDENTY AREA METROPODULTAN REC METROPODULTAN REC
mainroads	PROJECT TITLE NORTHLINK WA CENTRAL SECTION
WESTERN AUSTRALIA	DRAWING TITLE TONKIN HIGHWAY (H017) HEPBURN AVENUE
ERY DIRECTORATE 14.03.18 DATE	BRIDGE No's 1785 & 1786 GENERAL ARRANGEMENT - SHEET 1
15.03.18 date	DRAWING No. NL2-AAJ-DRG-0210-BR-0010

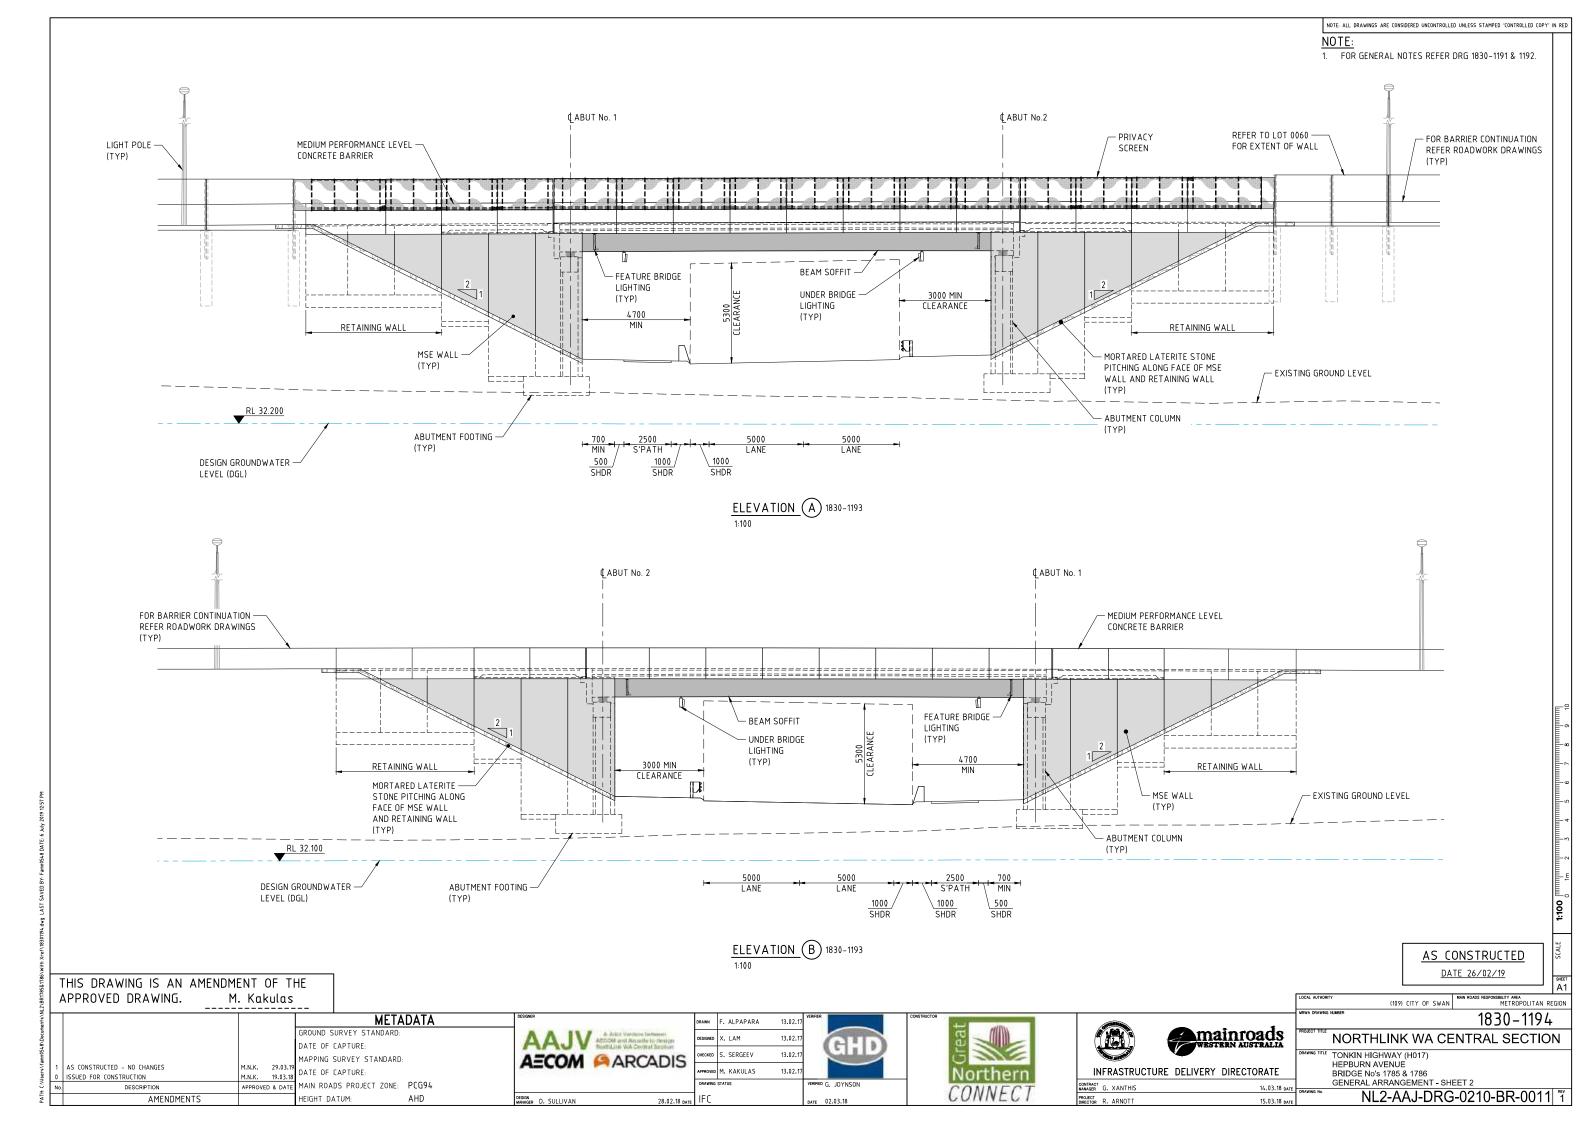

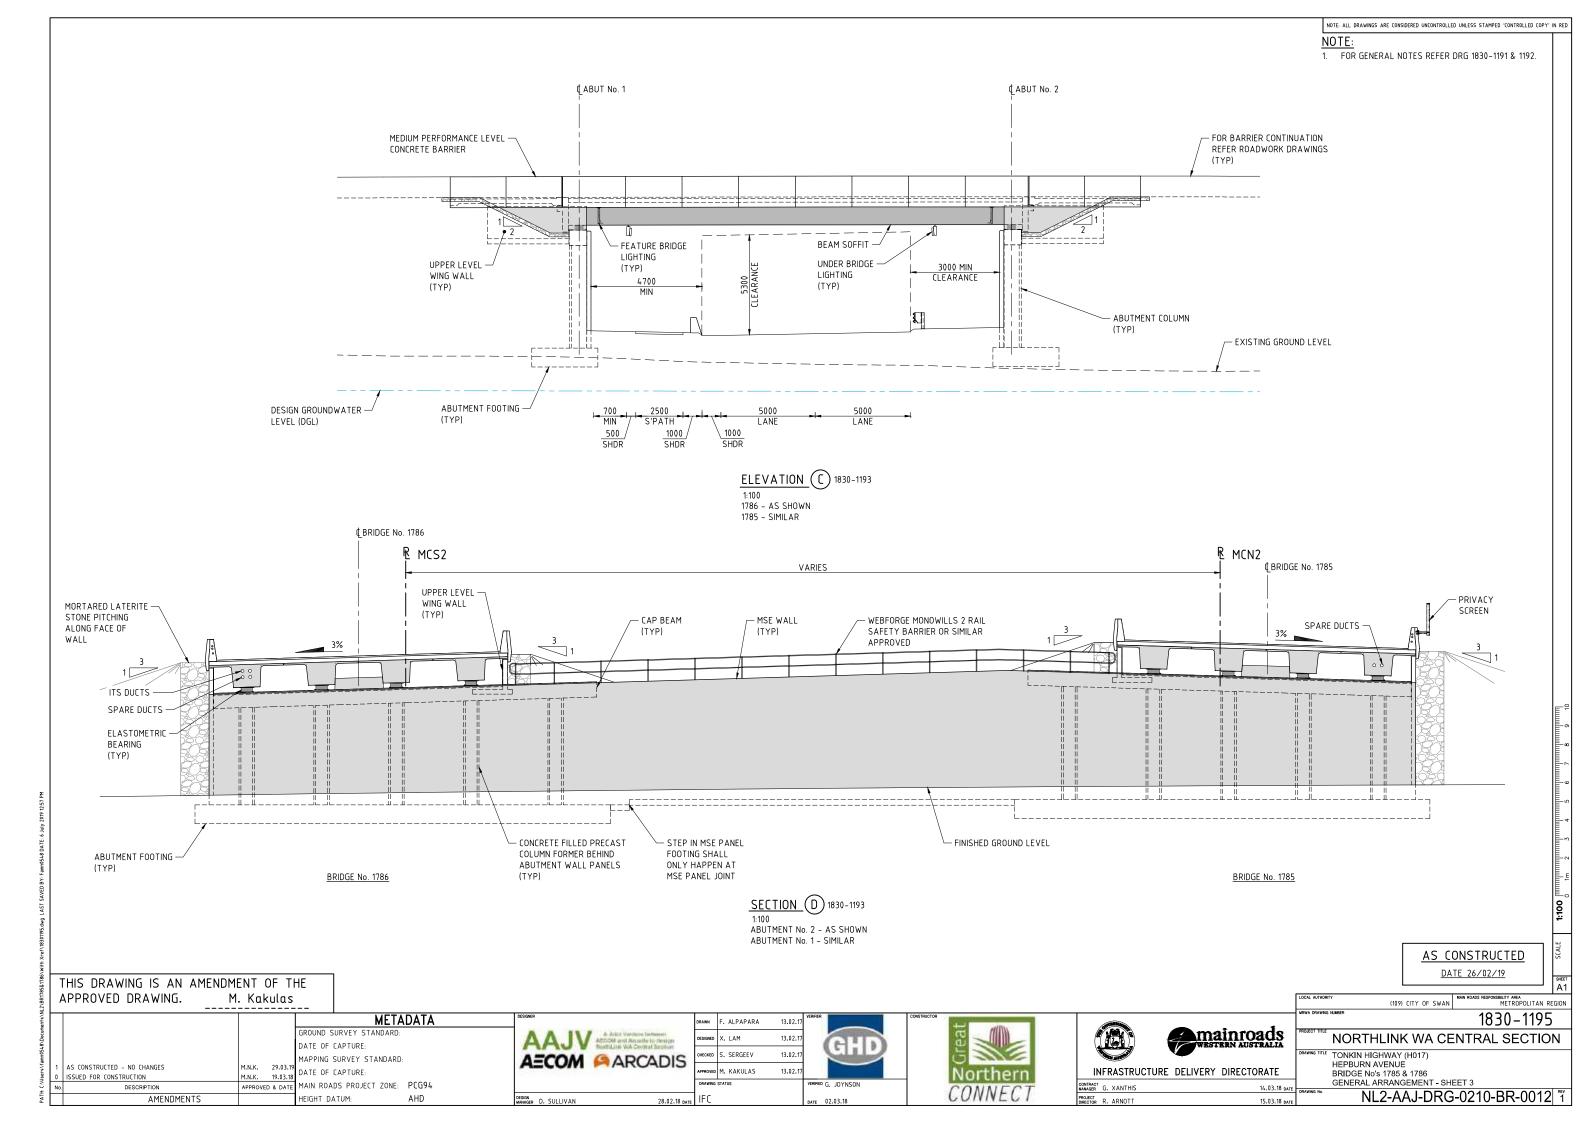

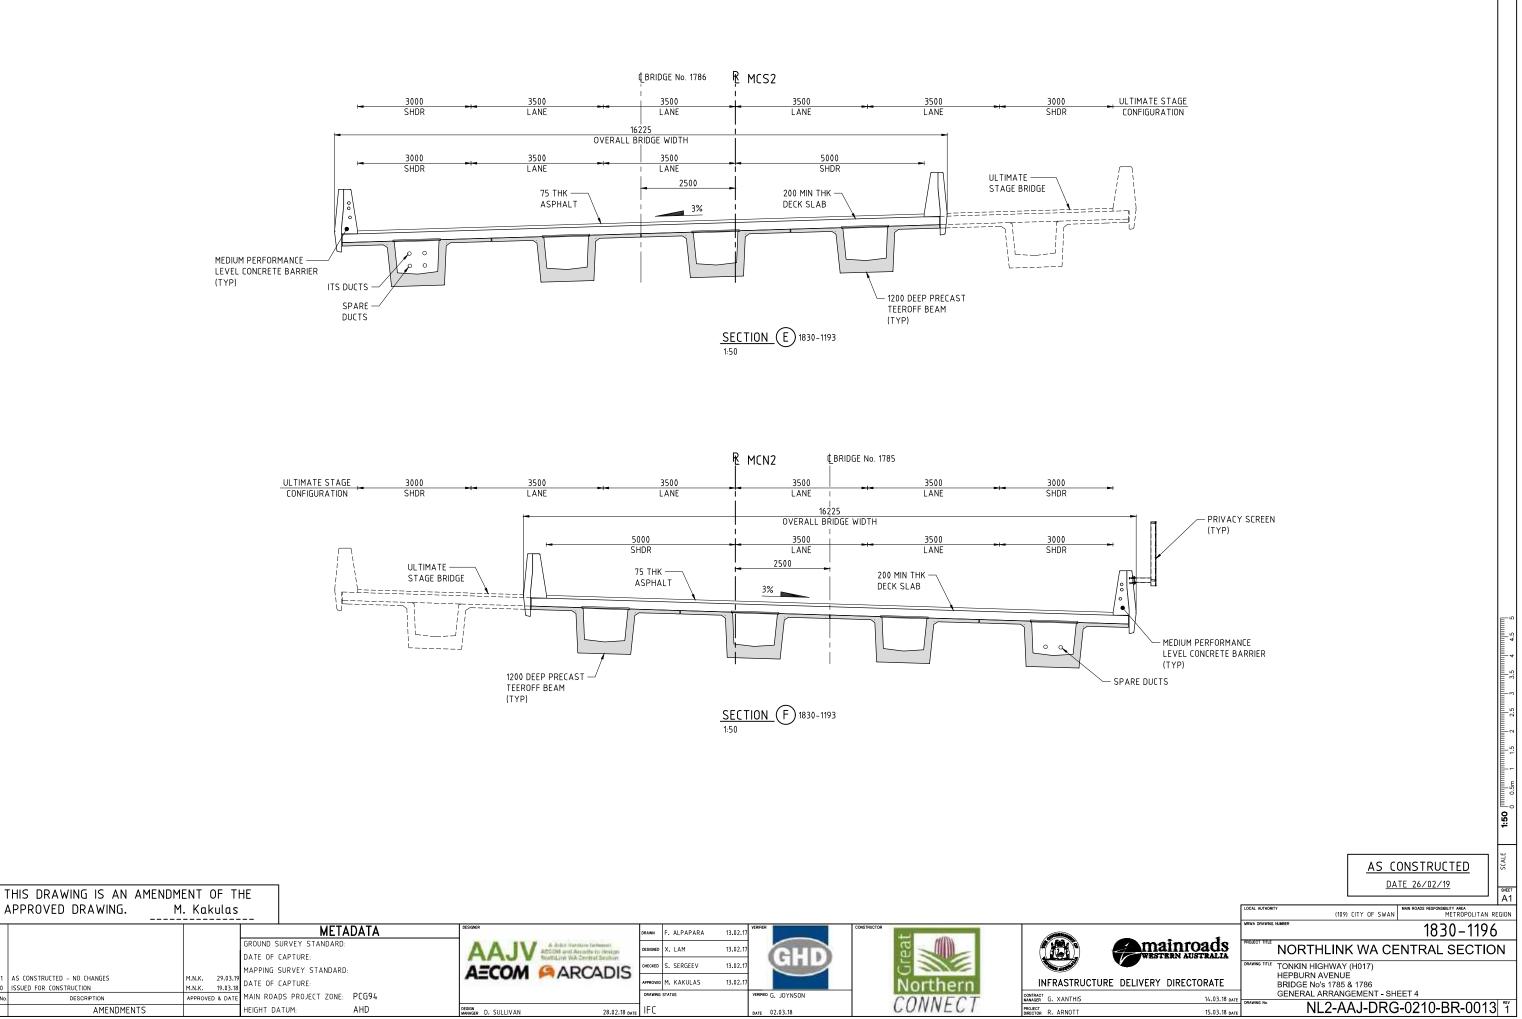

PROJECT DIRECTOR R. ARNOTT

NOTE: ALL DRAWINGS ARE CONSIDERED UNCONTROLLED UNLESS STAMPED 'CONTROLLED COPY' IN RED NOTE: 1. FOR GENERAL NOTES REFER DRG 1830-1191 & 1192.

1		GROUND SURVEY STANDA		DESIGNED J. NGUI
				drawn J. BUI
	APPROVED DRAWING. M. Kakula			
•	THIS DRAWING IS AN AMENDMENT OF	THE		
	NL2-AAJ-DRG-0220-BR-0135	1830-1275	SERVICES AND LIGHTING CONNECTION DETAILS	
	NL2-AAJ-DRG-0220-BR-0125	1830-1274	BALUSTRADE LAYOUT AND DETAILS	
	NL2-AAJ-DRG-0220-BR-0100	1830-1273	EXPANSION JOINT DETAILS	
	NL2-AAJ-DRG-0220-BR-0063	1830-1272	LINK SLAB CONCRETE AND REINFORCEMENT DETAI	_S
,	NL2-AAJ-DRG-0220-BR-0061	1830-1271	PRECAST BEAM REINFORCEMENT DETAILS - SHEET	2
	NL2-AAJ-DRG-0220-BR-0060	1830-1270	PRECAST BEAM REINFORCEMENT DETAILS - SHEET	1
	INF 5-449-0K0-6550-0K-6000	לס2ו - עכסו	FRECASI DEAM FRESTRESSING DETAILS	
	NL2-AAJ-DRG-0220-BR-0052 NL2-AAJ-DRG-0220-BR-0053	1830-1268	PRECAST BEAM LAYOUT AND DETAILS - SHEET 3 PRECAST BEAM PRESTRESSING DETAILS	
	NL2-AAJ-DRG-0220-BR-0051 NL2-AAJ-DRG-0220-BR-0052	1830-1268	PRECAST BEAM LAYOUT AND DETAILS - SHEET 2 PRECAST BEAM LAYOUT AND DETAILS - SHEET 3	
	NL2-AAJ-DRG-0220-BR-0050 NL2-AAJ-DRG-0220-BR-0051	1830-1266 1830-1267	PRECAST BEAM LAYOUT AND DETAILS - SHEET 1 PRECAST BEAM LAYOUT AND DETAILS - SHEET 2	
	NL2-AAJ-DRG-0220-BR-0050	1820 1266		
	NL2-AAJ-DRG-0220-BR-0046	1830-1265	BEARING DETAILS - SHEET 2	
	NL2-AAJ-DRG-0220-BR-0045	1830-1264	BEARING DETAILS - SHEET 1	
	SUPERSTRUCTURE			
	NL2-AAJ-DRG-0220-BR-0039	1830-1263	PIER REINFORCEMENT DETAILS	
	NL2-AAJ-DRG-0220-BR-0038	1830-1262	PIER FOOTING REINFORCEMENT DETAILS	
	NL2-AAJ-DRG-0220-BR-0037	1830-1261	SCREW PILE DETAILS	
	NL2-AAJ-DRG-0220-BR-0036	1830-1260	SCREW PILE LAYOUT	
	NL2-AAJ-DRG-0220-BR-0035	1830-1259	PIER CONCRETE DETAILS	
	NL2-AAJ-DRG-0220-BR-0030	1830-1258	ABUTMENT REINFORCEMENT DETAILS	
	NL2-AAJ-DRG-0220-BR-0022	1830-1257	ABUTMENT CONCRETE DETAILS - SHEET 3	
	NL2-AAJ-DRG-0220-BR-0021	1830-1256	ABUTMENT CONCRETE DETAILS - SHEET 2	
	NL2-AAJ-DRG-0220-BR-0020	1830-1255	ABUTMENT CONCRETE DETAILS - SHEET 1	
	SUBSTRUCTURE			
	NL2-AA J-DRG-0220-BR-0017	1830-1254	GEOMETRIC DATA	
	NL2-AA J-DRG-0220-BR-0015	1830-1253	BORE INFORMATION	
	NL2-AAJ-DRG-0220-BR-0011	1830-1252	GENERAL ARRANGEMENT - SHEET 2	
	NL2-AAJ-DRG-0220-BR-0010	1830-1251	GENERAL ARRANGEMENT - SHEET 1	
	NL2-AAJ-DRG-0220-BR-0006	1830-1250	GENERAL NOTES - SHEET 2	DRAWINGS
	NL2-AAJ-DRG-0220-BR-0005	1830-1249	GENERAL NOTES - SHEET 1	MRWA STANDARE
	NL2-AAJ-DRG-0220-BR-0002	1830-1248	INDEX	NL2-AAJ-DRG-0220-BR-016
	NL2-AAJ-DRG-0220-BR-0001	1830-1247	LOCALITY PLAN	NL2-AAJ-DRG-0220-BR-0162
	GENERAL			NL2-AAJ-DRG-0220-BR-0161
		MRWA DRG No.	DRAWING DESCRIPTION	DRAWING NUMBER
	DRAWING INDEX			

	MRWA DRG No.	DRAWING DESCRIPTION
	MRWA DRU NO.	DRAWING DESCRIPTION
0161	1830-1276	STAIR CONCRETE DETAILS - SHEET 1
0162	1830-1277	STAIR CONCRETE DETAILS – SHEET 2
0163	1830-1278	STAIR REINFORCEMENT DETAILS
RD		


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0630-1902


BRIDGE LIGHT POLE BASE - SHEET 1 BRIDGE LIGHT POLE BASE - SHEET 2

PPRUVED DRAWING.	M. Kakulas																	
		GROUND SURVE		DATA		A Joint Vieture Letter ACODI and Amatha bit	DRAW	-	BUI NGUI	24.02.17 24.02.17	ERIFIER		CONSTRUCTOR	eat				II WE
AS CONSTRUCTED - NO CHANGES SSUED FOR CONSTRUCTION	MNK 25.03.19	DATE OF CAPTU MAPPING SURVE DATE OF CAPTU	Y STANDARD:		AECOM	ARCA	DIS -	-	KEAGE	24.02.17 24.02.17		GHD		S	hern		NFRASTRUCT	
DESCRIPTION	APPROVED & DATE	MAIN ROADS PF	OJECT ZONE:	PCG94			DRA	WING ST/	TUS	v	VERIFIED G.	JOYNSON		COM	VECT	CONTRAC	G. XANTHIS	
AMENDMENTS		HEIGHT DATUM:		AHD	DESIGN MANAGER D. SULLIVAN		23.03.18 date IF	C		D	олте 27.0	03.18		CON	VELI	PROJECT DIRECTOR	R. ARNOTT	

	AS CONSTRUCTED	
	<u>DATE 26/02/19</u>	HEET
	LOCAL AUTHORITY (109) CITY DF SWAN MAN ROADS RESPONSIBILITY AREA METROPOLITAN REGIO	А1 0N
mainroads	INVA DRAVING INAREA INORTHLINK WA CENTRAL SECTION	
VESTERN AUSTRALIA	DRAWING TITLE TONKIN HIGHWAY (H017) HEPBURN AVENUE INTERCHANGE	\neg
/ERY DIRECTORATE 17.04.18 date	PEDESTRIAN FOOTBRIDGE No. 9425 INDEX NL2-AAJ-DRG-0220-BR-0002	^{≆v} 1
17.04.18 date		<u> </u>



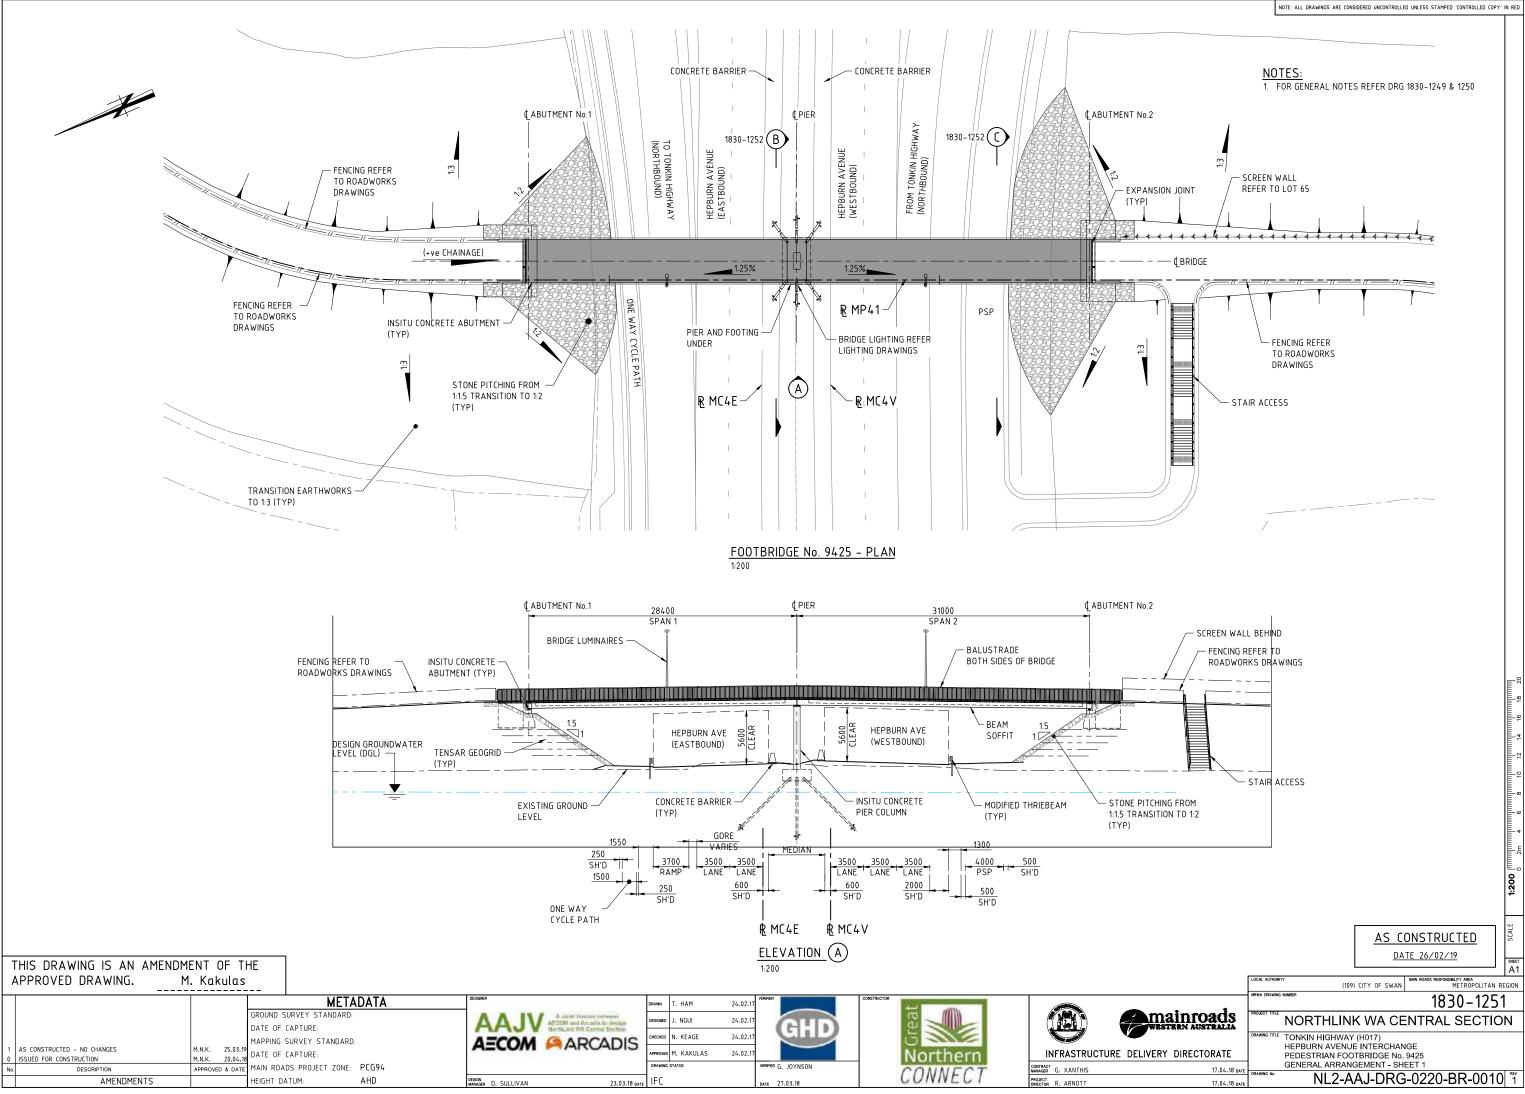

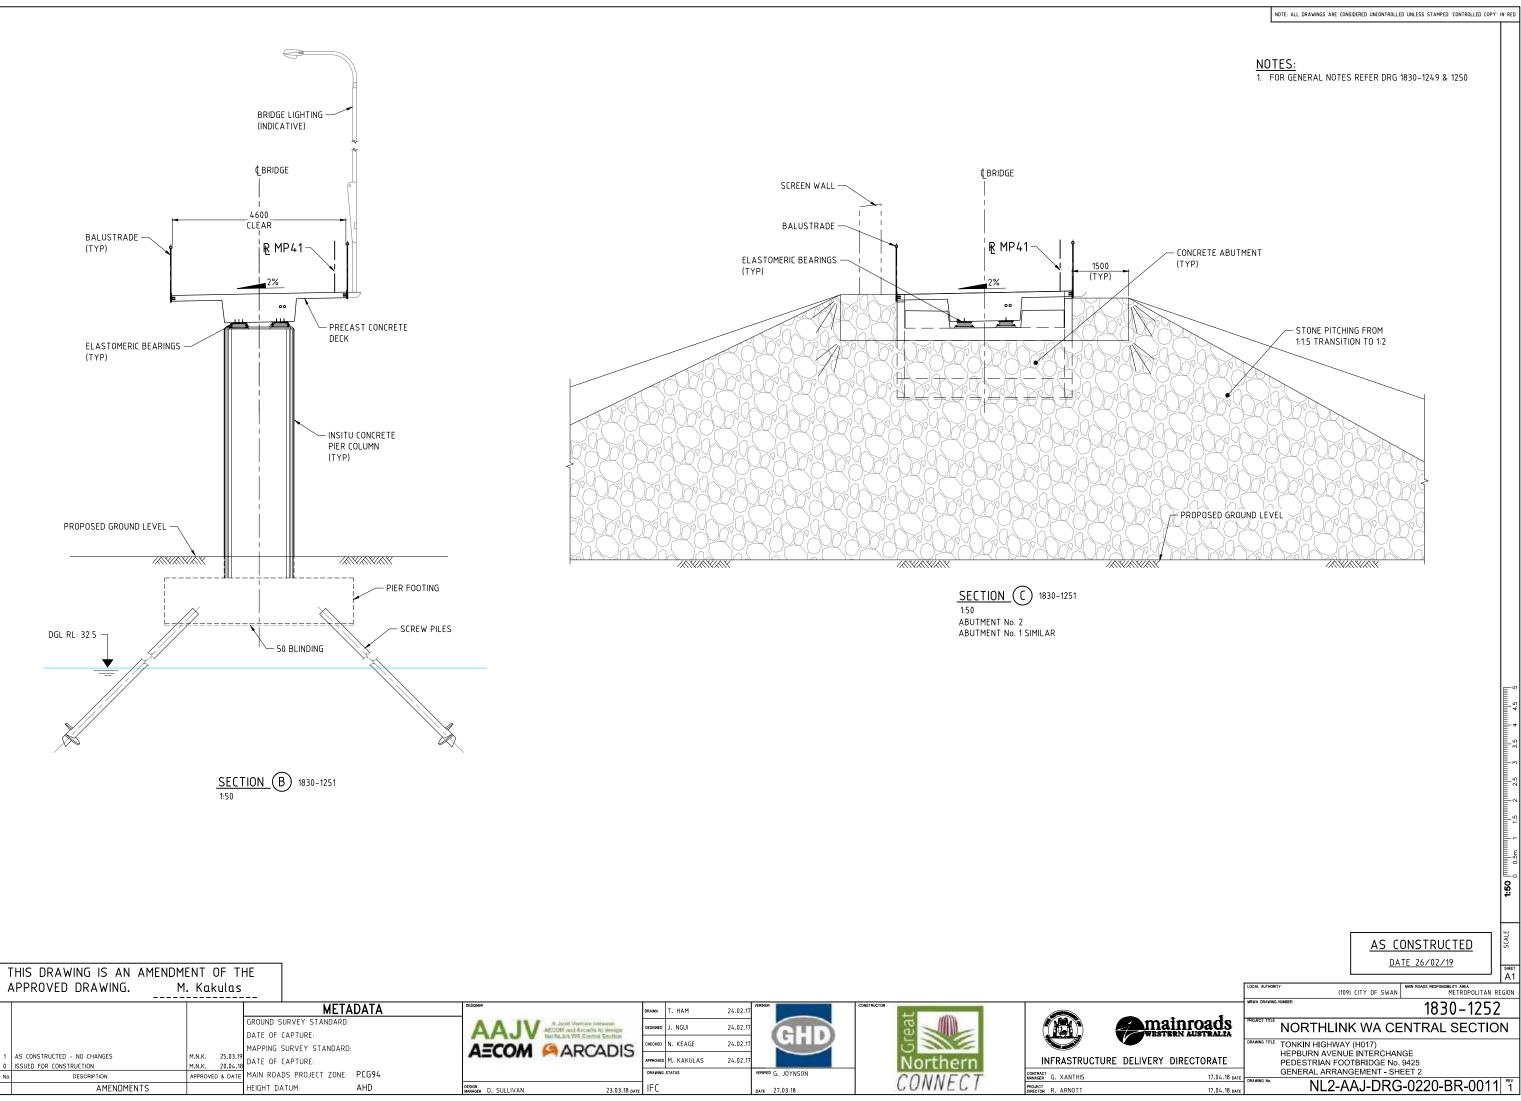

GENERAL NL2-AAJ-DRG-0230-BR-0001					
			NL2-AAJ-DRG-0230-BR-0071	1830–1315	DECK CONCRETE DETAILS - SHEET 2
	1830-1281	LOCALITY PLAN			
NL2-AAJ-DRG-0230-BR-0002	1830-1282	INDEX	NL2-AAJ-DRG-0230-BR-0073	1830-1316	DECK REINFORCEMENT DETAILS - SHEET 1
	1050-1202		NL2-AAJ-DRG-0230-BR-0074	1830-1317	DECK REINFORCEMENT DETAILS - SHEET 2
NL2-AAJ-DRG-0230-BR-0005	1830-1283	GENERAL NOTES – SHEET 1			
NL2-AAJ-DRG-0230-BR-0006	1830-1284	GENERAL NOTES - SHEET 2	NL2-AAJ-DRG-0230-BR-0090	1830-1318	APPROACH SLAB CONCRETE DETAILS
	1050 1201		NL2-AAJ-DRG-0230-BR-0091	1830-1319	APPROACH SLAB REINFORCEMENT DETAILS
NL2-AAJ-DRG-0230-BR-0010	1830-1285	GENERAL ARRANGEMENT – SHEET 1			
NL2-AAJ-DRG-0230-BR-0011	1830-1286	GENERAL ARRANGEMENT - SHEET 2	NL2-AAJ-DRG-0230-BR-0100	1830-1320	EXPANSION JOINT DETAILS - SHEET 1
NL2-AAJ-DRG-0230-BR-0012	1830-1287	GENERAL ARRANGEMENT - SHEET 3	NL2-AAJ-DRG-0230-BR-0101	1830-1321	EXPANSION JOINT DETAILS - SHEET 2
	1050 1207				
NL2-AAJ-DRG-0230-BR-0015	1830-1288	BORE INFORMATION – SHEET 1	NL2-AAJ-DRG-0230-BR-0105	1830-1322	COVER PLATE DETAILS - SHEET 1
NL2-AAJ-DRG-0230-BR-0016	1830-1289	BORE INFORMATION - SHEET 2	NL2-AAJ-DRG-0230-BR-0106	1830-1323	COVER PLATE DETAILS - SHEET 2
NL2-AAJ-DRG-0230-BR-0017	1830-1290	GEOMETRIC DATA	NL2-AAJ-DRG-0230-BR-0107	1830-1324	COVER PLATE DETAILS - SHEET 3
SUBSTRUCTURE			NL2-AAJ-DRG-0230-BR-0110	1830-1325	BARRIER LAYOUT
			NL2-AAJ-DRG-0230-BR-0111	1830-1326	PRECAST BARRIER CONCRETE DETAILS
NL2-AAJ-DRG-0230-BR-0020	1830-1291	ABUTMENT - MSE WALL LAYOUT	NL2-AAJ-DRG-0230-BR-0112	1830-1327	BARRIER CONNECTION DETAILS
NL2-AAJ-DRG-0230-BR-0021	1830-1292	ABUTMENT No.1 - MSE WALL	NL2-AAJ-DRG-0230-BR-0113	1830-1328	BARRIER DETAILS
NL2-AAJ-DRG-0230-BR-0022	1830-1293	ABUTMENT No. 2 - MSE WALL	NL2-AAJ-DRG-0230-BR-0114	1830-1329	BARRIER TRANSITION DETAILS
NL2-AAJ-DRG-0230-BR-0023	1830-1294	ABUTMENT - MSE WALL TYPICAL DETAILS	NL2-AAJ-DRG-0230-BR-0115	1830-1330	MEDIAN BARRIER TRANSITION DETAILS
NL2-AAJ-DRG-0230-BR-0024	1830-1295	COLUMN FORMER DETAILS	NL2-AAJ-DRG-0230-BR-0116	1830-1331	PATH BARRIER TRANSITION DETAILS
NL2-AAJ-DRG-0230-BR-0025	1830-1296	ABUTMENT No.1 - CONCRETE DETAILS	NL2-AAJ-DRG-0230-BR-0117	1830-1332	PRECAST PARAPET & BALUSTRADE LAYOUT
NL2-AAJ-DRG-0230-BR-0026	1830-1297	ABUTMENT No. 2 - CONCRETE DETAILS	NL2-AAJ-DRG-0230-BR-0118	1830-1333	PRECAST PARAPET DETAILS
NL2-AAJ-DRG-0230-BR-0027	1830-1298	ABUTMENT – TYPICAL CONCRETE DETAILS	NL2-AAJ-DRG-0230-BR-0119	1830-1334	PEDESTRIAN BALUSTRADE DETAILS
NL2-AAJ-DRG-0230-BR-0028	1830-1299	ABUTMENT - REINFORCEMENT DETAILS - SHEET 1			
NL2-AAJ-DRG-0230-BR-0029	1830-1300	ABUTMENT - REINFORCEMENT DETAILS - SHEET 2	NL2-AAJ-DRG-0230-BR-0135	1830-1335	ELECTRICAL LAYOUT
NL2-AAJ-DRG-0230-BR-0030	1830-1301	COLUMN REINFORCEMENT DETAILS	NL2-AAJ-DRG-0230-BR-0136	1830-1336	ELECTRICAL DETAILS
			NL2-AAJ-DRG-0230-BR-0137	1830-1337	LUMINAIRE BRACKET DETAILS
NL2-AAJ-DRG-0230-BR-0032	1830-1302	WING WALL DETAILS			
NL2-AAJ-DRG-0230-BR-0033	1830-1303	WING WALL REINFORCEMENT DETAILS	NL2-AAJ-DRG-0230-BR-0140	1830-1338	STAIRS PLAN & PROFILE
			NL2-AAJ-DRG-0230-BR-0141	1830-1339	STAIRS REINFORCEMENT
NL2-AAJ-DRG-0230-BR-0035	1830-1304	RETAINING WALL DETAILS – SHEET 1	NL2-AAJ-DRG-0230-BR-0142	1830-1340	STAIRS DETAILS & HANDRAIL
NL2-AAJ-DRG-0230-BR-0036	1830-1305	RETAINING WALL DETAILS - SHEET 2			
NL2-AAJ-DRG-0230-BR-0037	1830-1306	RETAINING WALL REINFORCEMENT DETAILS	NL2-AAJ-DRG-0230-BR-0155	1830-1341	BRIDGE 1787 – DESIGN SUMMARY – SHEET 1 (TO FOLI
SUPERSTRUCTURE			NL2-AAJ-DRG-0230-BR-0156	1830-1342	BRIDGE 1787 - DESIGN SUMMARY - SHEET 2 (TO FOL
NL2-AAJ-DRG-0230-BR-0045	1830-1307	BEARING DETAILS - SHEET 1	NL2-AAJ-DRG-0230-BR-0157	1830-1343	BRIDGE 1811 – DESIGN SUMMARY – SHEET 1 (TO FOLL
NL2-AAJ-DRG-0230-BR-0046	1830-1308	BEARING DETAILS - SHEET 2	NL 2-AA J-DRG-0230-BR-0158	1830-1344	BRIDGE 1811 – DESIGN SUMMARY – SHEET 2 (TO FOLL
			NE2-AA)-DIG-0250-DI-0150	1050-1544	DRIDGE IOTI - DESIGN SOFTIART - SHEET 2 (TO FOL
NL2-AAJ-DRG-0230-BR-0050	1830-1309	PRECAST TEEROFF BEAM LAYOUT			
NL2-AAJ-DRG-0230-BR-0052	1830-1310	PRECAST TEEROFF - CONCRETE DETAILS - SHEET 1	DRAWINGS	01-20-4241	
NL2-AAJ-DRG-0230-BR-0053	1830–1311	PRECAST TEEROFF - CONCRETE DETAILS - SHEET 2	-	0430-1314	PRECAST PARAPET PANELS
			-	0530-1087-1	BRIDGE BALUSTRADE FOR PSP - SHEET № 1
NL2-AAJ-DRG-0230-BR-0057	1830-1312	PRECAST TEEROFF - PRESTRESSING DETAILS	-	0530-1307-1	BRIDGE BALUSTRADE FOR PSP - SHEET No 2
			-	630-1901	BRIDGE LIGHT POLE BASE - SHEET No. 1
NL2-AAJ-DRG-0230-BR-0060	1830-1313	PRECAST TEEROFF - REINFORCEMENT DETAILS	-	630-1902 200448-3008-4	BRIDGE LIGHT POLE BASE – SHEET №. 2 PSP LIGHTING POLE DETAIL
				200440 2000-4	

APPROVED DRAWING.


AMENDMENTS


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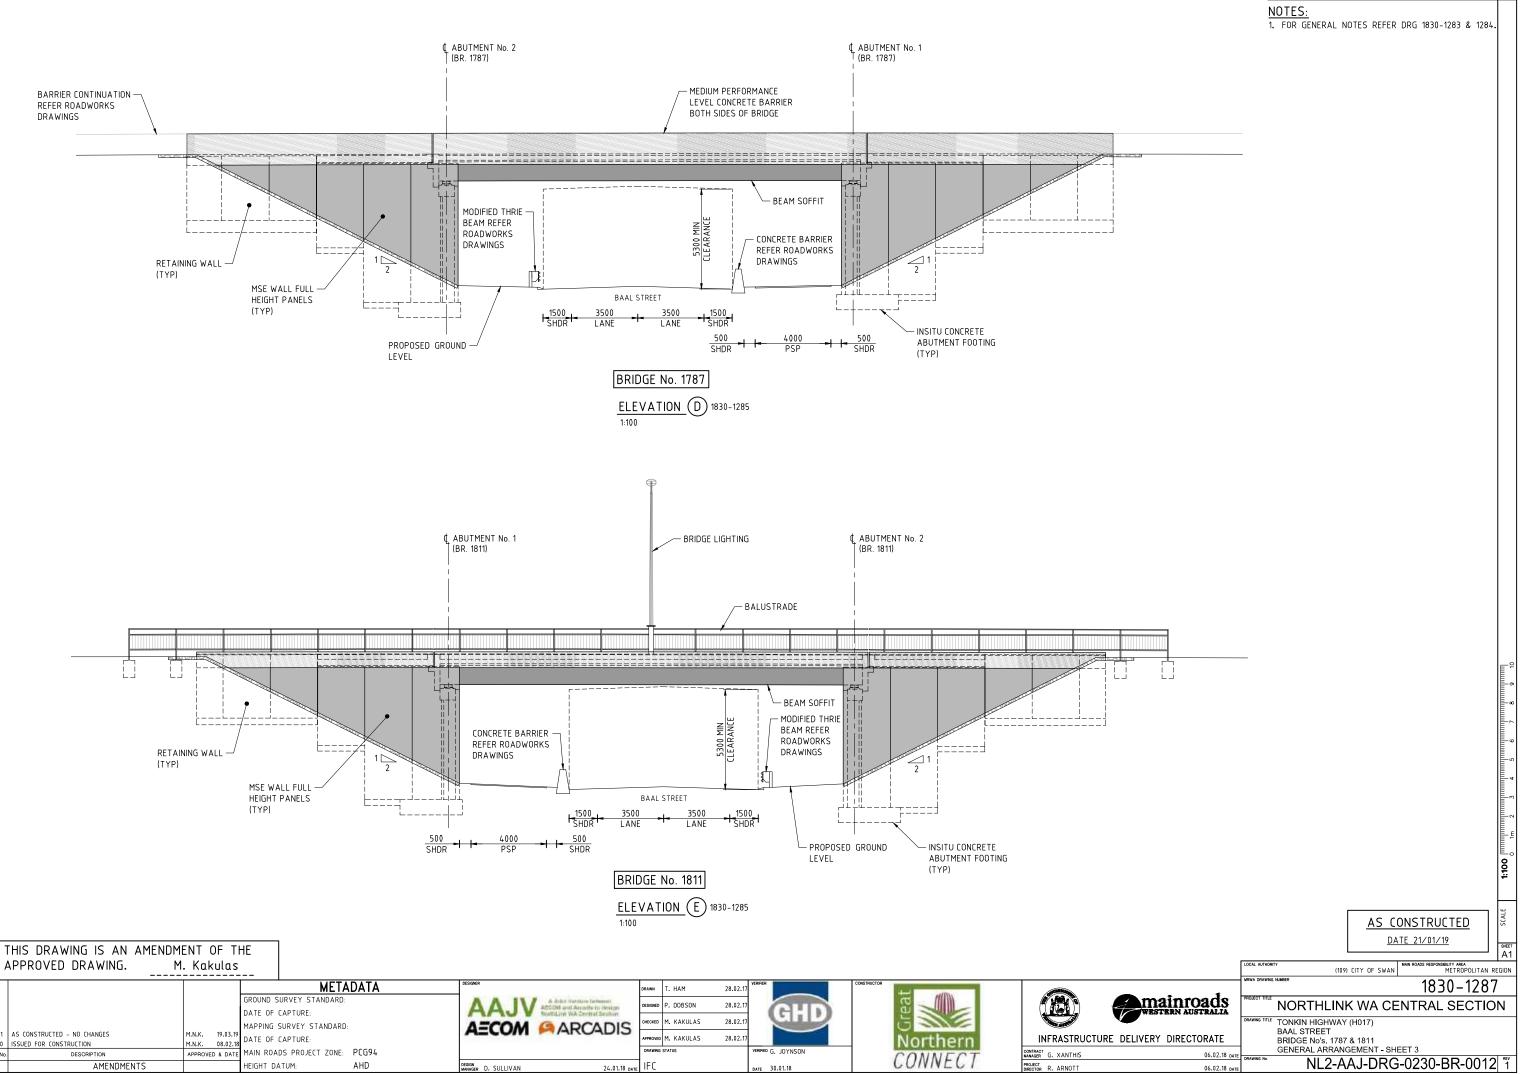
AHD

DRAWN A. HAWTON 28.02.17 Grea DESIGNED P. DOBSON 28.02.17 GHD CHECKED M. KAKULAS 28.02.17 ED M. KAKULAS 28.02.17 Northern ING STATUS RIFIED G. JOYNSON CONTRACT MANAGER G. XANTHIS PROJECT DRECTOR R. ARNOTT CONNEC 24.01.18 DATE IFC DESIGN MANAGER D. SULLIVAN date 30.01.18

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	AS CONSTRUCTED
	DATE 21/01/19
	LOCAL AUTHORITY (109) CITY OF SWAN MAN ROADS RESPONDENTLY AREA (109) CITY OF SWAN
- main mada	инил оллино лавее 1830 – 1282 Инолеот Inte
WESTERN AUSTRALIA	DRAWING TITLE TONKIN HIGHWAY (H017)
INFRASTRUCTURE DELIVERY DIRECTORATE	BAAL STREET BRIDGE No's. 1787 & 1811
TRACT G. XANTHIS 06.02.18 DATE GGR G. ARNOTT 06.02.18 DATE	INDEX DRAWING THE NL2-AAJ-DRG-0230-BR-0002 1
ECTOR R. ARNOTT 06.02.18 DATE	



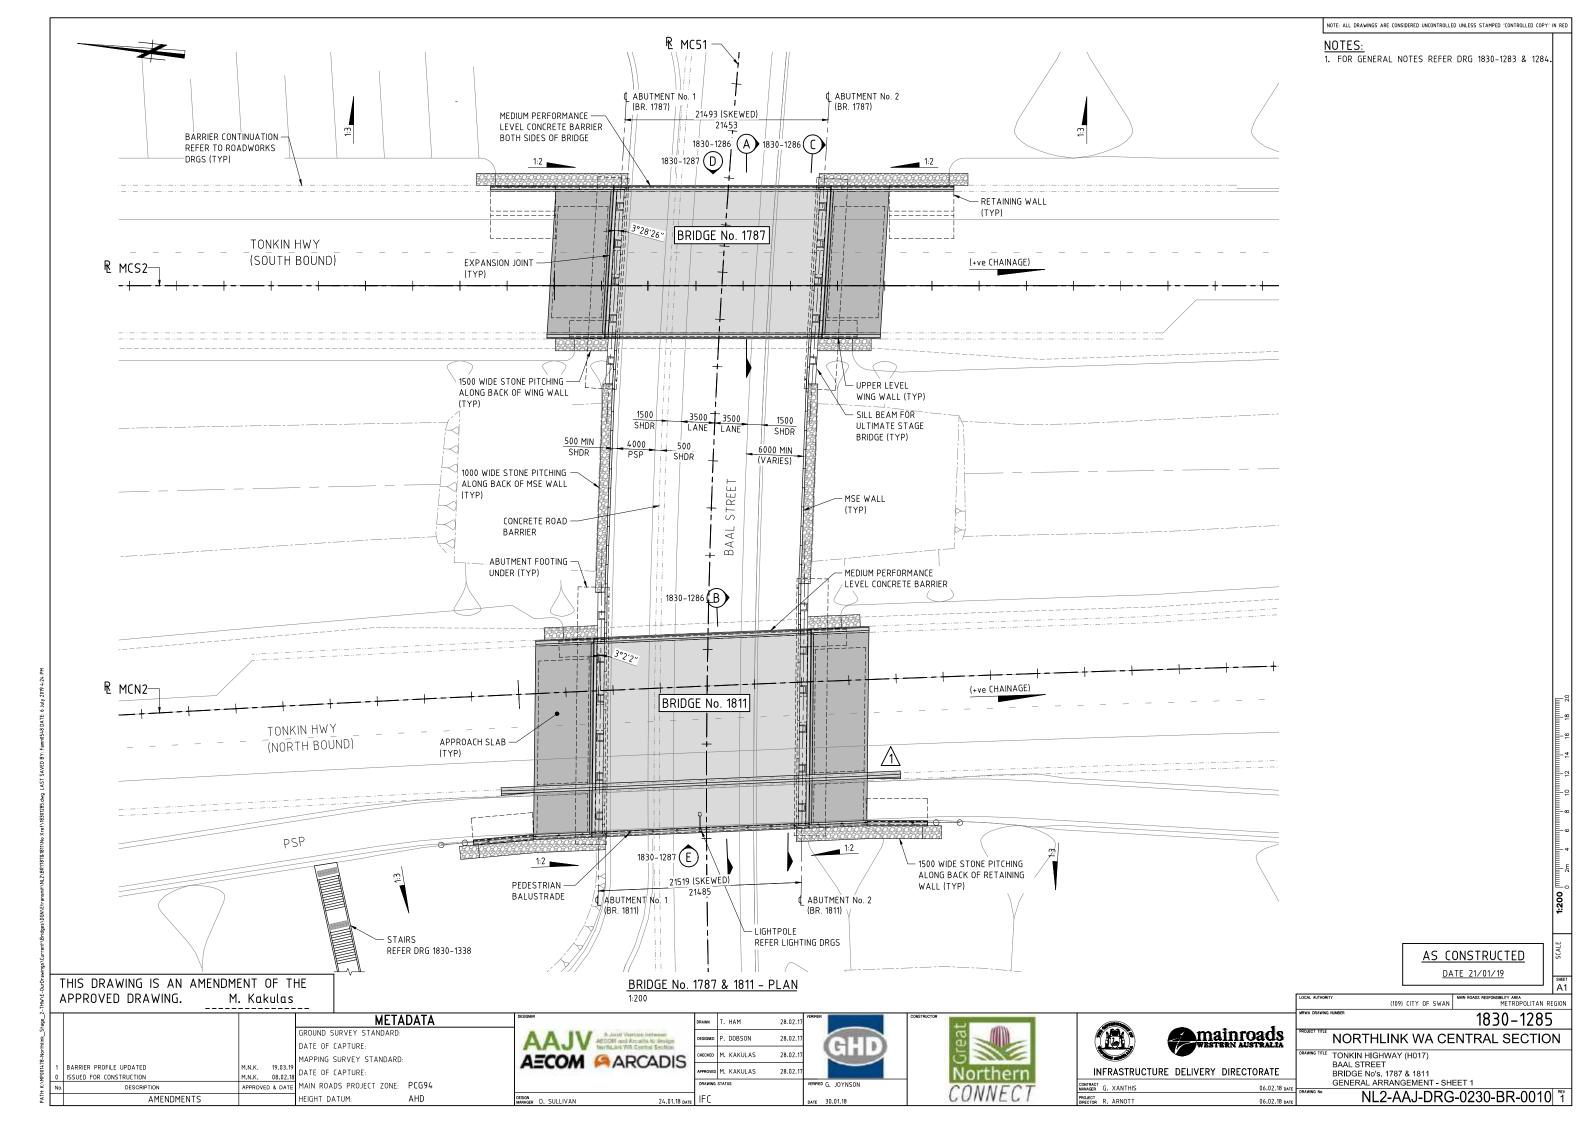

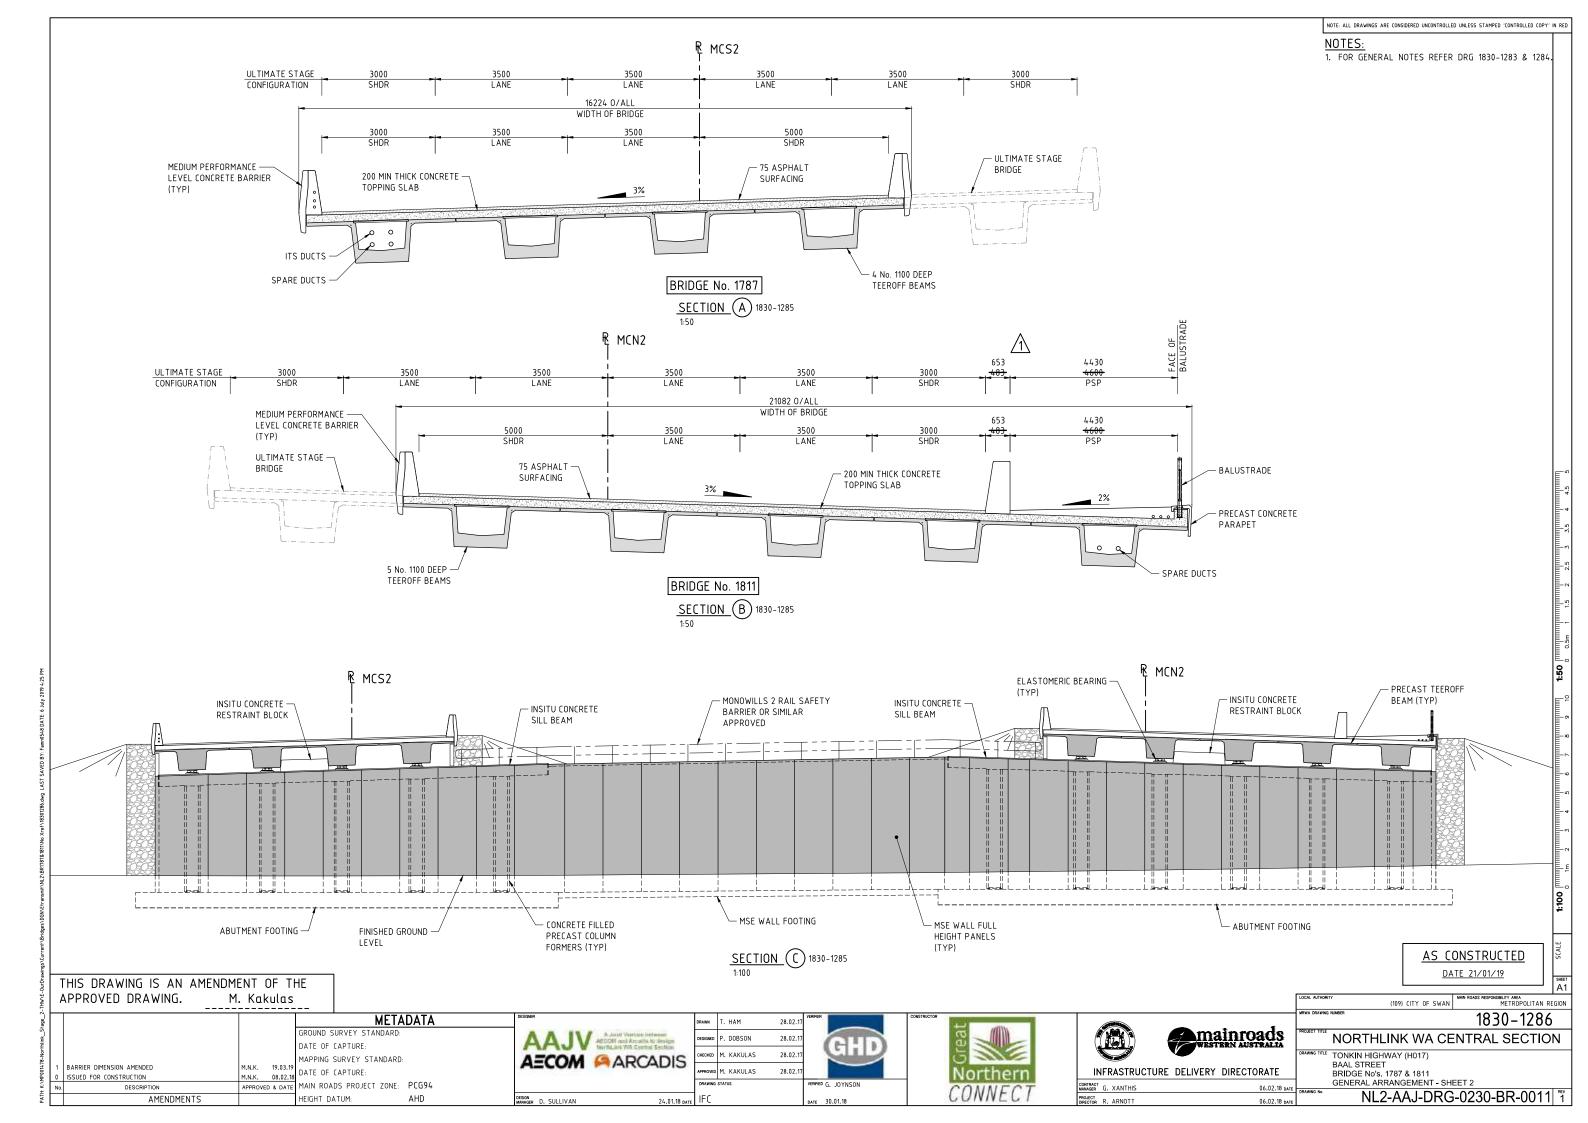

	NO	TE: ALL	DRAWINGS	ARE	CONSIDERED	UNCONTROLLED	UNLESS	STAMPED	'CONTR	OLLED	COPY'	IN	RED
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GENERAL	<u>MRWA DRG No.</u>	DRAWING DESCRIPTION	<u>DRAWING NUMBER</u> NL2-AAJ-DRG-0300-BR-0054	<u>MRWA DRG No.</u> 1830-1396	<u>DRAWING DESCRIPTION</u> PRECAST TEEROFF - CONCRETE DETAILS - SHEET 2	DRAWING NUMBER MRWA STAND
IL2-AAJ-DRG-0300-BR-0001	1830-1362	LOCALITY PLAN				DRAWINGS
IL2-AAJ-DRG-0300-BR-0002	1830-1363	INDEX	NL2-AAJ-DRG-0300-BR-0057	1830-1397	PRECAST TEEROFF - PRESTRESSING DETAILS - SHEET 1	
			NL2-AAJ-DRG-0300-BR-0058	1830-1398	PRECAST TEEROFF - PRESTRESSING DETAILS - SHEET 2	
IL2-AAJ-DRG-0300-BR-0005	1830-1364	GENERAL NOTES - SHEET 1				
IL2-AAJ-DRG-0300-BR-0006	1830-1365	GENERAL NOTES - SHEET 2	NL2-AAJ-DRG-0300-BR-0060	1830-1399	PRECAST TEEROFF - REINFORCEMENT DETAILS - SHEET 1	
IL2-AAJ-DRG-0300-BR-0010	1830-1366	GENERAL ARRANGEMENT - SHEET 1	NL2-AAJ-DRG-0300-BR-0061	1830-1400	PRECAST TEEROFF - REINFORCEMENT DETAILS - SHEET 2	
IL2-AAJ-DRG-0300-BR-0011	1830-1367	GENERAL ARRANGEMENT - SHEET 2	NL2-AAJ-DRG-0300-BR-0062	1830-1401	PRECAST TEEROFF - REINFORCEMENT DETAILS - SHEET 3	
IL2-AAJ-DRG-0300-BR-0012	1830-1368	GENERAL ARRANGEMENT - SHEET 3	NL2-AAJ-DRG-0300-BR-0063	1830-1402	PRECAST TEEROFF - REINFORCEMENT DETAILS - SHEET 4	
			NL2-AAJ-DRG-0300-BR-0064	1830-1403	PRECAST TEEROFF - REINFORCEMENT DETAILS - SHEET 5	
	1020 12/0					
IL2-AAJ-DRG-0300-BR-0015	1830-1369	BORE INFORMATION - SHEET 1	NL2-AAJ-DRG-0300-BR-0070	1830-1404	DECK CONCRETE DETAILS - SHEET 1	
IL2-AAJ-DRG-0300-BR-0016	1830-1370	BORE INFORMATION - SHEET 2	NL2-AAJ-DRG-0300-BR-0071	1830-1405	DECK CONCRETE DETAILS - SHEET 2	
IL2-AAJ-DRG-0300-BR-0017	1830-1371	GEOMETRIC DATA	NL2-AAJ-DRG-0300-BR-0072	1830-1406	DECK CONCRETE DETAILS - SHEET 3	
			NL2-AAJ-DRG-0300-BR-0073	1830-1407	DECK REINFORCEMENT DETAILS - SHEET 1	
IL2-AAJ-DRG-0300-BR-0020	1830-1372	ABUTMENT - MSE WALL LAYOUT	NL2-AAJ-DRG-0300-BR-0074	1830-1408	DECK REINFORCEMENT DETAILS - SHEET 2	
IL2-AAJ-DRG-0300-BR-0021	1830-1373	ABUTMENT No.1 – MSE WALL	NL2-AAJ-DRG-0300-BR-0075	1830-1409	DIAPHRAGM DETAILS	
IL2-AAJ-DRG-0300-BR-0022	1830-1374	ABUTMENT No. 2 – MSE WALL	NL2-AAJ-DRG-0300-BR-0076	1830-1410	CONTINUITY STITCH REINFORCEMENT DETAILS	
IL2-AAJ-DRG-0300-BR-0023	1830-1375	ABUTMENT - MSE WALL TYPICAL DETAILS				
IL2-AAJ-DRG-0300-BR-0024	1830-1376		NL2-AAJ-DRG-0300-BR-0090	1830-1411	APPROACH SLAB CONCRETE DETAILS	
IL2-AAJ-DRG-0300-BR-0025	1830-1377	ABUTMENT No.1 - CONCRETE DETAILS	NL2-AAJ-DRG-0300-BR-0091	1830-1412	APPROACH SLAB REINFORCEMENT DETAILS	
IL2-AAJ-DRG-0300-BR-0026	1830-1378	ABUTMENT No. 2 - CONCRETE DETAILS				
IL2-AAJ-DRG-0300-BR-0027	1830-1379	ABUTMENT - TYPICAL CONCRETE DETAILS	NL2-AAJ-DRG-0300-BR-0100	1830-1413	EXPANSION JOINT DETAILS	
IL2-AAJ-DRG-0300-BR-0028	1830-1380					
IL2-AAJ-DRG-0300-BR-0029	1830-1381		NL2-AAJ-DRG-0300-BR-0105	1830-1414	COVER PLATE DETAILS - SHEET 1	
IL2-AAJ-DRG-0300-BR-0030	1830-1382	ABUTMENT - REINFORCEMENT DETAILS - SHEET 1	NL2-AAJ-DRG-0300-BR-0106	1830-1415	COVER PLATE DETAILS - SHEET 2	
IL2-AAJ-DRG-0300-BR-0031	1830-1383	ABUTMENT - REINFORCEMENT DETAILS - SHEET 2				
IL2-AAJ-DRG-0300-BR-0032 IL2-AAJ-DRG-0300-BR-0033	1830-1384 1830-1385	ABUTMENT - REINFORCEMENT DETAILS - SHEET 3 COLUMN REINFORCEMENT DETAILS	NL2-AAJ-DRG-0300-BR-0110	1830-1416	BARRIER LAYOUT	
ILZ-AAJ-DRU-0300-DR-0033	2021-0201	COLOMN REINFORCEMENT DETAILS	NL2-AAJ-DRG-0300-BR-0111	1830-1417	PRECAST BARRIER CONCRETE DETAILS	
IL2-AAJ-DRG-0300-BR-0035	1830-1386	PIER - CONCRETE DETAILS - SHEET 1	NL2-AAJ-DRG-0300-BR-0112	1830-1418	BARRIER CONNECTION DETAILS	
IL2-AAJ-DRG-0300-BR-0036	1830-1387	PIER - CONCRETE DETAILS - SHEET 1				
L2-AAJ-DRG-0300-BR-0030	1830-1388	PIER - CONCRETE DETAILS - SHEET 2 PIER - REINFORCEMENT DETAILS - SHEET 1	NL2-AAJ-DRG-0300-BR-0115	1830-1419	BARRIER DETAILS	
IL2-AAJ-DRG-0300-BR-0037	1830-1389	PIER - REINFORCEMENT DETAILS - SHEET 1	NL2-AAJ-DRG-0300-BR-0116	1830-1420	BARRIER TRANSITION DETAILS - SHEET 1	
12-AAJ-DKU-0300-DK-0030	1010-1007	FILK - REINFORCEFIENT DETAILS - SHEET Z	NL2-AAJ-DRG-0300-BR-0117	1830-1421	BARRIER TRANSITION DETAILS - SHEET 2	
SUPERSTRUCTURE			NL 2 – A A J – DRG – 0300 – BR – 0135	1830-1422	LIGHTING AND ELECTRICAL LAYOUT	
IL2-AAJ-DRG-0300-BR-0045	1830-1390	BEARING DETAILS - SHEET 1	NL2-AAJ-DRG-0300-BR-0136	1830-1423		
IL2-AAJ-DRG-0300-BR-0046	1830-1391	BEARING DETAILS - SHEET 2	NL2-AAJ-DRG-0300-BR-0137	1830-1424	LIGHTPOLE CONTROL BOX DETAILS	
IL2-AAJ-DRG-0300-BR-0047	1830-1392	BEARING DETAILS - SHEET 3	NL2-AAJ-DRG-0300-BR-0138	1830-1425		
			NL2-AAJ-DRG-0300-BR-0139	1830-1426		
IL2-AAJ-DRG-0300-BR-0050	1830-1393	PRECAST TEEROFF BEAMS LAYOUT		1050 1420		
			NL2-AAJ-DRG-0300-BR-0155	1830-1427	DESIGN SUMMARY - SHEET 1 (TO FOLLOW)	
IL2-AAJ-DRG-0300-BR-0052	1830-1394	PRECAST TEEROFF BEAM TYPICAL DETAILS	NL2-AAJ-DRG-0300-BR-0156	1830-1428	DESIGN SUMMARY - SHEET 2 (TO FOLLOW)	
IL2-AAJ-DRG-0300-BR-0053	1830-1395	PRECAST TEEROFF - CONCRETE DETAILS - SHEET 1				
DRAWING IS AN AMEND						
OVED DRAWING.	1. Kakulas					
		METADATA	DRAWN	MORRISON 10.10.17	CONSTRUCTOR	
	GROU	ND SURVEY STANDARD:	A Joint Verture Information Design Designed N ArtCODI and Arcanta to Verture Section	I. KEAGE 10.10.17		

date 12.03.18

07.03.18 DATE IFC

AMENDMENTS

APPROVED & DATE MAIN ROADS PROJECT ZONE: PCG94

HEIGHT DATUM:

AHD

DESIGN MANAGER D. SULLIVAN

INFRASTRUCTURE DELIVERY DIRECTORATE CONTRACT G. XANTHIS MANAGER G. XANTHIS PROJECT DIRECTOR R. ARNOTT


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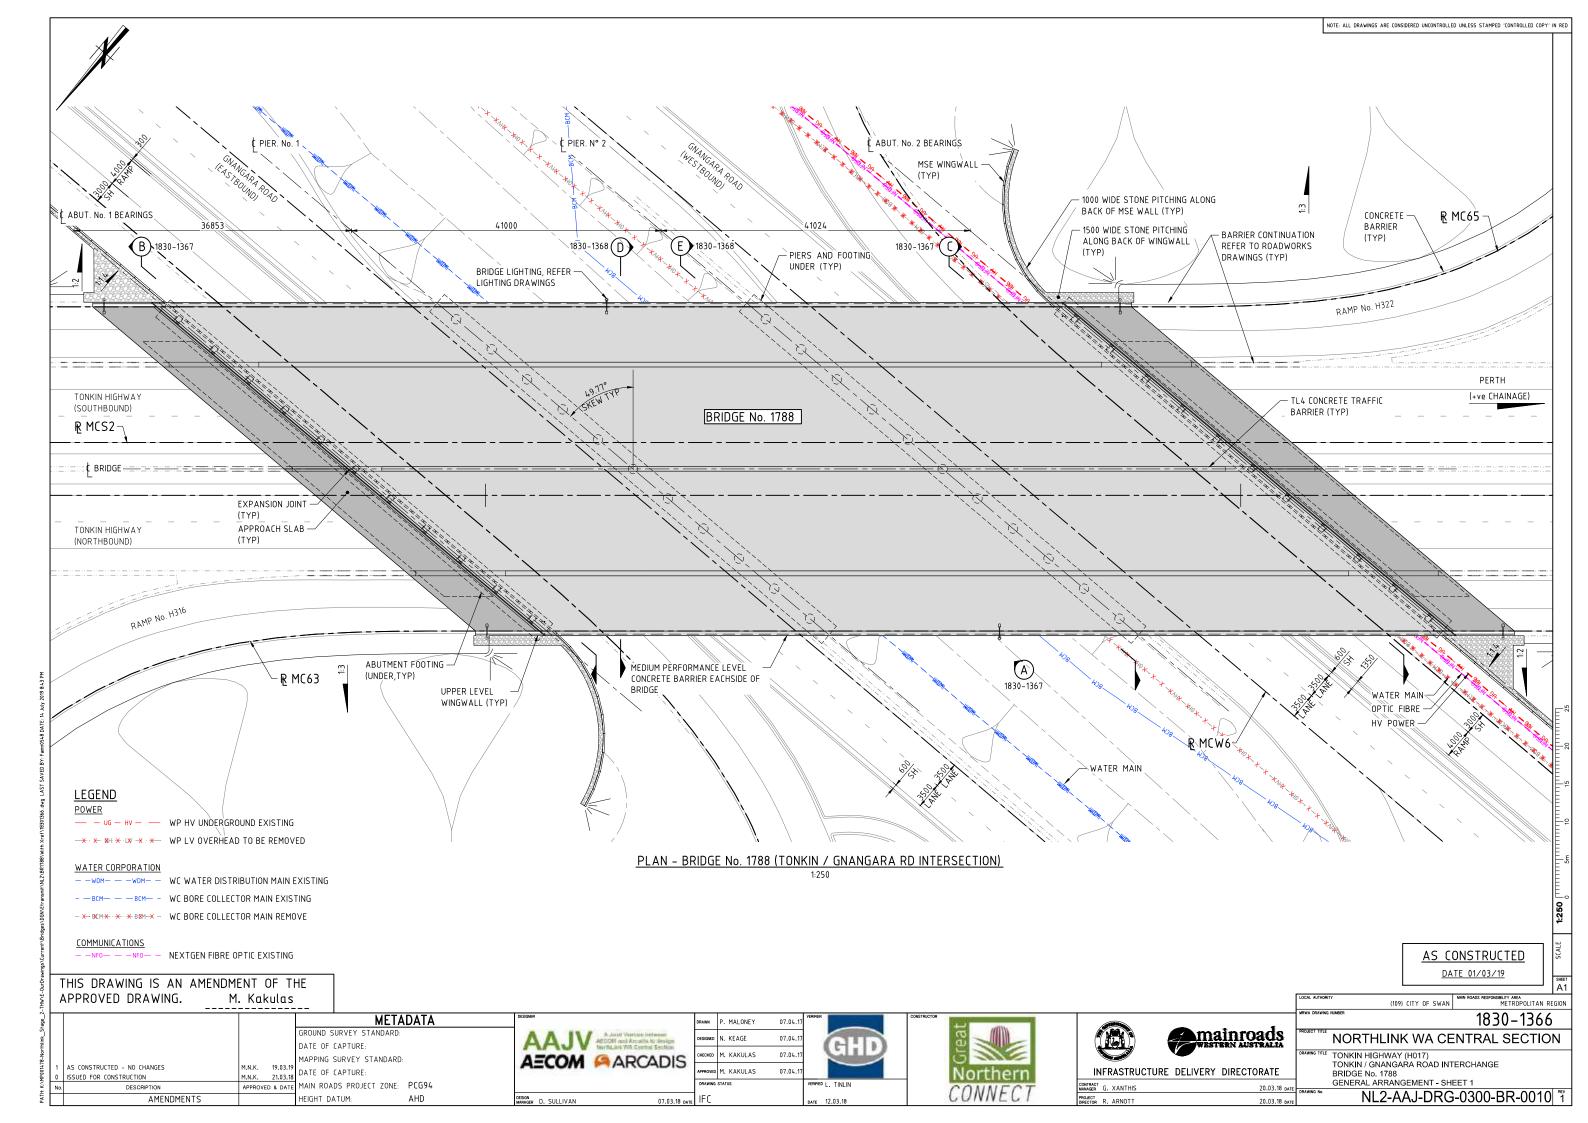
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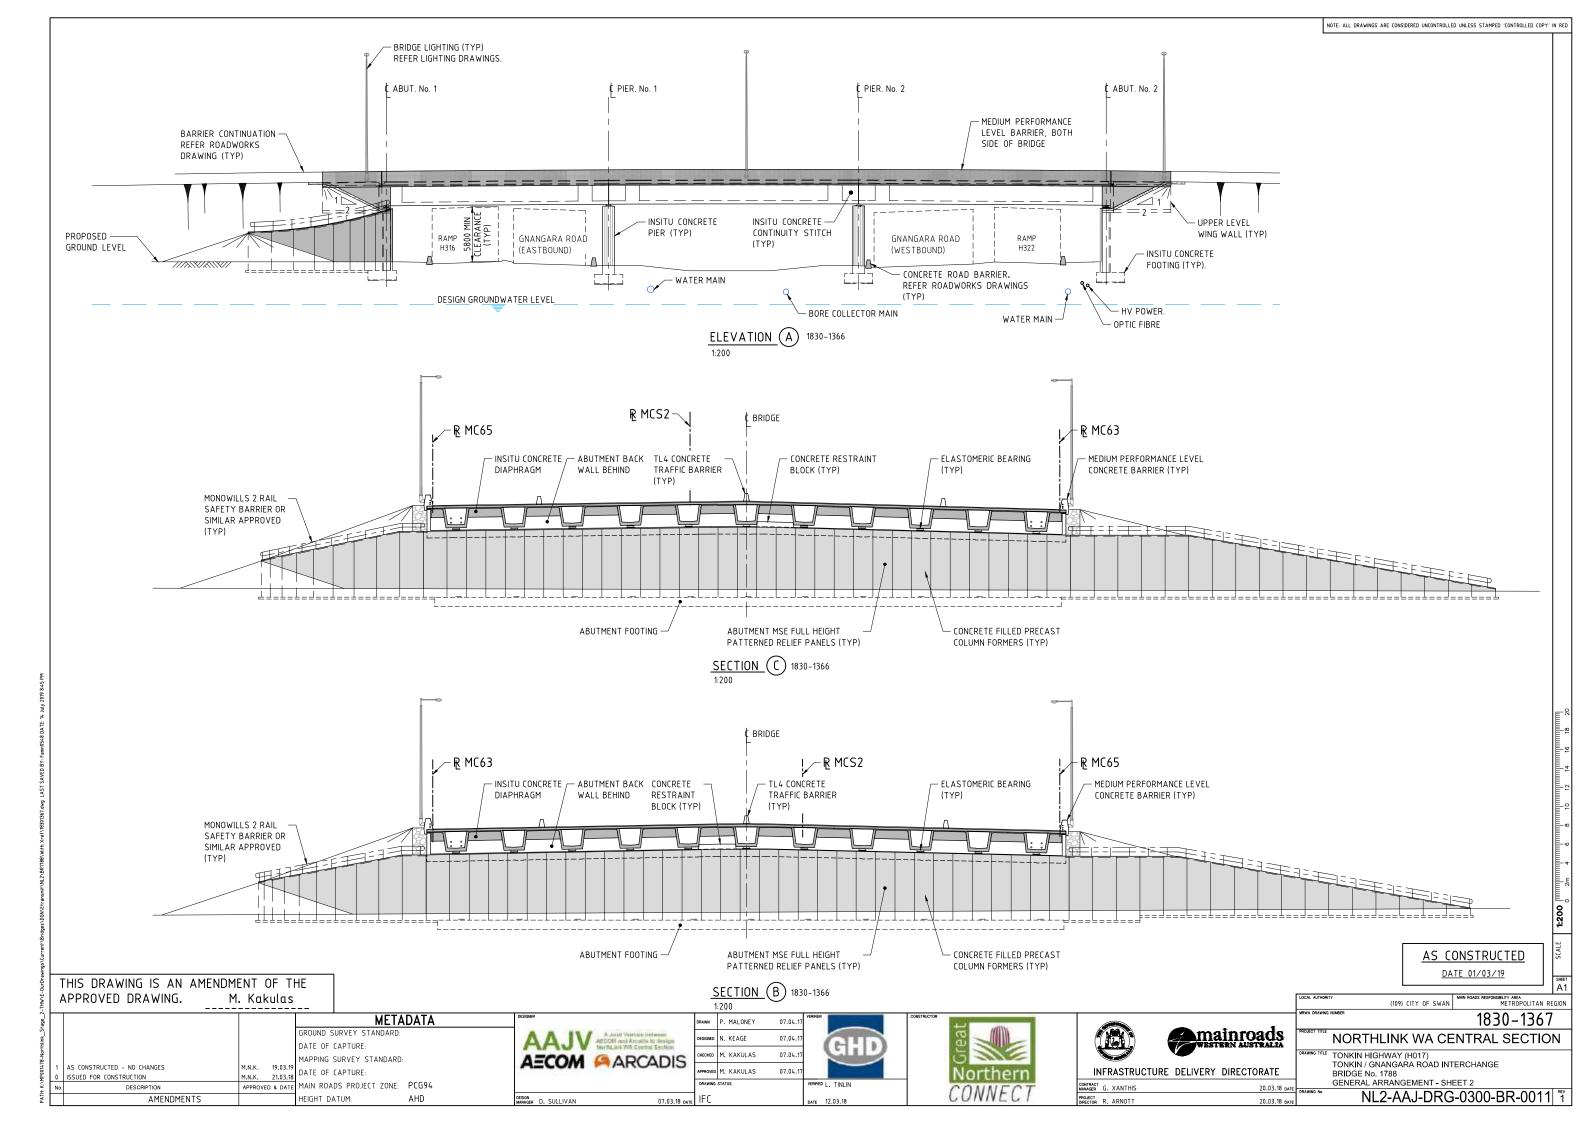
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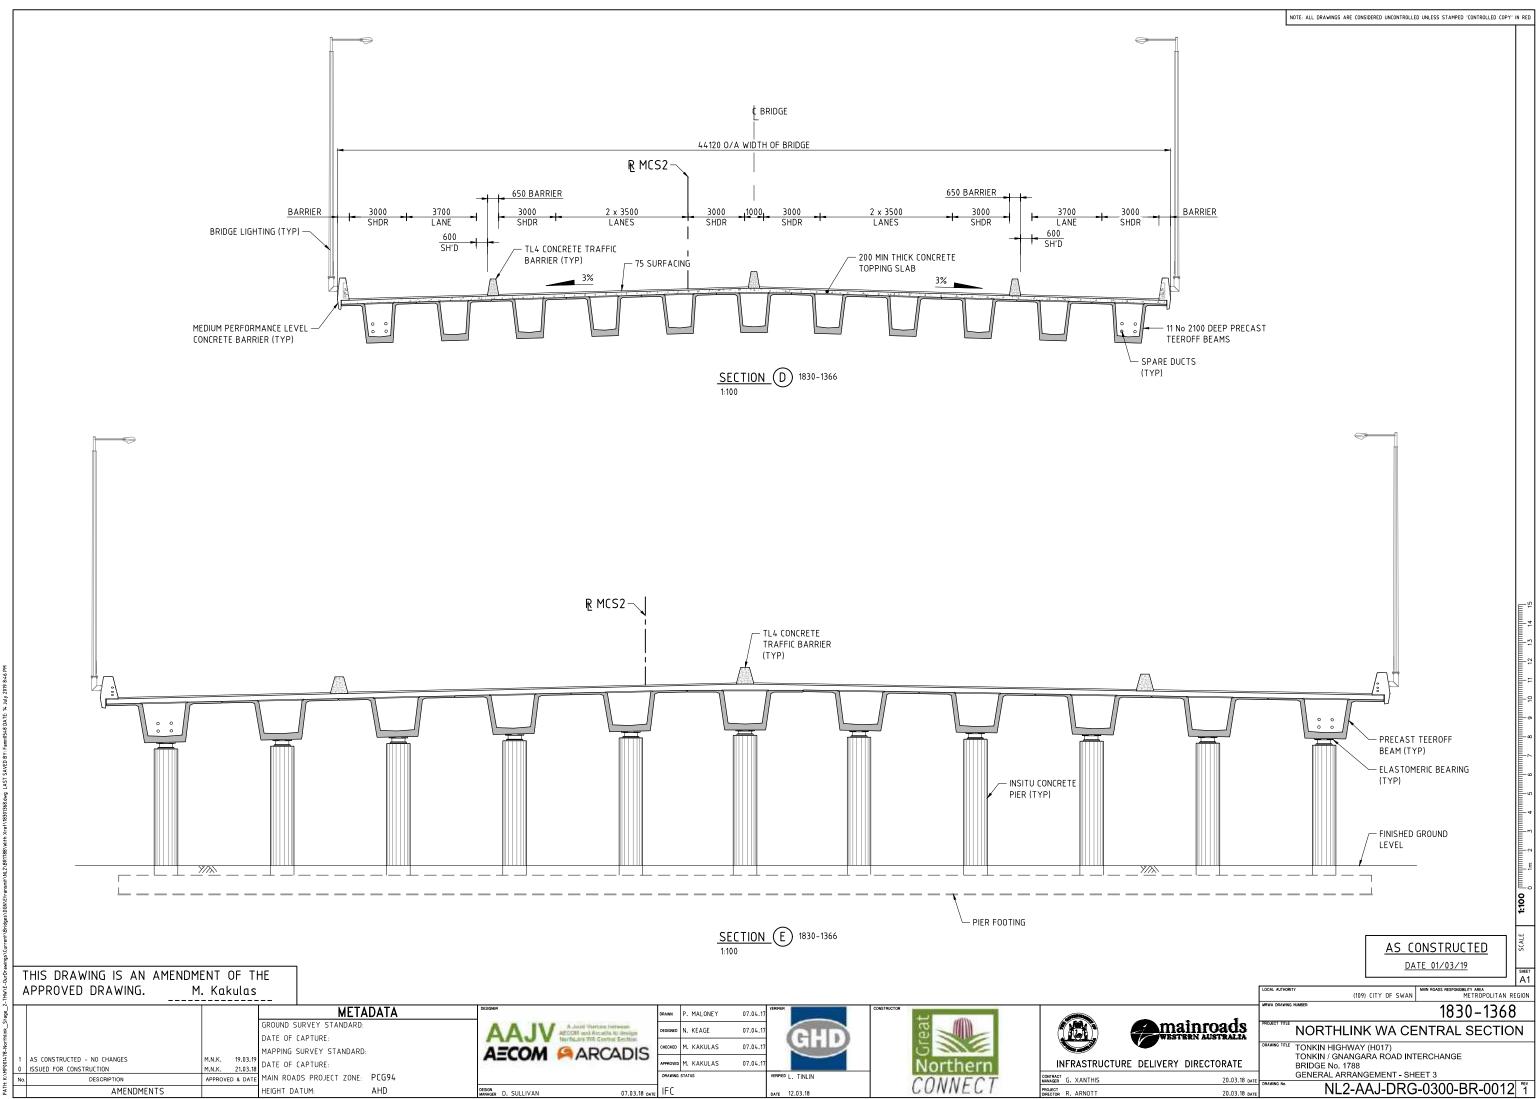
0530-1457-3 0630-1902

BRIDGE LIGHT POLE BASE - SHEET No. 2 BRIDGE MOUNTED LIGHT POLE DETAILS








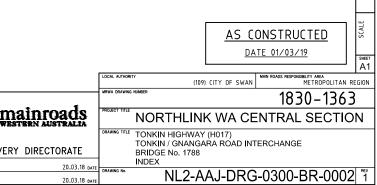


DRAWING INDEX			
DRAWING NUMBER GENERAL	<u>MRWA DRG No.</u>	DRAWING DESCRIPTION	
	1920 1/ (0		
NL2-AAJ-DRG-0330-BR-0001 NL2-AAJ-DRG-0330-BR-0002	1830-1469 1830-1470	LOCALITY PLAN INDEX	
ME2-WA3-DKG-0200-DK-0002	1050-1470	INDEX	
NL2-AAJ-DRG-0330-BR-0005	1830-1471	GENERAL NOTES – SHE	ET 1
NL2-AAJ-DRG-0330-BR-0006	1830-1472	GENERAL NOTES – SHE	ET 2
NL2-AAJ-DRG-0330-BR-0010	1830-1473	GENERAL ARRANGEMEN	NT – SHEET 1
NL2-AA J-DRG-0330-BR-0011	1830-1474	GENERAL ARRANGEMEN	NT – SHEET 2
NL2-AAJ-DRG-0330-BR-0015	1830-1475	BORE INFORMATION	
NL2-AAJ-DRG-0330-BR-0017	1830-1476	GEOMETRIC DATA	
SUBSTRUCTURE			
NL2-AA J-DRG-0330-BR-0020	1830-1477	ABUTMENT CONCRETE D	DETAILS – SHFFT 1
NL2-AAJ-DRG-0330-BR-0021	1830-1478	ABUTMENT CONCRETE D	
NL2-AAJ-DRG-0330-BR-0022	1830-1479	ABUTMENT CONCRETE D	
NL2-AAJ-DRG-0330-BR-0030	1830-1480	ABUTMENT REINFORCEM	1ENT DETAILS
NL2-AAJ-DRG-0330-BR-0035	1830-1481	PIER CONCRETE DETAIL	S
NL2-AAJ-DRG-0330-BR-0036	1830-1482	SCREW PILE LAYOUT	
NL2-AAJ-DRG-0330-BR-0037	1830-1483	SCREW PILE DETAILS	
NL2-AAJ-DRG-0330-BR-0038	1830-1484	PIER FOOTING REINFORC	MENT DETAILS
NL2-AAJ-DRG-0330-BR-0039	1830-1485	PIER COLUMN REINFORC	EMENT DETAILS
SUPERSTRUCTURE			
	4020 4/04		
NL2-AAJ-DRG-0330-BR-0045	1830-1486	BEARING DETAILS - SHI	
NL2-AAJ-DRG-0330-BR-0046	1830–1487	BEARING DETAILS – SHI	EET 2
NL2-AAJ-DRG-0330-BR-0050	1830-1488	PRECAST BEAM LAYOU	T & DETAILS - SHEET 1
NL2-AAJ-DRG-0330-BR-0051	1830-1489	PRECAST BEAM LAYOU	T & DETAILS - SHEET 2
NL2-AAJ-DRG-0330-BR-0052	1830-1490	PRECAST BEAM LAYOU	T & DETAILS - SHEET 3
NL2-AAJ-DRG-0330-BR-0053	1830-1491	PRECAST BEAM PREST	RESSING DETAILS - SHEET 1
NL2-AAJ-DRG-0330-BR-0054	1830-1492	PRECAST BEAM PREST	RESSING DETAILS - SHEET 2
NL2-AAJ-DRG-0330-BR-0060	1830-1493	PRECAST BEAM REINFO	RCEMENT DETAILS - SHEET 1
NL2-AAJ-DRG-0330-BR-0061	1830-1494		RCEMENT DETAILS - SHEET 2
NL2-AAJ-DRG-0330-BR-0062	1830-1495	PRECAST BEAM REINFO	RCEMENT DETAILS - SHEET 3
NL2-AA J-DRG-0330-BR-0063	1830-1496		ND REINFORCEMENT DETAILS
NL2-AAJ-DRG-0330-BR-0100	1830-1497	EXPANSION JOINT DETA	AILS
NL2-AAJ-DRG-0330-BR-0125	1830-1498	BALUSTRADE DETAILS	CHEET 1
NL2-AAJ-DRG-0330-BR-0135	1830-1499	LIGHT POLE TO BARRIEF	R CONNECTION DETAILS
MRWA STANDARD DRAWINGS			
	0630-1901	BRIDGE LIGHT POLE BAS	
	0630-1902	BRIDGE LIGHT POLE BAS	se – sheet 2
THIS DRAWING IS AN AMENDMENT APPROVED DRAWING. M. Ka	OF THE Ikulas		
		METADATA	DESIGNER
	GROUND SURVEY STAN		A A 11/
	DATE OF CAPTURE:		AAJV
AS CONSTRUCTED - NO CHANGES MNK	01.03.19 DATE OF CAPTURE:	NUAKU:	AECOM P
ISSUED FOR CONSTRUCTION MNK No. DESCRIPTION APPRO'	20.04.18 MAIN ROADS PROJECT	ZONE: PCG94	

DRAWINGS										
		0630-1901	BRIDGE LIGHT POLE B	ASE – SHEET 1						
		0630-1902	BRIDGE LIGHT POLE B	ASE – SHEET 2						
WING IS AN AMENDME D DRAWING. M.	ENT OF TH . Kakulas									
D - NO CHANGES	MNK 01 03 19	GROUND SURVEY STAN DATE OF CAPTURE: MAPPING SURVEY STAN		ADDER ADJV ADDER VARIAN SE		 J. NGUI S. SERGEEV 	20.10.17 20.10.17 20.10.17	HD	Creat	
STRUCTION	MNK 20.04.18	DATE OF CAPTURE: MAIN ROADS PROJECT	ZONE: PCG94		APPROV	ED M. KAKULAS NG STATUS	20.10.17 VERIFIED G. JOY	(NSON	Northern	INFRASTRUCTURE DELIVERY
AMENDMENTS		HEIGHT DATUM:	AHD	DESIGN MANAGER D. SULLIVAN 23	3.03.18 date IFC		DATE 27.03.1	18	CONNECT	PROJECT DIRECTOR R. ARNOTT

mainroads	LOCAL AUTHORITY (109) CITY OF SWAN MAN ROADS REPONSENT AREA MAN ROADS REPONSENT AREA METROPOLITAN REG MINA DRAWING INLE NORTHLINK WA CENTRAL SECTION DRAWING INTLE TONKIN HIGHWAY (H017)	
VERY DIRECTORATE 17.04.18 date 17.04.18 date	TONKIN / GNANGARA INTERCHANGE PEDESTRIAN FOOTBRIDGE No. 9426 INDEX	REV 1

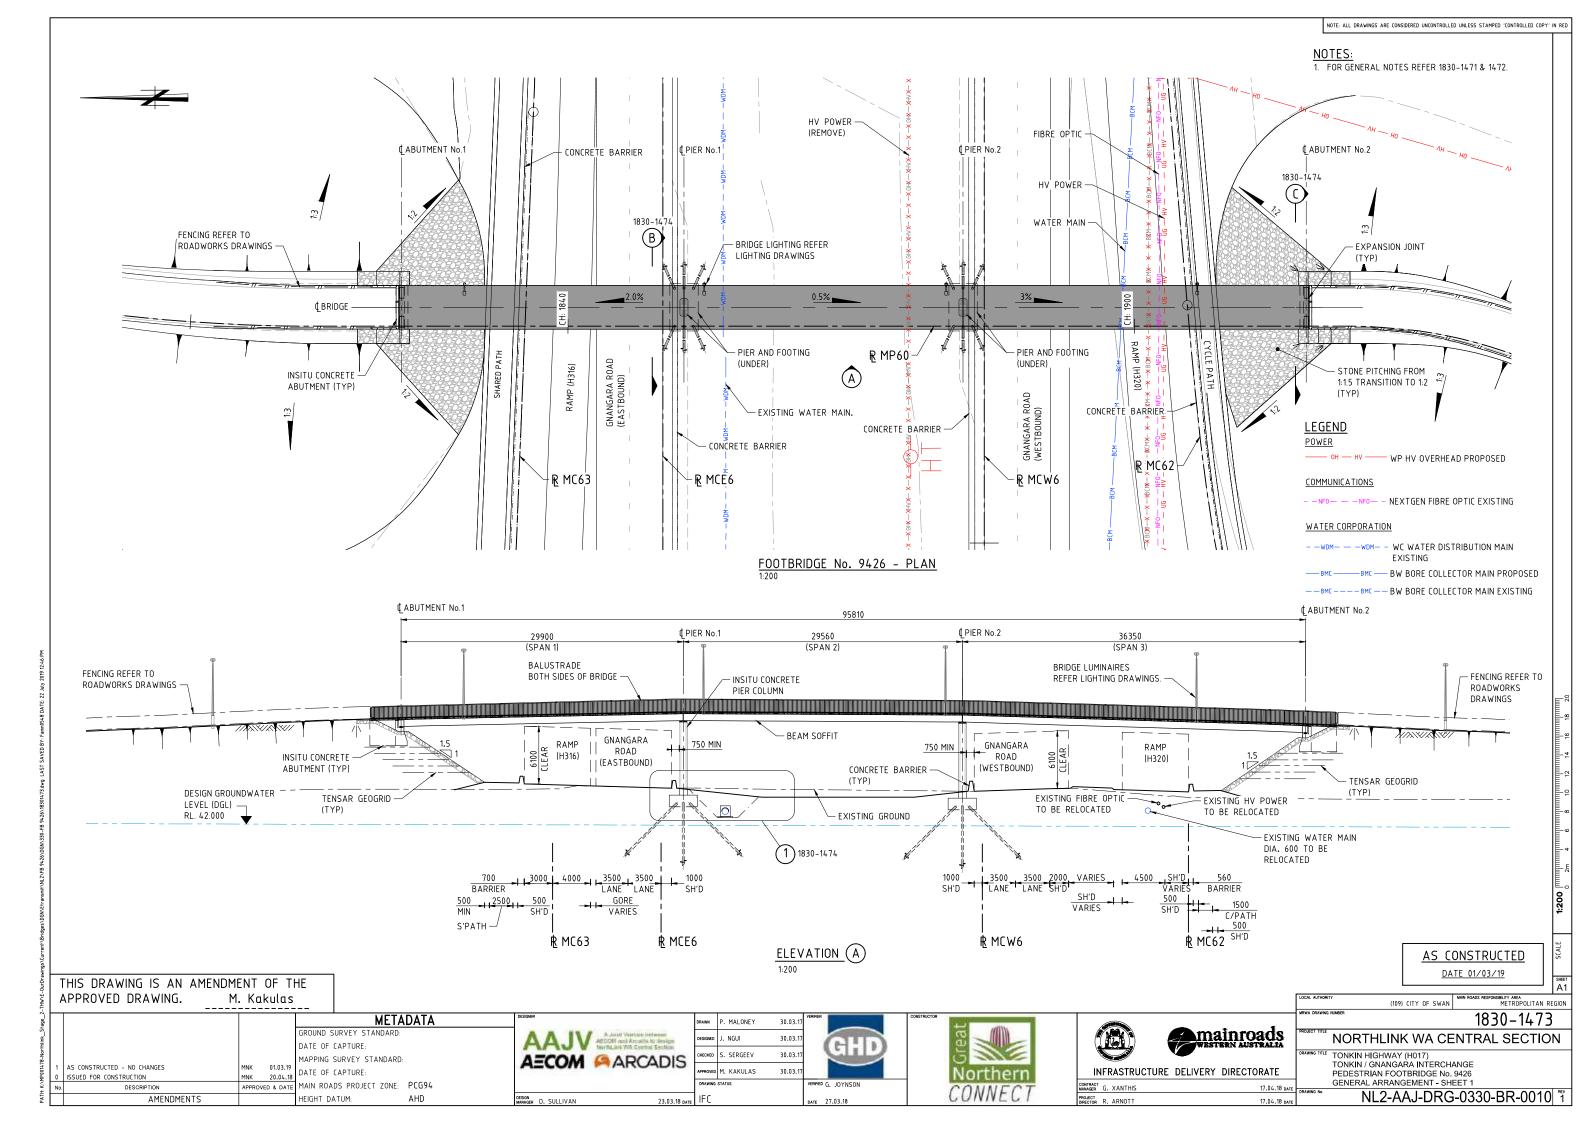

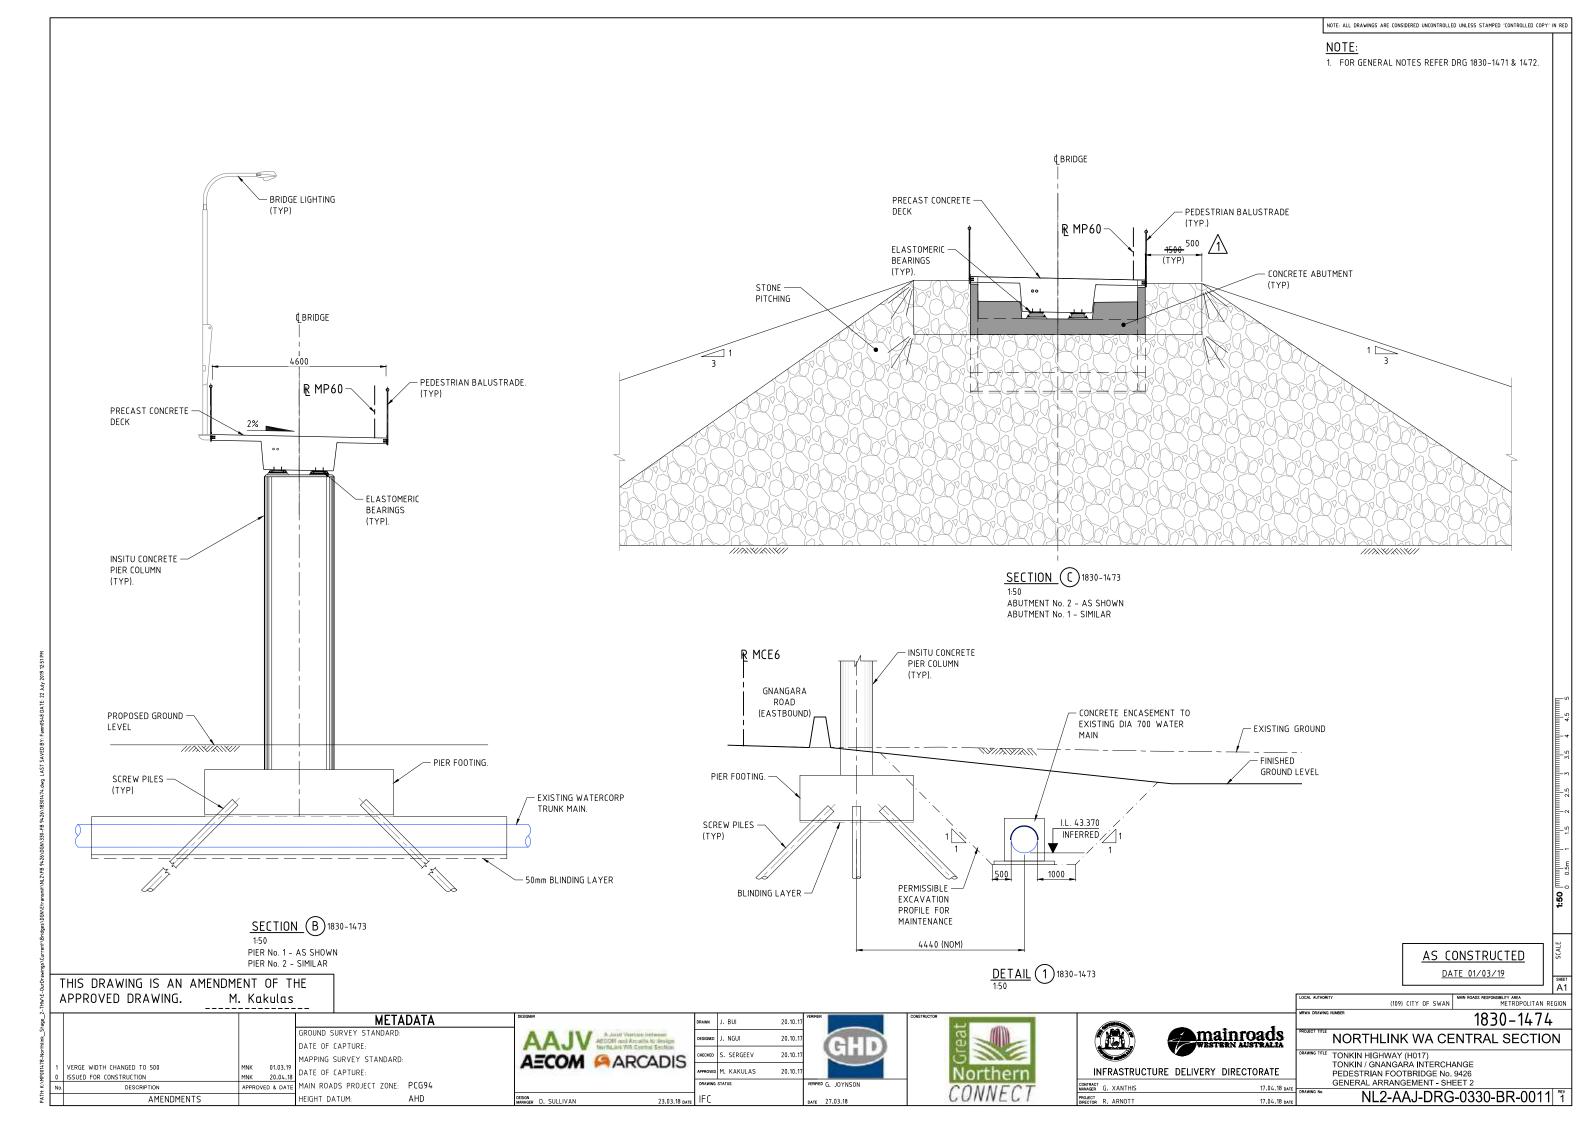

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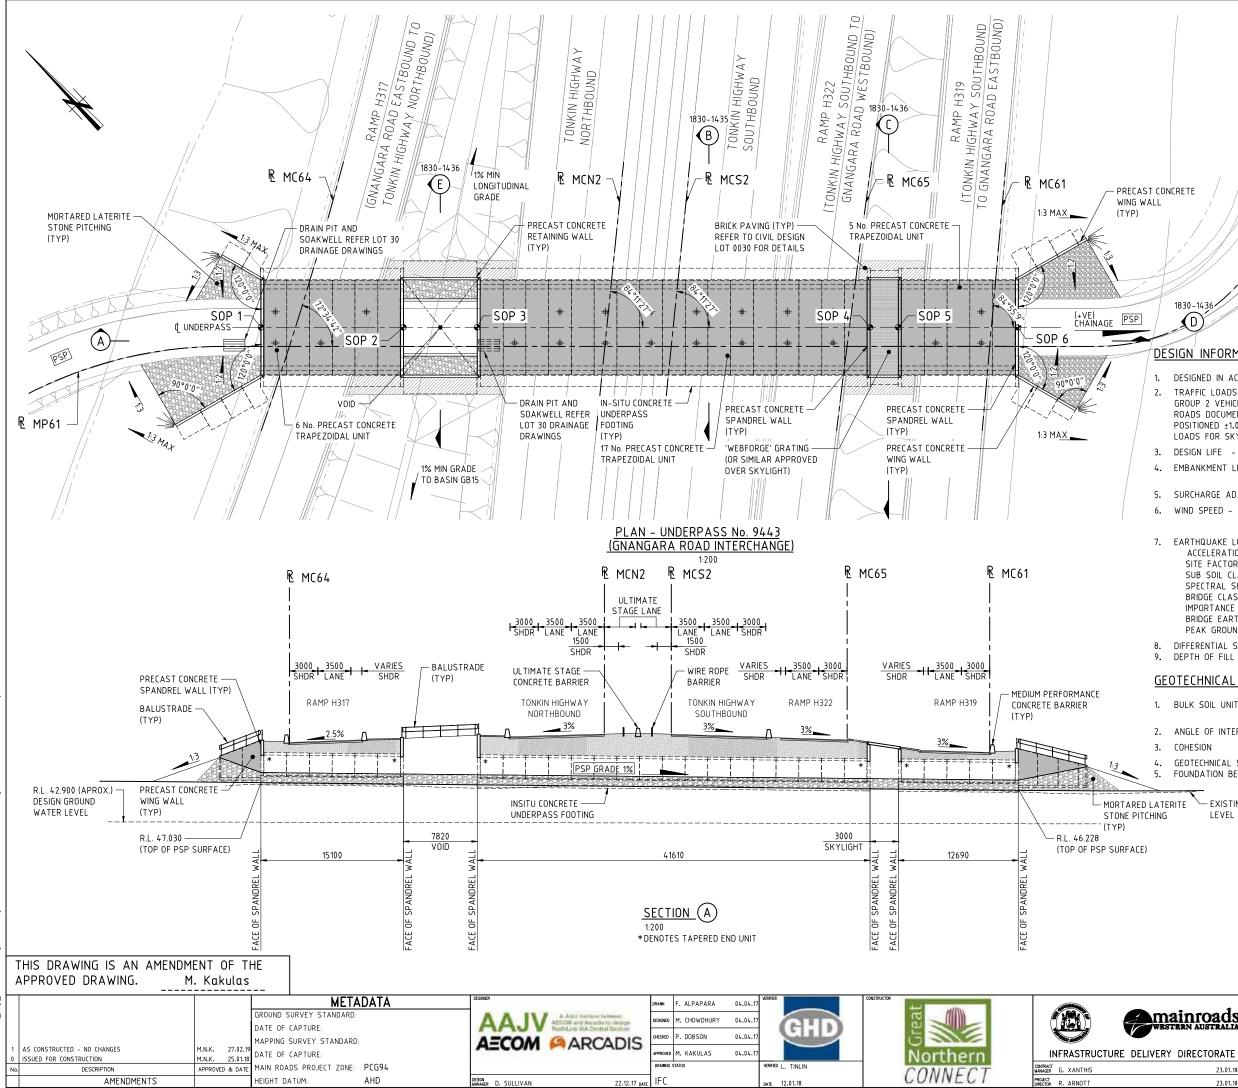
DRAWING NUMBER	MRWA DRG No.	DRAWING DESCRIPTION	DRAWING NUMBER	MRWA DRG No.	DRAWING DESCRIPTION
NL2-AAJ-DRG-0310-UP-0001	1830-1431	LOCALITY PLAN	NL2-AAJ-DRG-0310-UP-0060	1830-1452	SKYLIGHT DETAIL
NL2-AAJ-DRG-0310-UP-0002	1830-1432	INDEX			
			NL2-AAJ-DRG-0310-UP-0065	1830-1453	RETAINING WALL LAYOUT
NL2-AAJ-DRG-0310-UP-0005	1830-1433	GENERAL NOTES	NL2-AAJ-DRG-0310-UP-0066	1830-1454	RETAINING WALL CONCRETE DETAILS - SHEET 1
			NL2-AAJ-DRG-0310-UP-0067	1830-1455	RETAINING WALL CONCRETE DETAILS - SHEET 2
NL2-AAJ-DRG-0310-UP-0010	1830-1434	GENERAL ARRANGEMENT - SHEET 1			
NL2-AAJ-DRG-0310-UP-0011	1830-1435	GENERAL ARRANGEMENT - SHEET 2	NL2-AAJ-DRG-0310-UP-0070	1830-1456	RETAINING WALL REINFORCEMENT DETAILS - SHEET 1
NL2-AAJ-DRG-0310-UP-0012	1830-1436	GENERAL ARRANGEMENT - SHEET 3	NL2-AAJ-DRG-0310-UP-0071	1830-1457	RETAINING WALL REINFORCEMENT DETAILS - SHEET 2
NL2-AAJ-DRG-0310-UP-0013	1830-1437	BOREHOLE DATA	NL2-AAJ-DRG-0310-UP-0074	1830-1458	WING WALL LAYOUT
NL2-AAJ-DRG-0310-UP-0015	1830-1438	FOOTING CONCRETE DETAILS	NL2-AAJ-DRG-0310-UP-0075	1830-1459	WING WALL CONCRETE DETAILS – SHEET 1
			NL2-AAJ-DRG-0310-UP-0076	1830-1460	WING WALL CONCRETE DETAILS - SHEET 2
NL2-AAJ-DRG-0310-UP-0020	1830-1439	FOOTING REINFORCEMENT DETAILS	NL2-AAJ-DRG-0310-UP-0077	1830-1461	WING WALL CONCRETE DETAILS - SHEET 3
NL2-AAJ-DRG-0310-UP-0025	1830-1440	TRAPEZOIDAL UNIT LAYOUT AND DETAILS	NL2-AAJ-DRG-0310-UP-0080	1830-1462	WING WALL REINFORCEMENT DETAILS - SHEET 1
			NL2-AAJ-DRG-0310-UP-0081	1830-1463	WING WALL REINFORCEMENT DETAILS - SHEET 2
NL2-AAJ-DRG-0310-UP-0030	1830-1441	TRAPEZOIDAL UNIT CONCRETE DETAILS – SHEET 1			
NL2-AAJ-DRG-0310-UP-0031	1830-1442	TRAPEZOIDAL UNIT CONCRETE DETAILS - SHEET 2	NL2-AAJ-DRG-0310-UP-0090	1830-1464	LUMINAIRE DETAILS
NL2-AAJ-DRG-0310-UP-0035	1830-1443	TRAPEZOIDAL UNIT REINFORCEMENT DETAILS - SHEET 1	NL2-AAJ-DRG-0310-UP-0100	1830-1465	DESIGN SUMMARY - SHEET 1
NL2-AAJ-DRG-0310-UP-0036	1830-1444	TRAPEZOIDAL UNIT REINFORCEMENT DETAILS - SHEET 2	NL2-AAJ-DRG-0310-UP-0101	1830-1466	DESIGN SUMMARY - SHEET 2
NL2-AAJ-DRG-0310-UP-0040	1830-1445	SPANDREL WALL LAYOUT - SHEET 1			
NL2-AAJ-DRG-0310-UP-0041	1830-1446	SPANDREL WALL LAYOUT - SHEET 2			
NL2-AAJ-DRG-0310-UP-0045	1830-1447	SPANDREL WALL CONCRETE DETAILS - SHEET 1			
NL2-AAJ-DRG-0310-UP-0046	1830-1448	SPANDREL WALL CONCRETE DETAILS - SHEET 2			
NL2-AAJ-DRG-0310-UP-0050	1830-1449	SPANDREL INSTALLATION BRACKET DETAILS			
NL2-AAJ-DRG-0310-UP-0055	1830-1450	SPANDREL WALL REINFORCEMENT DETAILS - SHEET 1			
NL2-AAJ-DRG-0310-UP-0056	1830-1451	SPANDREL WALL REINFORCEMENT DETAILS - SHEET 2			

	THIS DRAWING IS AN AMENDMI APPROVED DRAWING. M	ENT OF TI . Kakulas									
	1 AS CONSTRUCTED - NO CHANGES 0 ISSUED FOR CONSTRUCTION		GROUND SURVEY STANDARD DATE OF CAPTURE: MAPPING SURVEY STANDARE		AAJV Addr Verdere Tehnerer ACOM and Angeler to Design ACOM ACCAD	DRAMM F. ALPAPARA DESIMED M. CHOWDHURY CHECKED P. DOBSON APPROVED M. KAKULAS	01.09.17 01.09.17 01.09.17 01.09.17	GHD	Northern	INFRASTRUCTURE	
١		APPROVED & DATE	MAIN ROADS PROJECT ZONE: HEIGHT DATUM:	PCG94 AHD	DESIGN MMAAGER D. SULLIVAN 22.12	DRAWING STATUS 17 date IFC		VERIFIED L. TINLIN DATE 12.01.18	CONNECT	CONTRACT MANAGER G. XANTHIS PROJECT DIRECTOR R. ARNOTT	

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			HEET
	LOCAL AUTHORITY	aty (109) CITY OF SWAN MAN ROADS RESPONSIBILITY ARA METROPOLITAN REG NINBER 1830-1432	41
MESTERN AUSTRALIA	PROJECT TITLE	NORTHLINK WA CENTRAL SECTION	
23.01.18 DATE	DRAWING No.	INDEX	^{rev}

NOTE: ALL DRAWINGS ARE CONSIDERED UNCONTROLLED UNLESS STAMPED 'CONTROLLED COPY' IN RED



	NOTE: ALL DRAWINGS ARE CONSIDER	ED UNCONTROLLED UNLESS STAMPED 'CONTROLLED COPY'	' IN RED
	NOTES:		T
		TES REFER DRG 1830-1433.	
	INSIDE UNDERPAS	SATTER GRADE TO BE 1:2 S AND EXTEND 2.0m FROM THEN TRANSITION TO 1:3 SLOPE WALLS.	
		SHALL BE IN ACCORDANCE WITH 6 - ROCK PROTECTION.	
	4. FOR SETOUT POIN	ITS TABLE REFER DRG 1830-1438	;.
1830-1436			
DESIGN INFORMATIC	ON SUMMARY:		
		'BRIDGE DESIGN CODE' UNO.	
 TRAFFIC LOADS - 100 GROUP 2 VEHICLE 5 F ROADS DOCUMENT 391 	% SM1600, HLP400 AND HEAVY LOAD PLATFORM V 12/02-2 . HLP AND GROUP M THE CENTERLINE OF CA	GROUP 2 VEHICLE 4 AND 'EHICLES DETAILED IN MAIN	
3. DESIGN LIFE -		100YRS.	
4. EMBANKMENT LIVE LO	AD	2.5kPa. (STEEPER THAN 1:4) 5.0kPa. (ELSEWHERE)	
	T TO SPANDREL WALL	10kPa.	
	JLS V2000 SLS V20	48m∕s 37m∕s.	
 EARTHQUAKE LOADING ACCELERATION COE SITE FACTOR, S SUB SOIL CLASS SPECTRAL SHAPE I BRIDGE CLASSIFICA IMPORTANCE FACTO BRIDGE EARTHQUAF PEAK GROUND ACCI DIFFERENTIAL SETTLEI 	FFICIENT,Z FACTOR Ch (T) TION DR KE DESIGN CATEGORY ELERATION (PGA)	0.09 1.25 Ce 3.68 (1.3) TYPE 2 1.0 BEDC-2 0.2g 20mm.	
9. DEPTH OF FILL OVER	STRUCTURE VARIES	805mm MIN, 2450mm MAX	
<u>GEOTECHNICAL SUM</u>	<u>IMARY</u>		
1. BULK SOIL UNIT WEIGI		18kN∕m³ (DRY) 20kN∕m³ (SATURATED)	
 ANGLE OF INTERNAL F COHESION 	RICTION	36° NIL	
	GTH REDUCTION FACTOR	0.50	
5. FOUNDATION BEARING		400kPa (ULS)	
ATERITE EXISTING GRO ING LEVEL	UND		1:200 mmmmmmmmmmmmmmmm
	Г		CALE 1:

AS CONSTRUCTED DATE 01/03/19

SHEET A1


LOCAL AUTHOR IBILITY AREA METROPOLITAN REGION (109) CITY OF SWAN 1830-1434 NORTHLINK WA CENTRAL SECTION TONKIN HIGHWAY (H017) TONKIN / GNANGARA ROAD INTERCHANGE

Mainroads


23.01.18 DAT 23.01.18 D/

UNDERPASS No. 9443 GENERAL ARRANGEMENT - SHEET 1

NL2-AAJ-DRG-0310-UP-0010

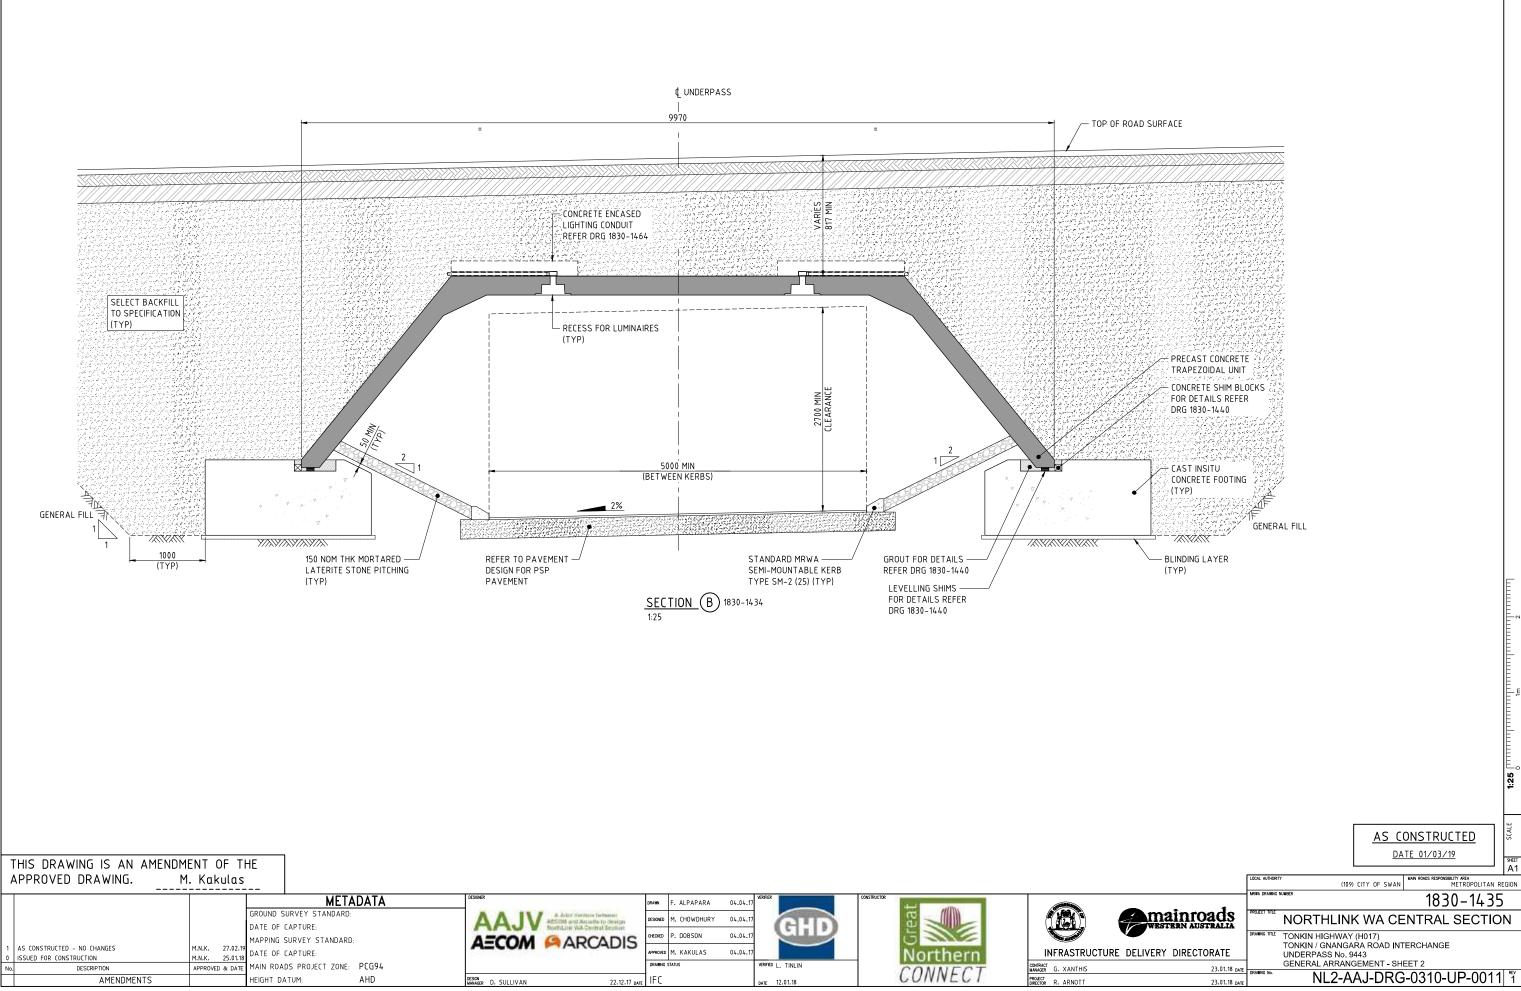

	NOTE: ALL DRAWINGS ARE CONSIDERED UNCONTROLLED UNLESS STAMPED 'CONTROLLED COPY' IN REC
	NOTES:
	1. FOR GENERAL NOTES REFER DRG 1830-1433.
:	2. THIS DRAWING TO BE READ IN CONJUNCTION WITH DRG 1830-1434.

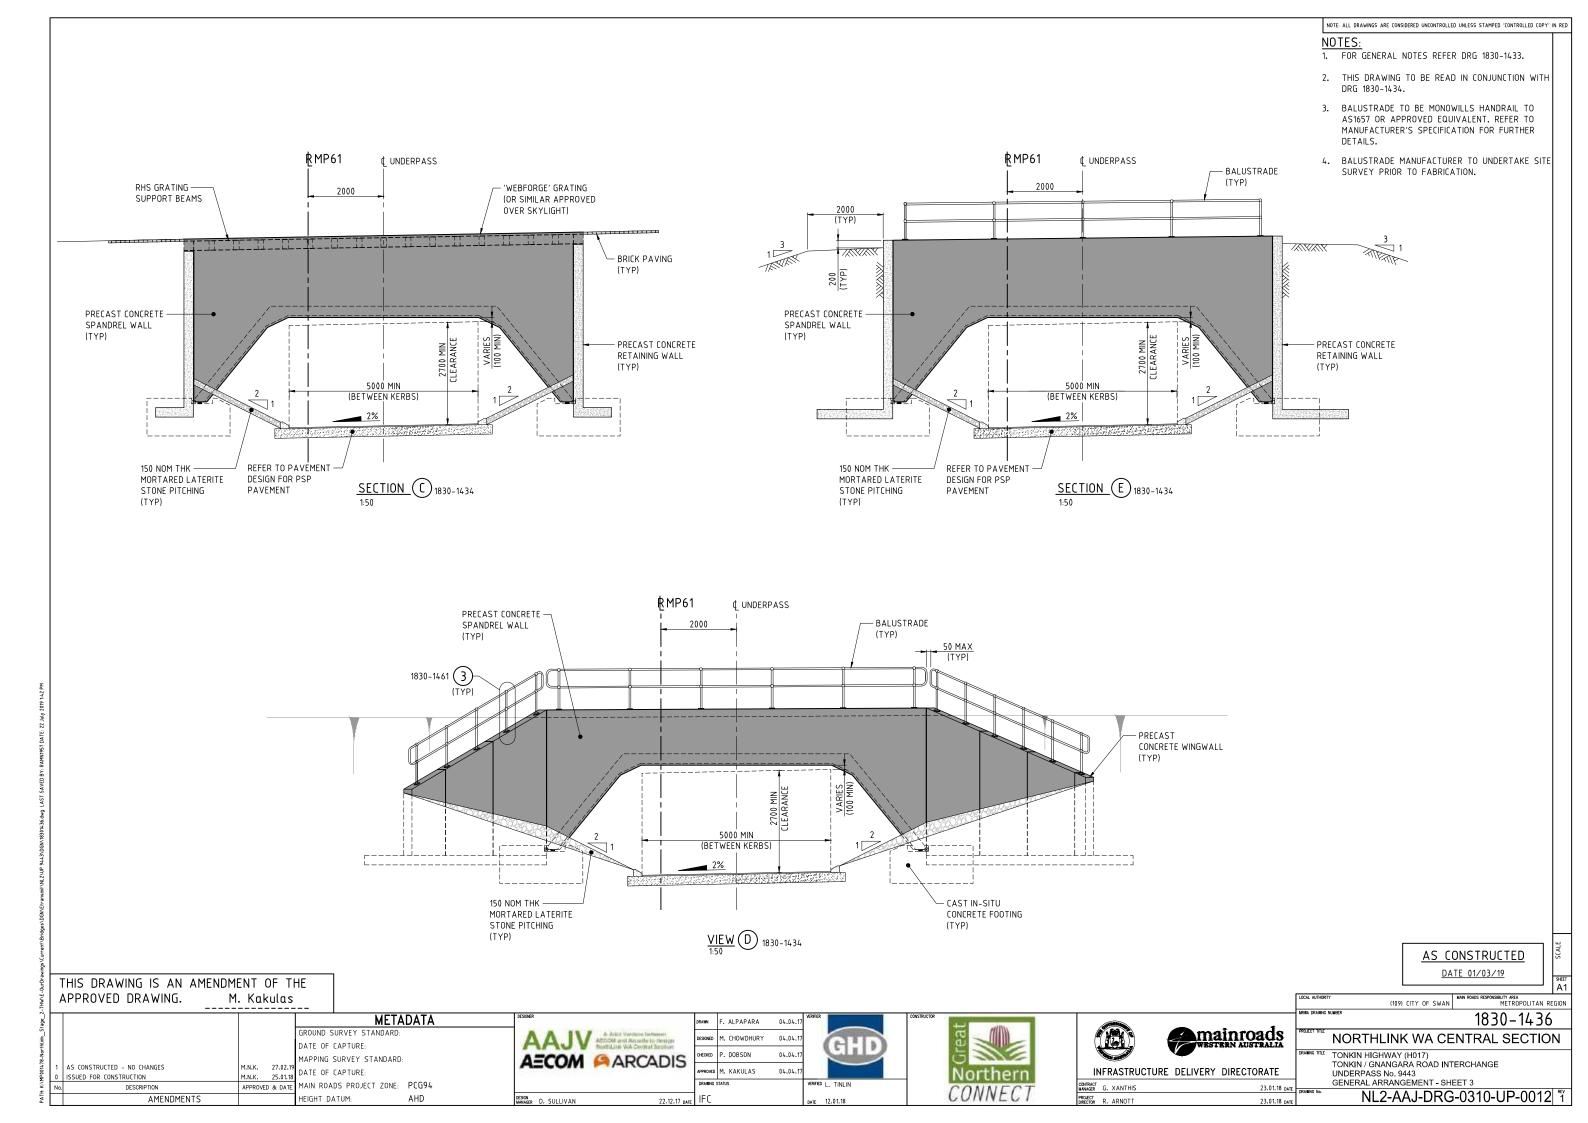

DRAWING INDEX					
PROJECT DRG No.	MRWA DRG No.	DRAWING DESCRIPTION	PROJECT DRG No.	MRWA DRG No.	DRAWING DESCRIPTION
GENERAL			NL2-AAJ-DRG-0400-BR-0073	1830-1532	DECK REINFORCEMENT DETAILS - SHEET 1
NL2-AAJ-DRG-0400-BR-0001	1830-1502	LOCALITY PLAN	NL2-AAJ-DRG-0400-BR-0074	1830-1533	DECK REINFORCEMENT DETAILS - SHEET 2
NL2-AAJ-DRG-0400-BR-0002	1830-1503	INDEX			
			NL2-AAJ-DRG-0400-BR-0090	1830-1534	APPROACH SLAB CONCRETE DETAILS
NL2-AAJ-DRG-0400-BR-0005	1830-1504	GENERAL NOTES – SHEET 1	NL2-AAJ-DRG-0400-BR-0091	1830-1535	APPROACH SLAB REINFORCEMENT DETAILS
NL2-AAJ-DRG-0400-BR-0006	1830-1505	GENERAL NOTES - SHEET 2		40-20 45-24	
			NL2-AAJ-DRG-0400-BR-0100	1830-1536	EXPANSION JOINT DETAILS
NL2-AAJ-DRG-0400-BR-0010	1830-1506	GENERAL ARRANGEMENT - SHEET 1	NL2-AAJ-DRG-0400-BR-0105	1830-1537	COVER PLATE DETAILS
NL2-AAJ-DRG-0400-BR-0011	1830-1507	GENERAL ARRANGEMENT - SHEET 2		1050 1557	
NL2-AAJ-DRG-0400-BR-0012	1830-1508	GENERAL ARRANGEMENT - SHEET 3	NL2-AAJ-DRG-0400-BR-0110	1830-1538	BARRIER LAYOUT
			NL2-AAJ-DRG-0400-BR-0111	1830-1539	BARRIER DETAILS – SHEET 1
SUBSTRUCTURES			NL2-AAJ-DRG-0400-BR-0112	1830-1540	BARRIER DETAILS – SHEET 2
NL2-AAJ-DRG-0400-BR-0015	1830-1509	BORE INFORMATION – SHEET 1			
NL2-AAJ-DRG-0400-BR-0016	1830-1510	BORE INFORMATION - SHEET 2	NL2-AAJ-DRG-0400-BR-0115	1830-1541	PRECAST CONCRETE PARAPET DETAILS – SHEET 1
NL2-AAJ-DRG-0400-BR-0017	1830-1511	GEOMETRIC DATA	NL2-AAJ-DRG-0400-BR-0116	1830-1542	PRECAST CONCRETE PARAPET DETAILS - SHEET 2
NL2-AAJ-DRG-0400-BR-0020	1830-1512	ABUTMENT – MSE WALL LAYOUT	NL2-AAJ-DRG-0400-BR-0135	1830-1543	LIGHTING AND ELECTRICAL LAYOUT
NL2-AAJ-DRG-0400-BR-0021	1830-1513	ABUTMENT No. 1 - MSE WALL	NL2-AAJ-DRG-0400-BR-0136	1830-1544	UNDER BRIDGE LIGHTING DETAILS
NL2-AAJ-DRG-0400-BR-0022	1830-1514	ABUTMENT No. 2 - MSE WALL	NL2-AAJ-DRG-0400-BR-0137	1830-1545	LUMINAIRE BRACKET DETAILS
NL2-AAJ-DRG-0400-BR-0023	1830-1515	ABUTMENT – MSE WALL – TYPICAL SECTIONS			
NL2-AAJ-DRG-0400-BR-0024	1830-1516	COLUMN FORMER DETAILS	NL2-AAJ-DRG-0400-BR-0155	1830-1546	DESIGN SUMMARY - SHEET 1
NL2-AAJ-DRG-0400-BR-0025	1830-1517	ABUTMENT No. 1 - CONCRETE DETAILS	NL2-AAJ-DRG-0400-BR-0156	1830-1547	DESIGN SUMMARY – SHEET 2
NL2-AAJ-DRG-0400-BR-0026	1830-1518	ABUTMENT No. 2 - CONCRETE DETAILS			
NL2-AAJ-DRG-0400-BR-0027	1830-1519	ABUTMENT - CONCRETE DETAILS	MRWA STANDARD DRAWINGS		
NL2-AAJ-DRG-0400-BR-0030	1830-1520	ABUTMENT – REINFORCEMENT DETAILS – SHEET 1	-	0430-0760	REGULAR PERFORMANCE LEVEL BARRIER - RAIL ELEVATION & DETAILS
NL2-AAJ-DRG-0400-BR-0031	1830-1521	ABUTMENT - REINFORCEMENT DETAILS - SHEET 2	-	0430-0761-1	REGULAR PERFORMANCE LEVEL BARRIER - TRANSITION RAIL ELEVATION
	4030 4500		_	0430-0761-2	REGULAR PERFORMANCE LEVEL BARRIER – GUARDRAIL POST DETAILS
NL2-AAJ-DRG-0400-BR-0033	1830-1522	COLUMN REINFORCEMENT DETAILS	-	0430-0763	REGULAR PERFORMANCE LEVEL BARRIER - FIXED SPLICE ASSEMBLY DE
SUPERSTRUCTURE			-	0430-0764-1	REGULAR PERFORMANCE LEVEL BARRIER – EXPANSION SPLICE ASSEMBI
	40.20 45.2.2		_	0430-0765-2	REGULAR PERFORMANCE LEVEL BARRIER - TWO RAIL BARRIER TRANSIT
NL2-AAJ-DRG-0400-BR-0045	1830-1523	BEARING DETAILS	_	0430-0766-2	REGULAR PERFORMANCE LEVEL BARRIER - THREE & FOUR RAIL BARRIER
NL2-AAJ-DRG-0400-BR-0050	1830-1524	PRECAST TEEROFF BEAM LAYOUT	_	0430-0767	REGULAR PERFORMANCE LEVEL BARRIER - TOP RAIL DETAILS
	1050 1524			0430-1213-1	REGULAR PERFORMANCE LEVEL BARRIER - INSTALLATION DETAILS
NL2-AAJ-DRG-0400-BR-0052	1830-1525	PRECAST TEEROFF BEAM - TYPICAL DETAILS	-		
NL2-AAJ-DRG-0400-BR-0053	1830-1526	PRECAST TEEROFF BEAM - CONCRETE DETAILS	-	0430-1314	PRECAST PARAPET PANELS
			-	9331-0376-3	KERB TYPES
NL2-AAJ-DRG-0400-BR-0057	1830-1527	PRECAST TEEROFF - PRESTRESSING DETAILS			
NL2-AAJ-DRG-0400-BR-0060	1830-1528	PRECAST TEEROFF - REINFORCEMENT DETAILS - SHEET 1			
NL2-AAJ-DRG-0400-BR-0061	1830-1529	PRECAST TEEROFF - REINFORCEMENT DETAILS - SHEET 2			

NL2-AAJ-DRG-0400-BR-0070 1830-1530 DECK CONCRETE DETAILS - SHEET 1 NL2-AAJ-DRG-0400-BR-0071 1830-1531 DECK CONCRETE DETAILS - SHEET 2

HEIGHT DATUM:

AMENDMENTS

AHD

THIS DRAWING IS AN AMENDMENT OF THE APPROVED DRAWING. M. Kakulas METADATA DRAWN F. ALPAPARA 09.02.17 AAJV A Autor Variation in termine ACCOM and Accord to the second AECOM ACADIS GROUND SURVEY STANDARD SNED X. LAM 09.02.17 Crea GHD DATE OF CAPTURE: 09.02.17 CHECKED S. SERGEEV MAPPING SURVEY STANDARD: MAPPING SURVEY S M.N.K. 27.02.19 M.N.K. 10.01.18 DATE OF CAPTURE: AS CONSTRUCTED - NO CHANGES ED M. KAKULAS 09.02.17 Northern INFRASTRUCTURE DELIVE ISSUED FOR CONSTRUCTION APPROVED & DATE MAIN ROADS PROJECT ZONE: PCG94 WING STATUS FIFIED G. JOYNSON CONTRACT MANAGER G. XANTHIS PROJECT DIRECTOR R. ARNOTT CONNEC DESCRIPTION


DESIGN MANAGER D. SULLIVAN


01.12.17 date IFC


DATE 08.12.17

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	AS CONSTRUCTED DATE 22/01/19	SCALE
	LOCAL AUTHORITY (109) CITY OF SWAN METROPOLITAN REA	SHEET A1 GION
	MRWA DRAWING NUMBER 1830 – 1503	
mainroads	MORTHLINK WA CENTRAL SECTIO	
ERY DIRECTORATE	DRAWING TITLE TONKIN HIGHWAY (H017) THE PROMENADE INTERCHANGE BRIDGE No. 1789	
12.12.17 date	INDEX DRAWNG No. NL2-AAJ-DRG-0400-BR-0002	REV 1
12.12.17 date		· ·]

TAILS VATIONS AILS BLY DETAILS SSEMBLY DETAILS RANSITION ARRIER TRANSITION

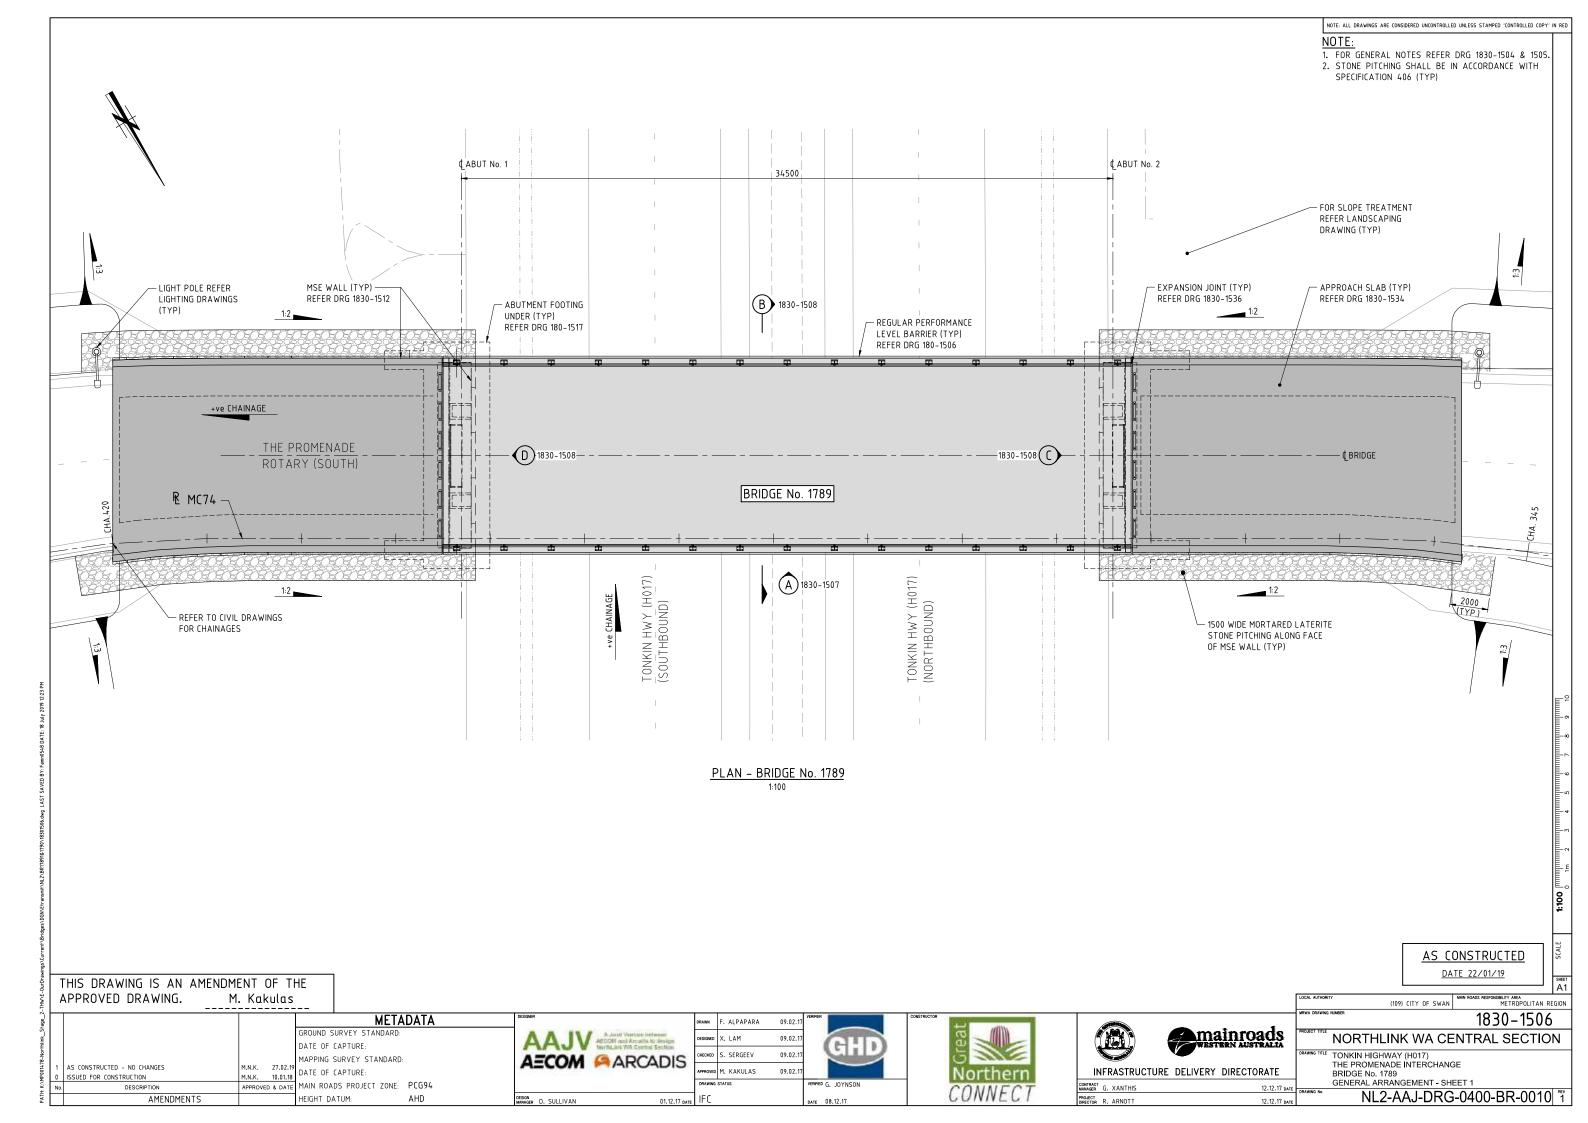

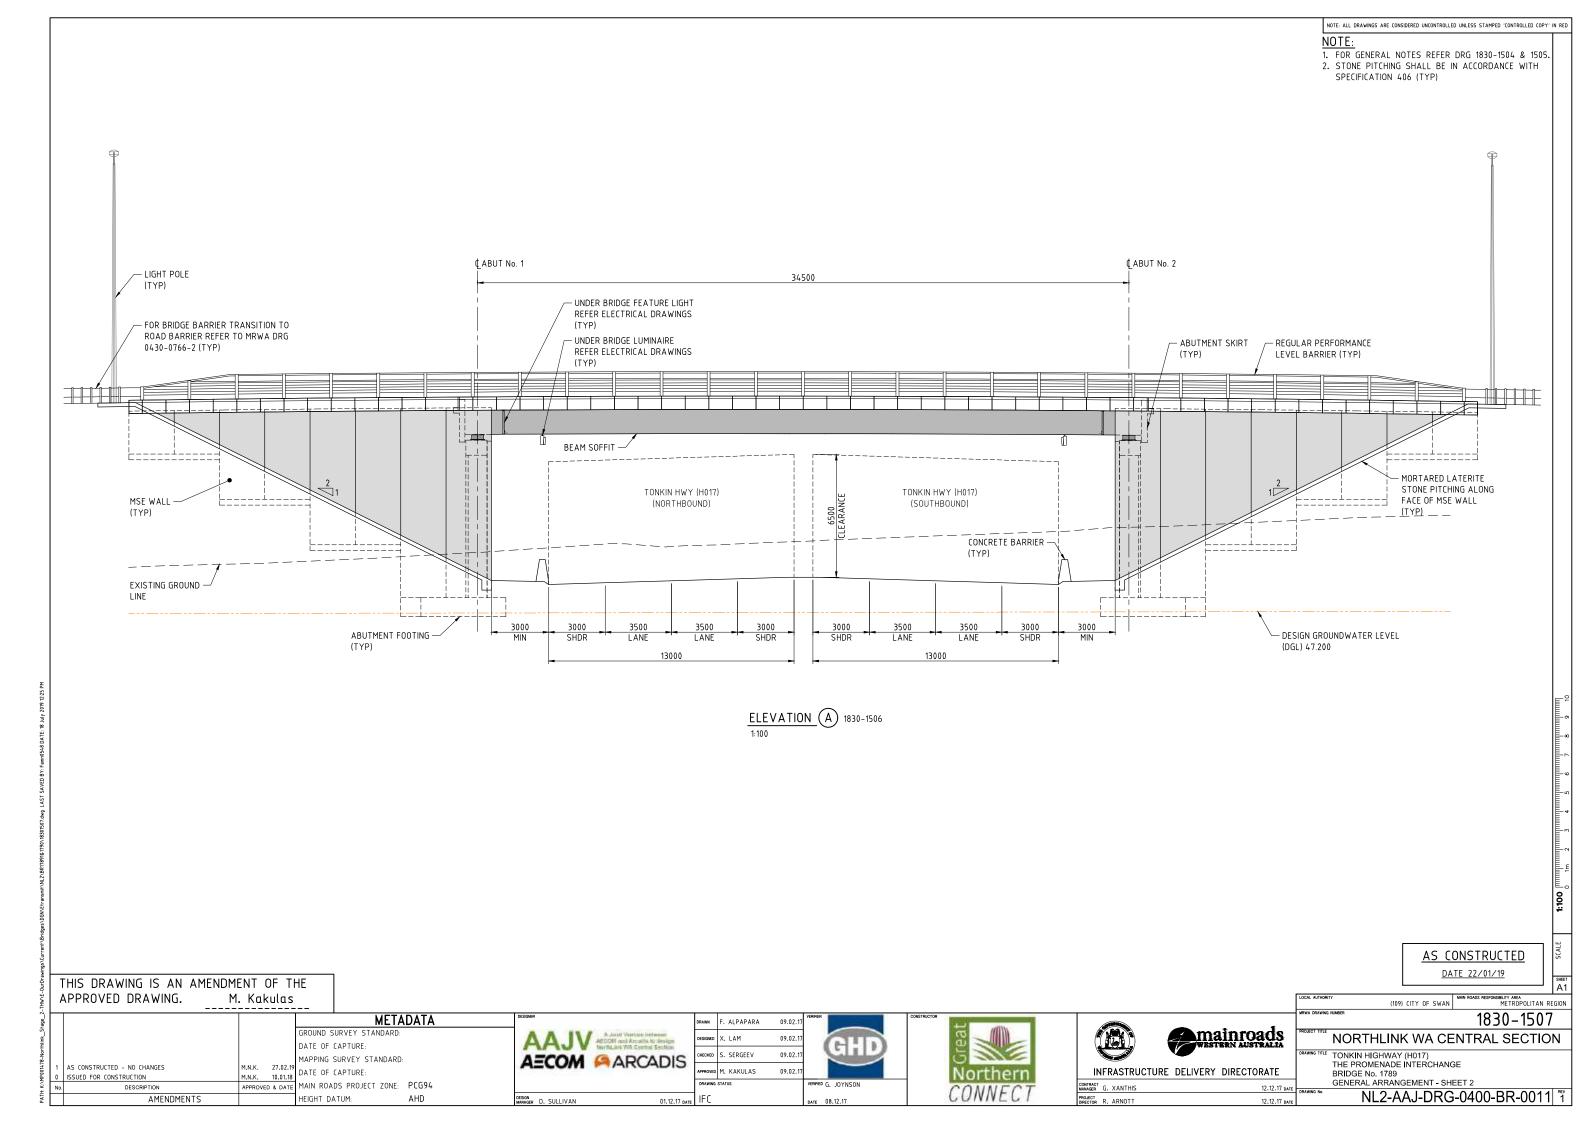

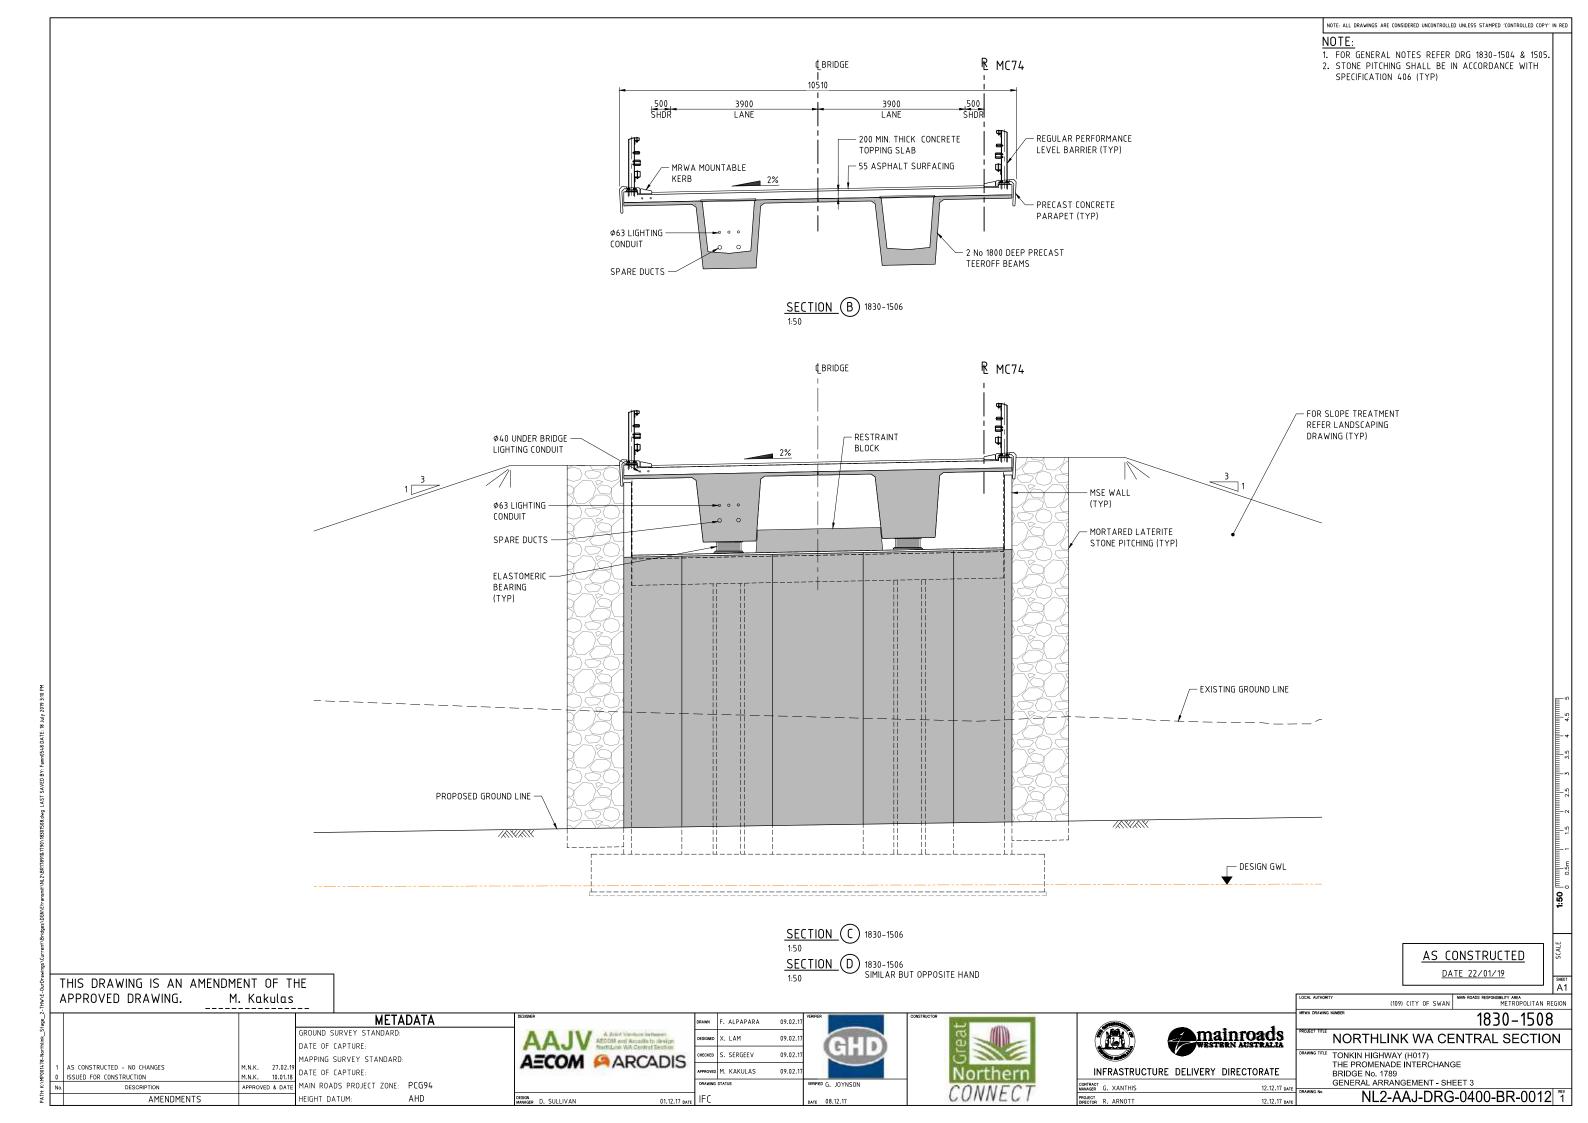

PROJECT DRG N₀.	<u>MRWA DRG No.</u>	DRAWING DESCRIPTION	PROJECT DRG No.	<u>MRWA DRG No.</u>	DRAWING DESCRIPTION
GENERAL			NL2-AAJ-DRG-0400-BR-1074	1830-1582	DECK REINFORCEMENT DETAILS - SHEET 2
L2-AAJ-DRG-0400-BR-1001	1830-1550	LOCALITY PLAN			
NL2-AAJ-DRG-0400-BR-1002	1830-1551	INDEX	NL2-AAJ-DRG-0400-BR-1090	1830-1583	APPROACH SLAB CONCRETE DETAILS
			NL2-AAJ-DRG-0400-BR-1091	1830-1584	APPROACH SLAB REINFORCEMENT DETAILS
IL2-AAJ-DRG-0400-BR-1005	1830-1552	GENERAL NOTES - SHEET 1		1020 1505	
NL2-AAJ-DRG-0400-BR-1006	1830-1553	GENERAL NOTES - SHEET 2	NL2-AAJ-DRG-0400-BR-1100	1830-1585	EXPANSION JOINT DETAILS
NL2-AAJ-DRG-0400-BR-1010	1830-1554	GENERAL ARRANGEMENT – SHEET 1	NL2-AAJ-DRG-0400-BR-1105	1830-1586	COVER PLATE DETAILS - SHEET 1
L2-AAJ-DRG-0400-BR-1011	1830-1555	GENERAL ARRANGEMENT - SHEET 2	NL2-AAJ-DRG-0400-BR-1106	1830-1587	COVER PLATE DETAILS - SHEET 2
L2-AAJ-DRG-0400-BR-1012	1830-1556	GENERAL ARRANGEMENT - SHEET 3			
			NL2-AAJ-DRG-0400-BR-1110	1830-1588	BARRIER LAYOUT
SUBSTRUCTURES			NL2-AAJ-DRG-0400-BR-1111	1830-1589	BARRIER DETAILS – SHEET 1
			NL2-AAJ-DRG-0400-BR-1112	1830-1590	BARRIER DETAILS – SHEET 2
IL2-AAJ-DRG-0400-BR-1015	1830-1557	BORE INFORMATION - SHEET 1	NL2-AAJ-DRG-0400-BR-1113	1830-1591	BARRIER DETAILS – SHEET 3
IL2-AAJ-DRG-0400-BR-1016	1830-1558	BORE INFORMATION - SHEET 2	NL2-AAJ-DRG-0400-BR-1114	1830-1592	BARRIER DETAILS – SHEET 4
IL2-AAJ-DRG-0400-BR-1017	1830-1559	GEOMETRIC DATA		10-20 15:0-2	
NL2-AAJ-DRG-0400-BR-1020	1830-1560	ABUTMENT – MSE WALL LAYOUT	NL2-AAJ-DRG-0400-BR-1115	1830-1593	PRECAST CONCRETE PARAPET DETAILS - SHEET 1
L2-AAJ-DRG-0400-BR-1021	1830-1561	ABUTMENT No. 1 – MSE WALL	NL2-AAJ-DRG-0400-BR-1116	1830-1594	PRECAST CONCRETE PARAPET DETAILS - SHEET 2
L2-AAJ-DRG-0400-BR-1022	1830-1562	ABUTMENT No. 2 – MSE WALL	NL2-AAJ-DRG-0400-BR-1135	10.20 10.00	
L2-AAJ-DRG-0400-BR-1023	1830-1563	ABUTMENT - MSE WALL - TYPICAL SECTIONS	NL2-AAJ-DRG-0400-BR-1135	1830–1595 1830–1596	LIGHTING AND ELECTRICAL LAYOUT LIGHTING AND ELECTRICAL DETAILS
NL2-AAJ-DRG-0400-BR-1024	1830-1564	COLUMN FORMER DETAILS	NL2-AAJ-DRG-0400-BR-1130	1830-1597	LUMINAIRE BRACKET DETAILS
NL2-AAJ-DRG-0400-BR-1025	1830-1565	ABUTMENT No. 1 – CONCRETE DETAILS		1601-00	EUMINAIRE BRACKET DETAILS
L2-AAJ-DRG-0400-BR-1026	1830-1566	ABUTMENT No. 2 - CONCRETE DETAILS	NL2-AAJ-DRG-0400-BR-1155	1830-1598	DESIGN SUMMARY – SHEET 1
NL2-AAJ-DRG-0400-BR-1027	1830-1567	ABUTMENT - CONCRETE DETAILS	NL2-AAJ-DRG-0400-BR-1156	1830–1599	DESIGN SUMMARY - SHEET 2
NL2-AAJ-DRG-0400-BR-1030	1830-1568	ABUTMENT - REINFORCEMENT DETAILS - SHEET 1	MRWA STANDARD		
NL2-AAJ-DRG-0400-BR-1031	1830-1569	ABUTMENT - REINFORCEMENT DETAILS - SHEET 2	DRAWINGS		
NL2-AAJ-DRG-0400-BR-1033	1830-1570	COLUMN REINFORCEMENT DETAILS	-	0430-0760	REGULAR PERFORMANCE LEVEL BARRIER - RAIL ELEV
			-	0430-0761-1	REGULAR PERFORMANCE LEVEL BARRIER - TRANSITIO
SUPERSTRUCTURE			-	0430-0761-2	REGULAR PERFORMANCE LEVEL BARRIER – GUARDRAII
L2-AAJ-DRG-0400-BR-1045	1830-1571	BEARING DETAILS - SHEET 1	-	0430-0763	REGULAR PERFORMANCE LEVEL BARRIER – FIXED SPLI
L2-AAJ-DRG-0400-BR-1046	1830-1572	BEARING DETAILS - SHEET 2	-	0430-0764-1	REGULAR PERFORMANCE LEVEL BARRIER - EXPANSIO
			_	0430-0765-2	REGULAR PERFORMANCE LEVEL BARRIER – TWO RAIL
L2-AAJ-DRG-0400-BR-1050	1830-1573	PRECAST TEEROFF BEAM LAYOUT - SHEET 1	_	0430-0766-2	REGULAR PERFORMANCE LEVEL BARRIER - THREE & F
NL2-AAJ-DRG-0400-BR-1052	1830-1574	PRECAST TEEROFF BEAM - TYPICAL DETAILS	-	0430-0767	REGULAR PERFORMANCE LEVEL BARRIER - TOP RAIL I
NL2-AAJ-DRG-0400-BR-1053	1830-1575	PRECAST TEEROFF BEAM - CONCRETE DETAILS	-	0430-1213-1	REGULAR PERFORMANCE LEVEL BARRIER – INSTALLA
			-	0430-1314	PRECAST PARAPET PANELS
NL2-AAJ-DRG-0400-BR-1057	1830-1576	PRECAST TEEROFF - PRESTRESSING DETAILS	-	9331-0376-3	KERB TYPES
			-	0530-1087-1	BRIDGE BALUSTRADE FOR PSP - SHEET 1
NL2-AAJ-DRG-0400-BR-1060	1830-1577	PRECAST TEEROFF - REINFORCEMENT DETAILS - SHEET 1	-	0530-1307-1	BRIDGE BALUSTRADE FOR PSP - SHEET 2
NL2-AAJ-DRG-0400-BR-1061	1830-1578	PRECAST TEEROFF - REINFORCEMENT DETAILS - SHEET 2			
L2-AAJ-DRG-0400-BR-1070	1830-1579	DECK CONCRETE DETAILS - SHEET 1			
NL2-AAJ-DRG-0400-BR-1071	1830-1580	DECK CONCRETE DETAILS – SHEET 2			


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PATH	AMENDMENTS		HEIGHT DATUM:	AHD	DESIGN MANAGER D. SULLIVAN 01.12.17 dat	IFC	DATE 08.12.17	CONNECT	PROJECT DIRECTOR R. ARNOTT


DECK REINFORCEMENT DETAILS - SHEET 1


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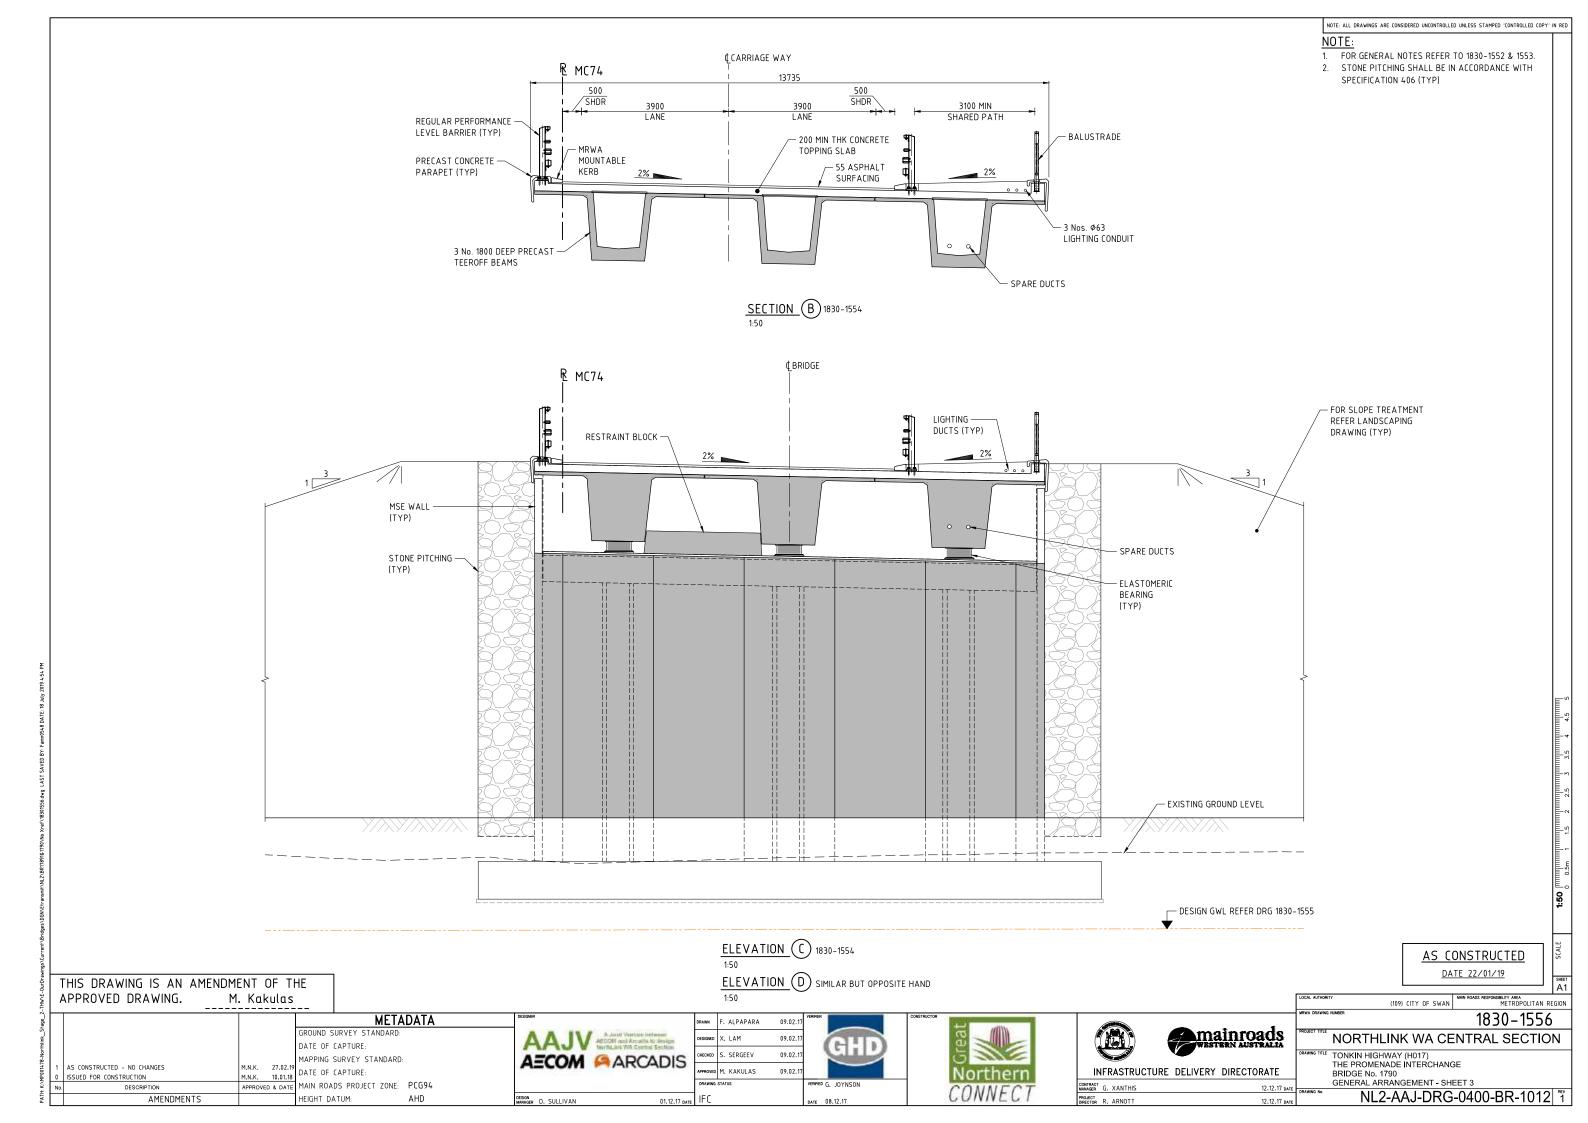
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LIVERY DIRECTORATE 12.12.17 date		REV
12.12.17 date	DRAWNIG No. NL2-AAJ-DRG-0400-BR-1002	nev 1

NOTE: ALL DRAWINGS ARE CONSIDERED UNCONTROLLED UNLESS STAMPED 'CONTROLLED COPY' IN RED



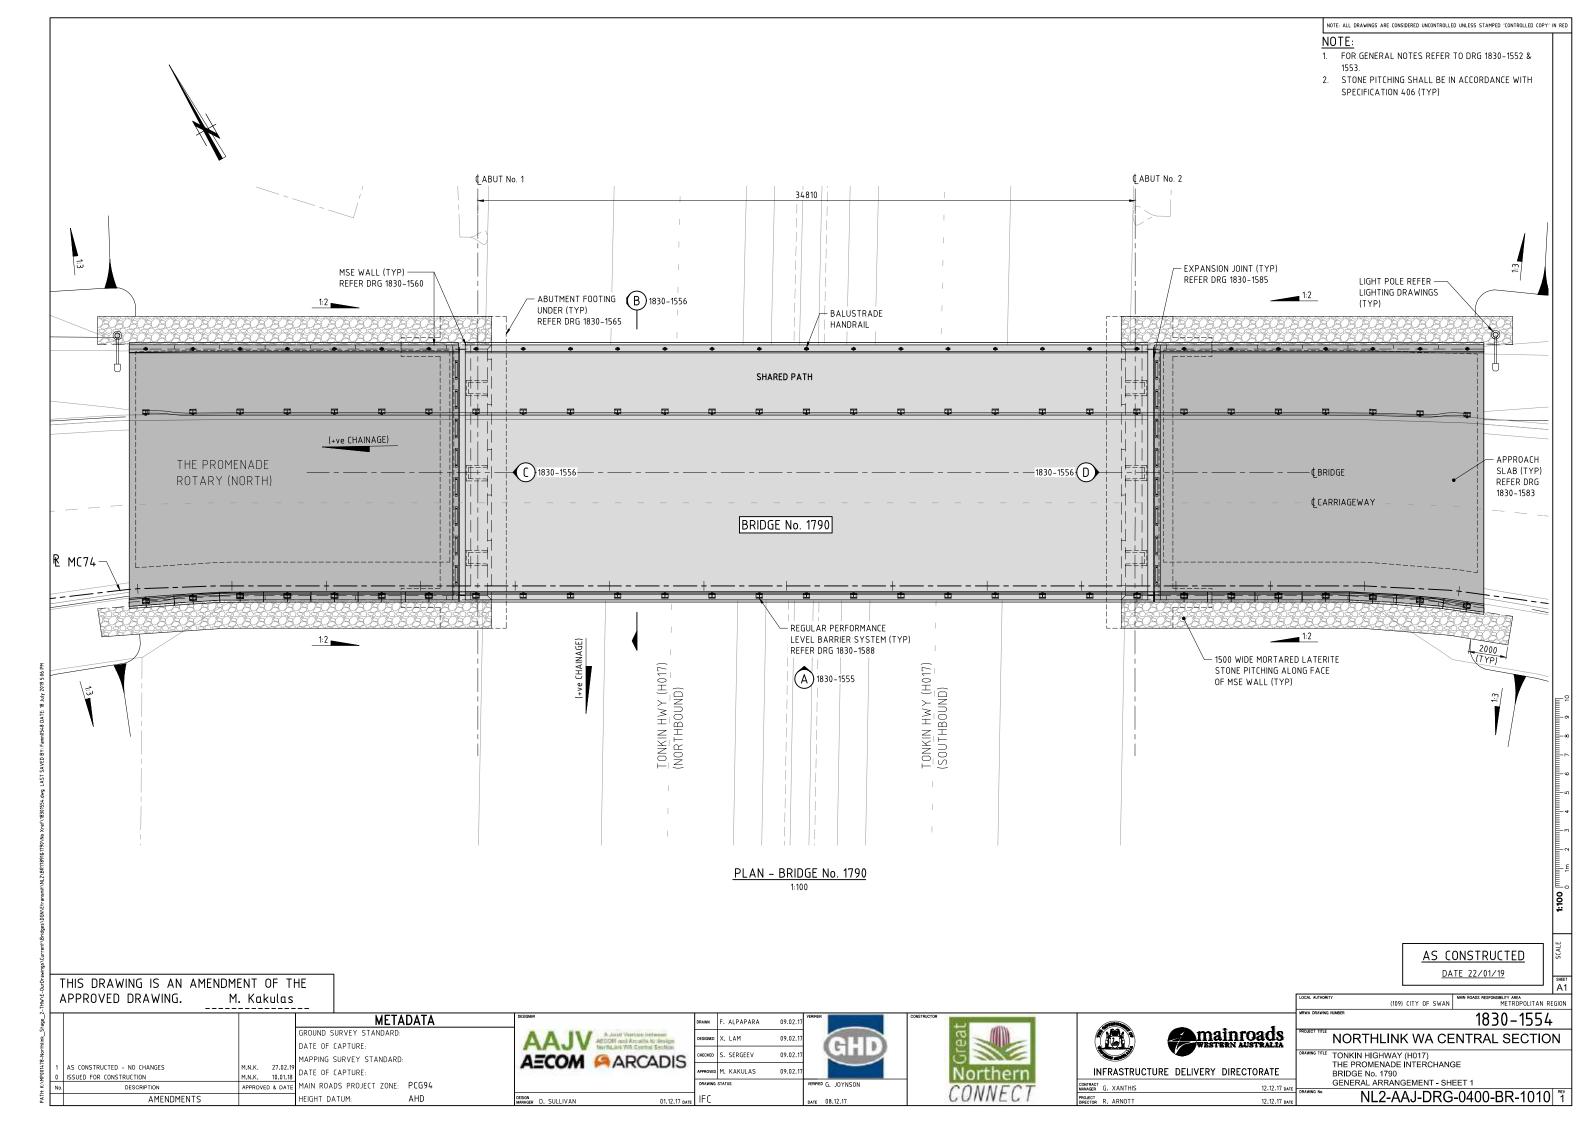

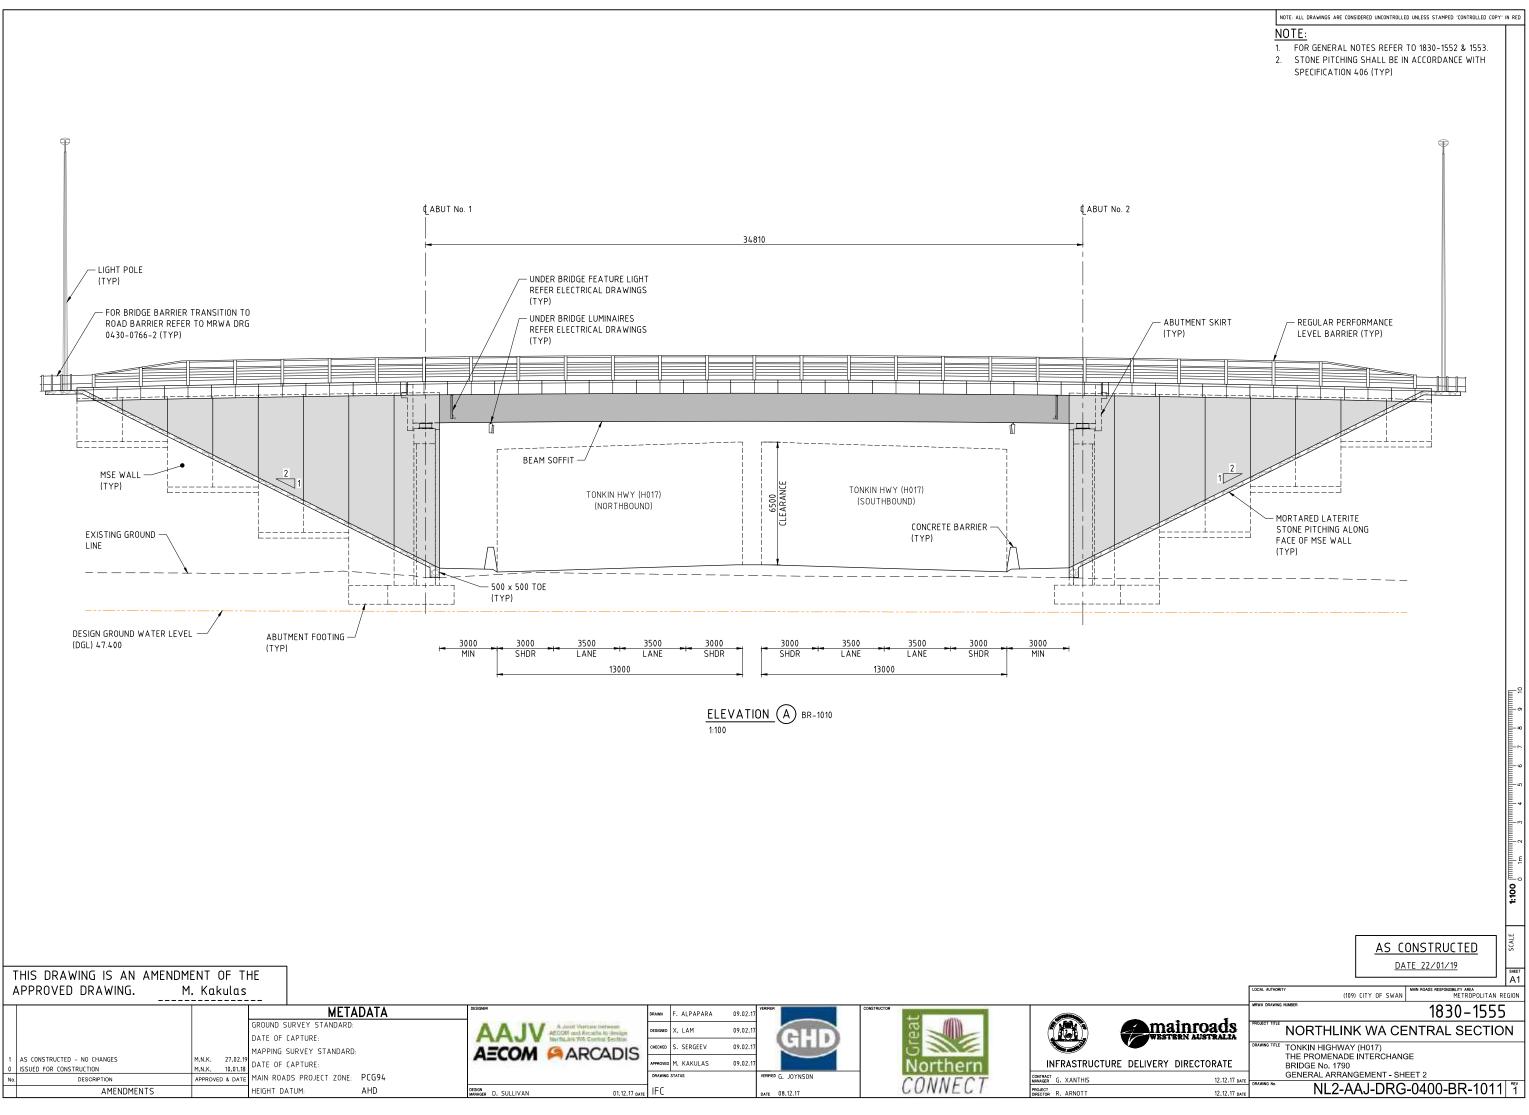


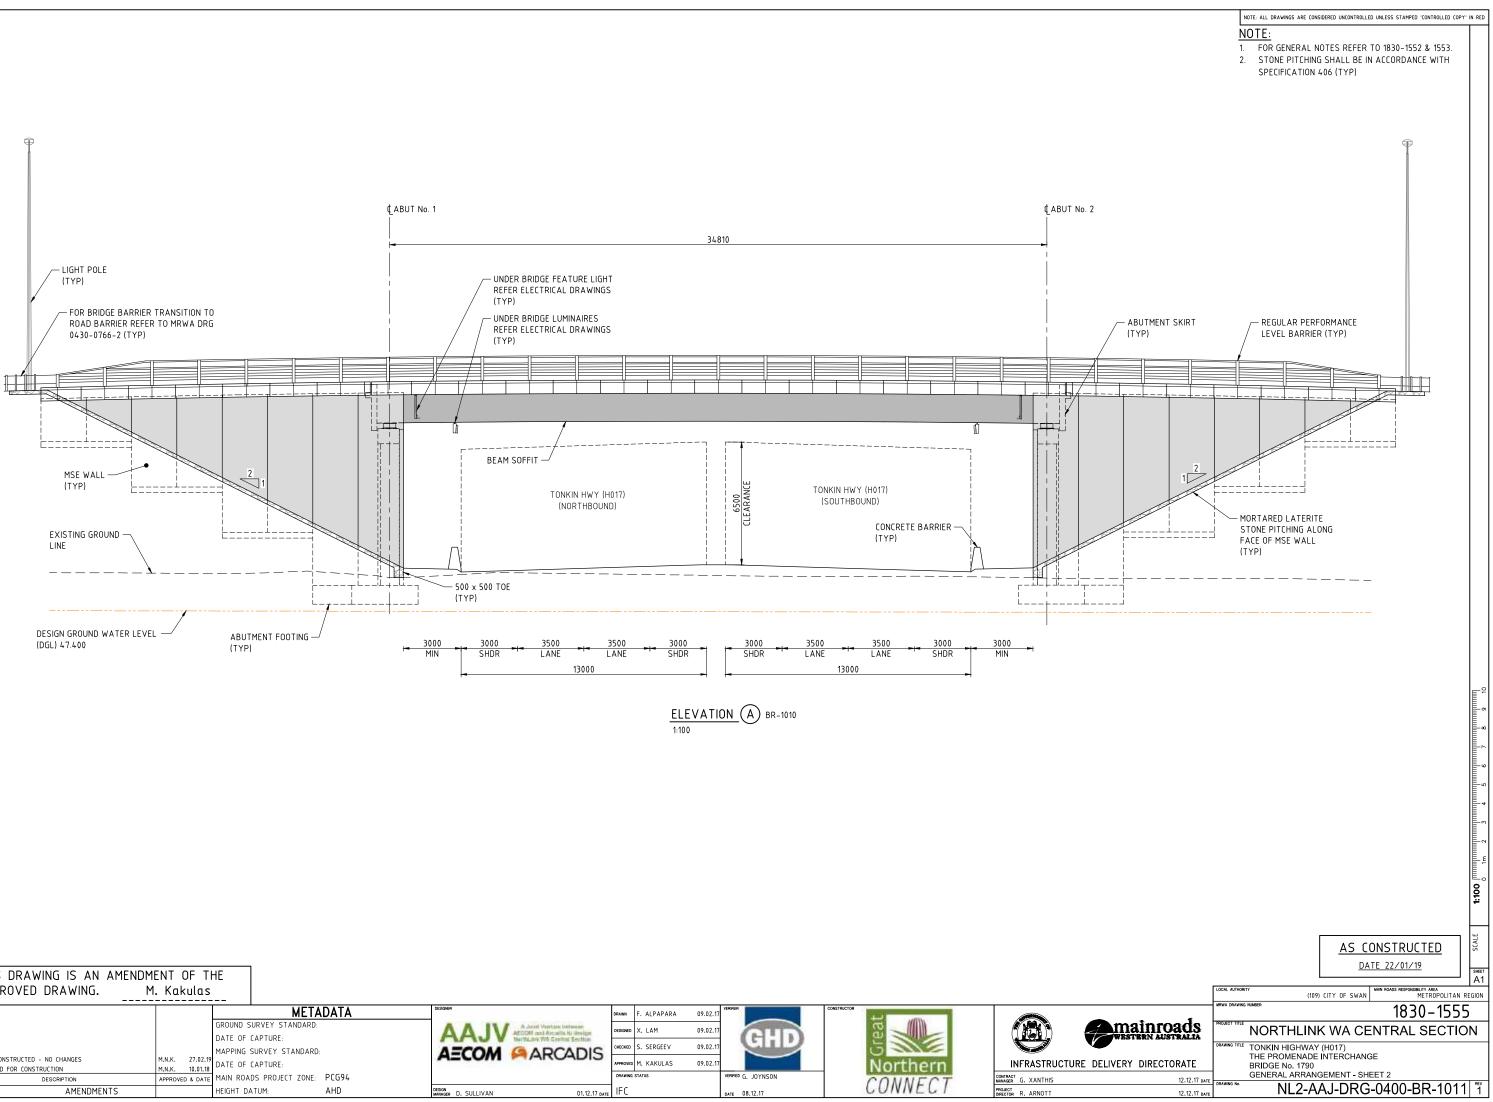



DRAWING INDEX		
DRAWING NUMBER	MRWA DRG No.	DESCRIPTION
NL2-AAJ-DRG-0410-UP-0001	1830-1602	LOCALITY PLAN
NL2-AAJ-DRG-0410-UP-0002	1830-1603	INDEX
NL2-AAJ-DRG-0410-UP-0005	1830-1604	GENERAL NOTES
NL2-AAJ-DRG-0410-UP-0010	1830-1605	GENERAL ARRANGEMENT - SHEET 1
NL2-AAJ-DRG-0410-UP-0011	1830-1606	GENERAL ARRANGEMENT - SHEET 2
NL2-AAJ-DRG-0410-UP-0012	1830-1607	GENERAL ARRANGEMENT - SHEET 3
NL2-AAJ-DRG-0410-UP-0013	1830-1608	BOREHOLE DATA
NL2-AAJ-DRG-0410-UP-0015	1830-1609	FOOTING CONCRETE DETAILS
NL2-AAJ-DRG-0410-UP-0020	1830-1610	FOOTING REINFORCEMENT DETAILS
NL2-AAJ-DRG-0410-UP-0025	1830–1611	PRECAST UNITS - LAYOUT AND DETAILS
NL2-AAJ-DRG-0410-UP-0030	1830-1612	SPANDREL WALL LAYOUT AND DETAILS – SHEET 1
NL2-AAJ-DRG-0410-UP-0031	1830-1613	SPANDREL WALL LAYOUT AND DETAILS – SHEET 2
NL2-AAJ-DRG-0410-UP-0032	1830-1614	MSE WALL - TYPICAL DETAILS
	40.20 4645	
NL2-AAJ-DRG-0410-UP-0040	1830-1615	
NL2-AAJ-DRG-0410-UP-0041	1830–1616	WING WALL CONCRETE DETAILS
NL2-AAJ-DRG-0410-UP-0045	1830-1617	SKYLIGHT DETAILS
NL2-AAJ-DRG-0410-UP-0050	1830-1618	BALUSTRADE LAYOUT
NL2-AAJ-DRG-0410-UP-0060	1830-1619	LUMINAIRE DETAILS
NL2-AAJ-DRG-0410-UP-0065		DESIGN SUMMARY & LOADING RATING
MRWA STANDARD DRAWINGS		
-	0530-1087-1	BRIDGE BALUSTRADE FOR PSP - SHEET 1
-	0530-1307-1	BRIDGE BALUSTRADE FOR PSP - SHEET 2

2-THW\E-OurDrawii	THIS DRAWING IS AN AMEN APPROVED DRAWING.	DMENT OF T M. Kakulas											
MP001478-Northlink_Stage_	1 AS CONSTRUCTED - NO CHANGES 0 ISSUED FOR CONSTRUCTION	M.N.K. 20.03.19 M.N.K. 13.02.19	GROUND SURVEY STANDARD: DATE OF CAPTURE: MAPPING SURVEY STANDARD DATE OF CAPTURE:			NorthLink WA Central Sealion	DRAINN F. ALPAPARA DESIGNED T. SMITH CHECKED M. KAKULAS APPROVED M. KAKULAS	01.12.17 01.12.17 01.12.17 30.08.17	GHD	CONSTRUCTOR	Northern	INFRASTRUCTU	
PATH: K:V	No. DESCRIPTION AMENDMENTS		MAIN ROADS PROJECT ZONE: HEIGHT DATUM:	PCG94 AHD	DESIGN MANAGER D. SULLIVAN	16.01.19 date	DRAWING STATUS		verified G. JOYNSON date 21.01.19		CONNECT	CONTRACT MANAGER G. XANTHIS PROJECT DIRECTOR A. MAGNO	

		SCALE
-	<u>DATE 01/03/19</u>	SHEET A1
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mainroads 🛓	VALUERANNO KANGER 1830-1603	
WESTERN AUSTRALIA		
ERY DIRECTORATE	ANNO TITE TONKIN HIGHWAY (H017) THE PROMENADE INTERCHANGE UNDERPASS No. 9432	
05.03.40	INDEX	REV
05.02.19 date	NL2-AAJ-DRG-0410-UP-0002	1

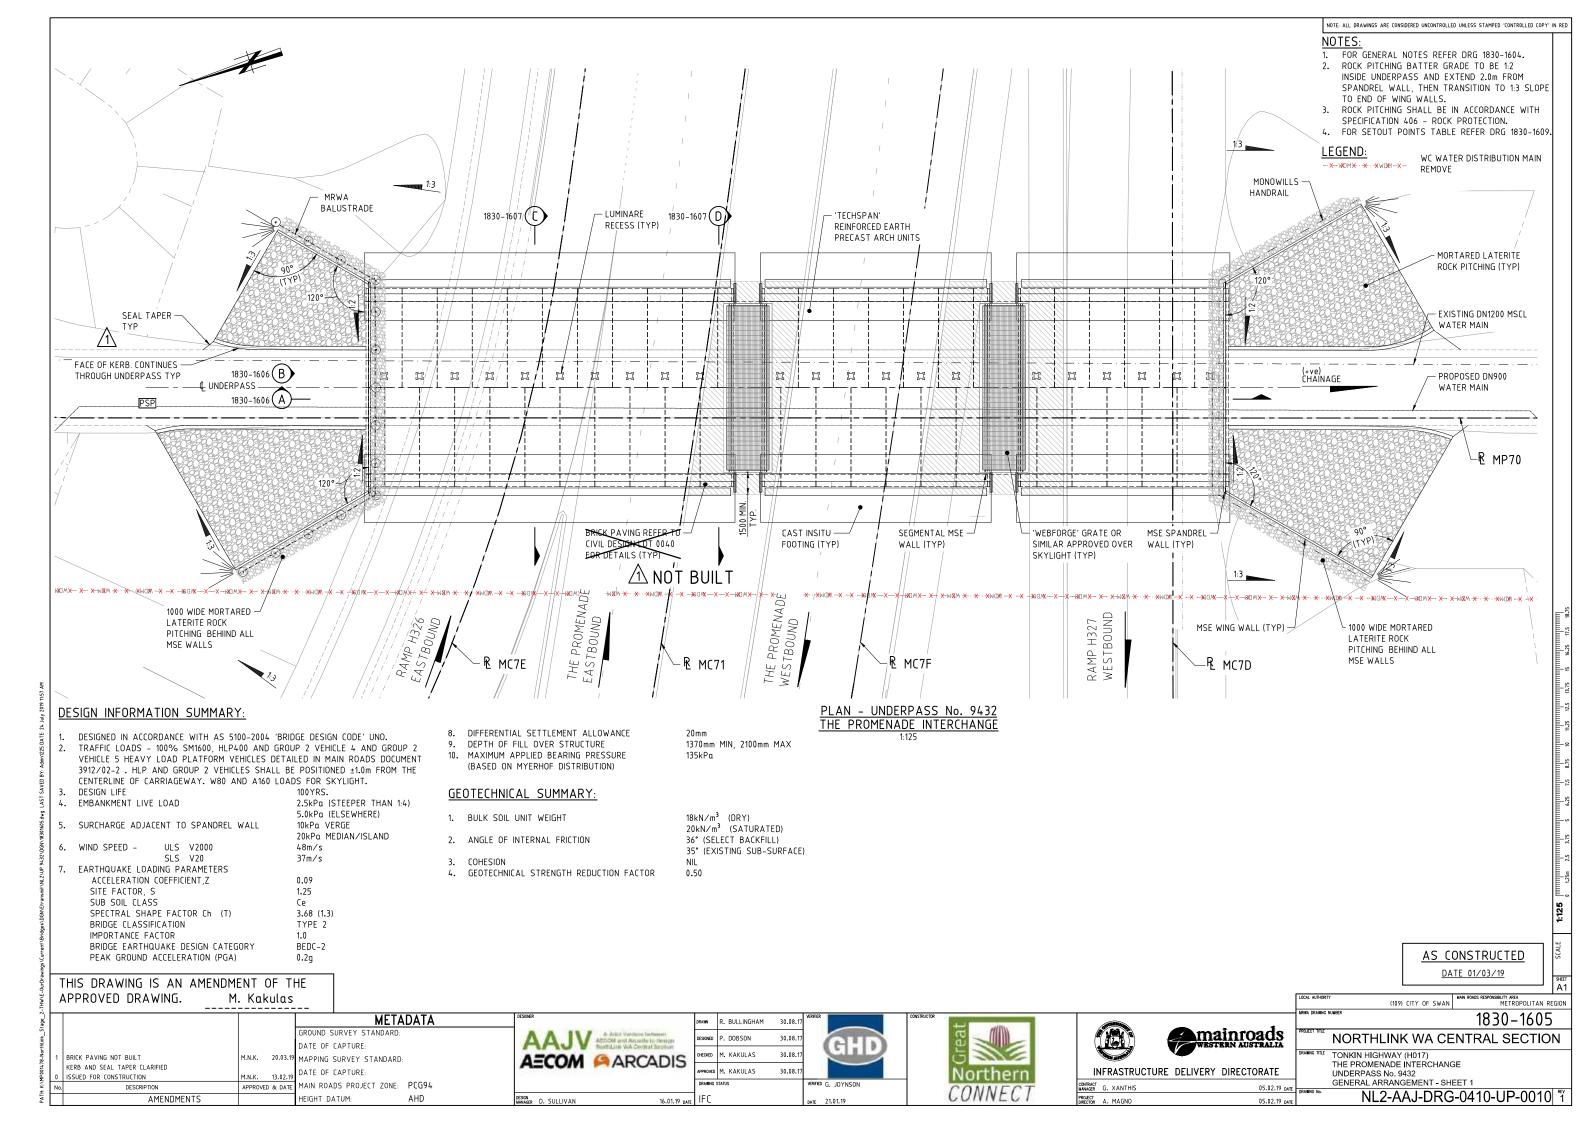

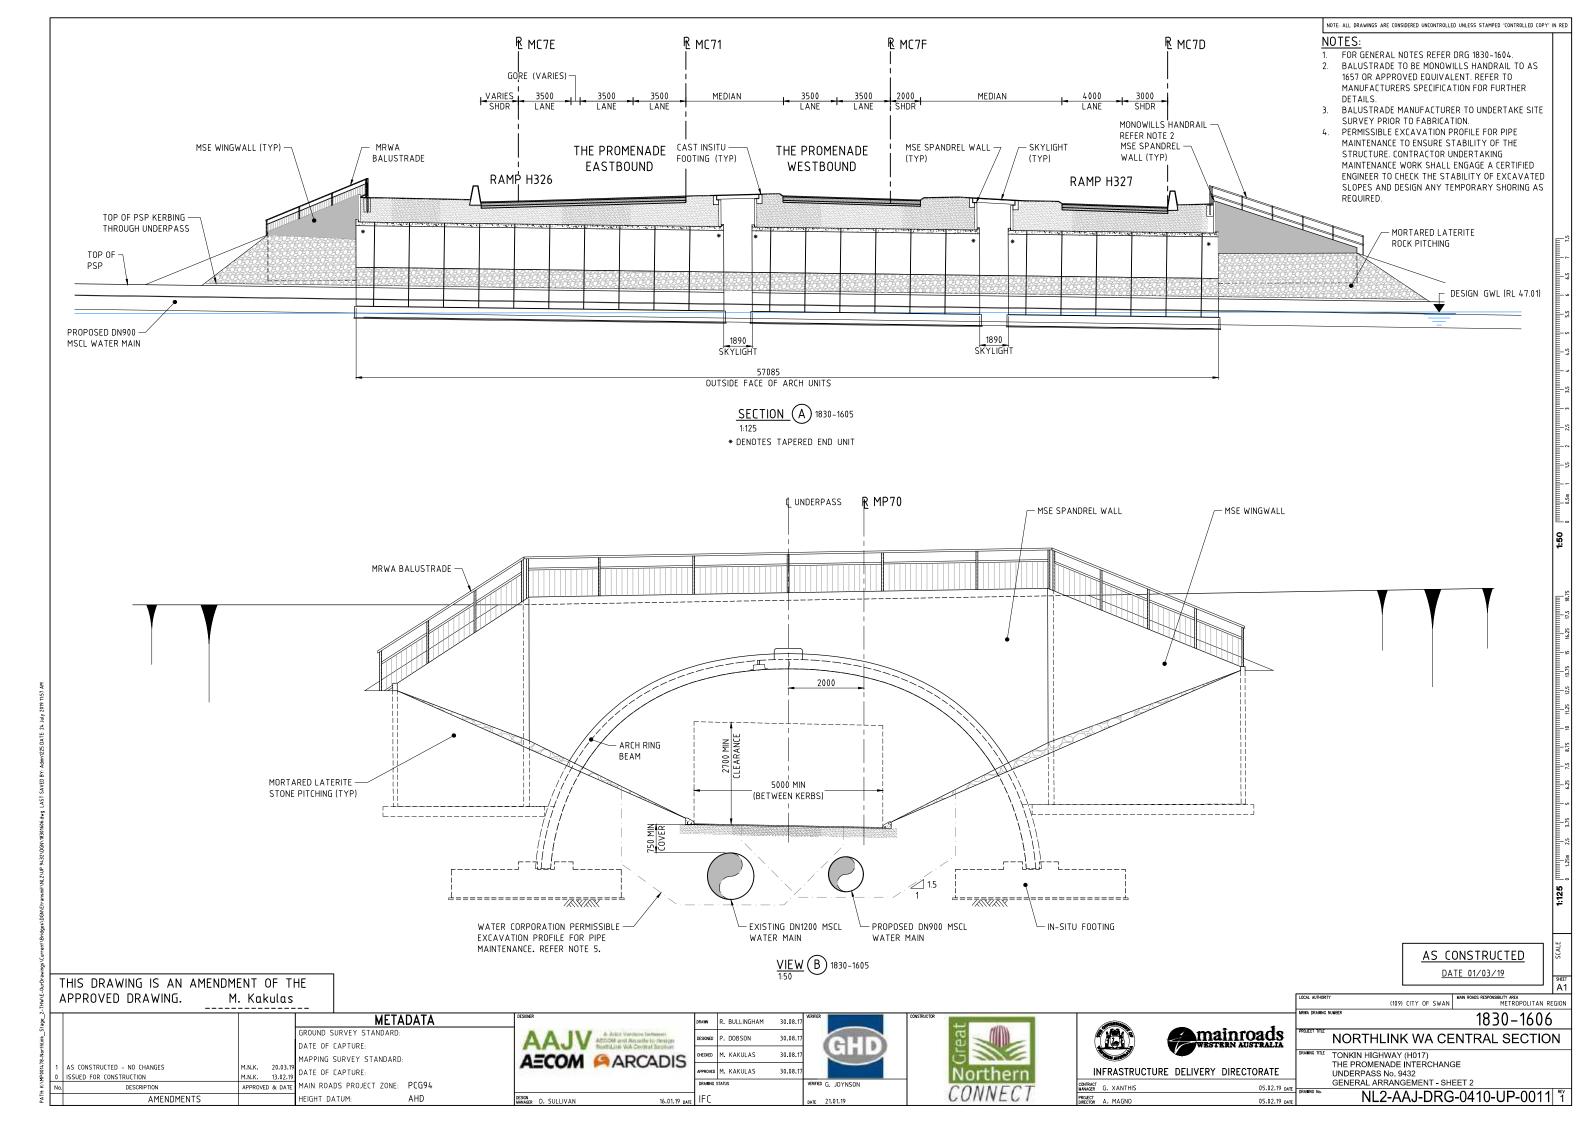

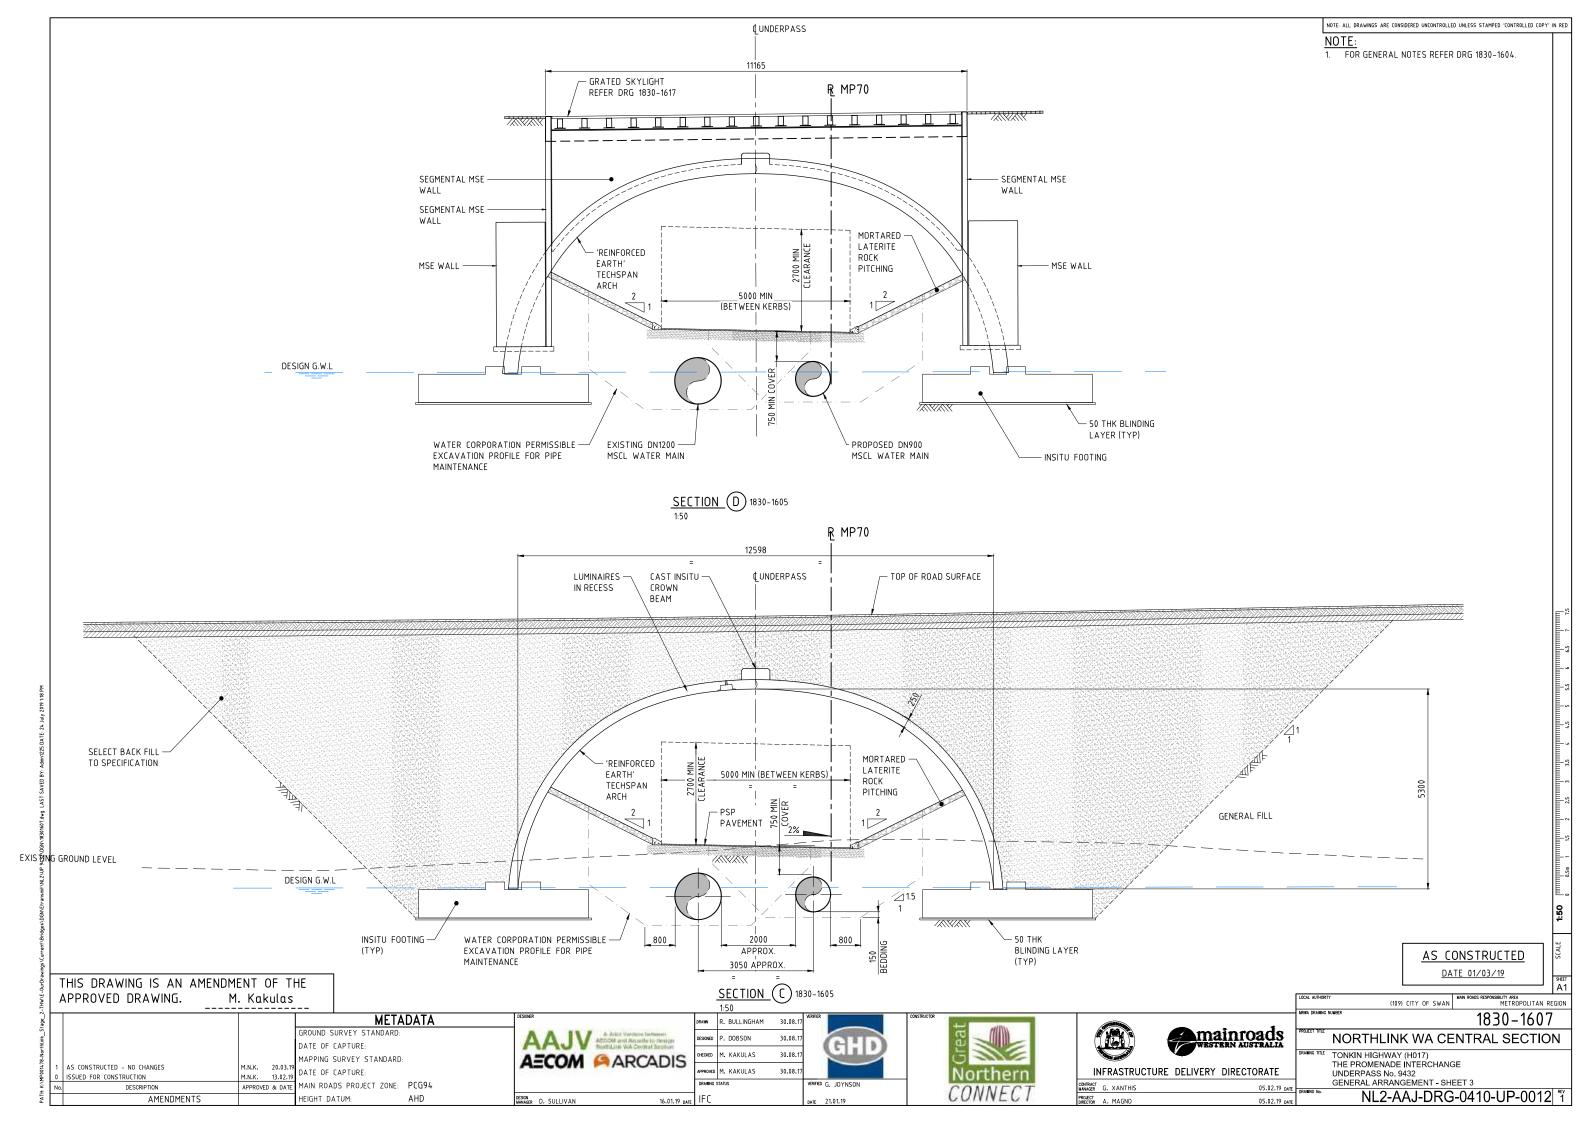


NORTHLINK STAGE 3 DRAWING INDEX				
	DRAWING TITLE	DRG N°	DRAWING TITLE	
GENERAL		SUPER-STRUCTURE (CON'T)	<u></u>	
				MRWA RE
NL3-BGE-210-ST-DG-1000	COVER SHEET	NL3-BGE-210-ST-DG-1315		9230-0921-6
NL3-BGE-210-ST-DG-1001	INDEX SHEET	NL3-BGE-210-ST-DG-1320 NL3-BGE-210-ST-DG-1330	DECK REINFORCEMENT ELEVATIONS DECK REINFORCEMENT SECTIONS AND DETAILS	
NL3-BGE-210-ST-DG-1005	GENERAL NOTES		DECK REINFORCEMENT SECTIONS AND DETAILS	
		NL3-BGE-210-ST-DG-1340	DECK WATERPROOFING PLAN AND DETAILS	
NL3-BGE-210-ST-DG-1008	CONSTRUCTION NOTES			
		NL3-BGE-210-ST-DG-1350	APPROACH SLAB CONCRETE PLAN AND DETAILS	
NL3-BGE-210-ST-DG-1010	DESIGN SUMMARY SHEET 1 OF 3			
NL3-BGE-210-ST-DG-1011	DESIGN SUMMARY SHEET 2 OF 3	NL3-BGE-210-ST-DG-1355	APPROACH SLAB REINFORCEMENT PLAN AND SECTIONS	
NL3-BGE-210-ST-DG-1012	DESIGN SUMMARY SHEET 3 OF 3			
		NL3-BGE-210-ST-DG-1360	EXPANSION JOINT PLAN AND SECTIONS	
NL3-BGE-210-ST-DG-1020	GENERAL ARRANGEMENT PLAN			
NL3-BGE-210-ST-DG-1021 NL3-BGE-210-ST-DG-1022	GENERAL ARRANGEMENT ELEVATION GENERAL ARRANGEMENT SECTIONS	NL3-BGE-210-ST-DG-1365 NL3-BGE-210-ST-DG-1366	COVER PLATE PLAN AND SECTIONS COVER PLATE DETAILS	
NED-DGE-210-31-DG-1022	GENERAL ARRANGENENT SECTIONS	NEJ-DGE-210-31-DG-1300		
NL3-BGE-210-ST-DG-1040	SITE INVESTIGATION INFORMATION SHEET 1 OF 2	NL3-BGE-210-ST-DG-1370	BARRIER LAYOUT PLAN AND DETAILS	
NL3-BGE-210-ST-DG-1041	SITE INVESTIGATION INFORMATION SHEET 2 OF 2	NL3-BGE-210-ST-DG-1375	BARRIER SECTIONS AND DETAILS	
NL3-BGE-210-ST-DG-1050	GEOMETRIC DATA	NL3-BGE-210-ST-DG-1380	PRECAST PANEL PLANS AND ELEVATIONS - SHEET 1	
		NL3-BGE-210-ST-DG-1381	PRECAST PANEL PLANS AND ELEVATIONS - SHEET 2	
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NL3-BGE-210-ST-DG-1081 NL3-BGE-210-ST-DG-1082	ABUTMENT N° 2 MSE WALL PLAN AND ELEVATION ABUTMENT MSE WALL DETAILS	NL3-BGE-210-ST-DG-1395	INSITU BARRIER STITCH ELEVATION AND DETAILS	
NE3-DUE-210-31-DU-1002	ADOTMENT MISE WALL DETAILS	NL 3-DUE-2 IV-3 I -DU- 1375	INSITU DARRIER STITCH ELEVATION AND DETAILS	
NL3-BGE-210-ST-DG-1100	ABUTMENT N° 1 FOOTING CONCRETE PLAN AND SECTIONS	NL3-BGE-210-ST-DG-1400	INSITU TRANSITION BARRIER ELEVATION AND DETAILS	
		NL3-BGE-210-ST-DG-1401	INSITU TRANSITION BARRIER REINFORCEMENT DETAILS	
NL3-BGE-210-ST-DG-1105	ABUTMENT N° 2 FOOTING CONCRETE PLAN AND SECTIONS			
		NL3-BGE-210-ST-DG-1430	SERVICES LAYOUT PLAN AND SECTIONS	
NL3-BGE-210-ST-DG-1110	ABUTMENT N° 1 AND N° 2 FOOTING REINFORCEMENT PLAN AND SECTIONS	NL3-BGE-210-ST-DG-1431	SERVICES SECTION AND DETAILS	
NL3-BGE-210-ST-DG-1115	PRECAST COLUMN FORMER CONCRETE AND REINFORCEMENT DETAILS	NL3-BGE-210-ST-DG-1450	UNDER BRIDGE LIGHTING LAYOUT PLAN AND DETAILS	
	FRECAST COLONIA FORMER CONCRETE AND REINFORCEMENT DETAILS	NCJ-DUC-210-31-DU-1450	UNDER DRIDGE EIGTHING EATOUT FEAN AND DETAILS	
NL3-BGE-210-ST-DG-1120	PRECAST COLUMN FORMER INFILL CONCRETE AND REINFORCEMENT DETAILS			
NL3-BGE-210-ST-DG-1125	ABUTMENT N° 1 CAP BEAM CONCRETE PLAN, ELEVATION AND SECTIONS			
NL3-BGE-210-ST-DG-1127	ABUTMENT N° 2 CAP BEAM CONCRETE PLAN AND ELEVATION			
NL3-BGE-210-ST-DG-1130	ABUTMENT N° 1 AND N°2 CAPBEAM REINFORCEMENT PLAN AND SECTIONS			
NEJ-DUL-210-31-DU-1130	ADOTMENT N TAND N Z CAPDEAM REINI ORCEMENT PEAN AND SECTIONS			
NL3-BGE-210-ST-DG-1190	BEARINGS PLAN AND NOTES			
NL3-BGE-210-ST-DG-1191	BEARINGS SECTIONS AND DETAILS			
SUPER-STRUCTURE				
NL3-BGE-210-ST-DG-1200	PRECAST PLANK LAYOUT PLAN AND DETAILS			
NL3-BGE-210-ST-DG-1210	PRECAST PLANK CONCRETE PLAN AND SECTIONS			
NL3-BGE-210-ST-DG-1220	PRECAST PLANK CONCRETE SECTIONS AND DETAILS			
NL3-BGE-210-ST-DG-1240	PRECAST PLANK PRESTRESS LAYOUT AND NOTES			
NL3-BGE-210-ST-DG-1250	PRECAST PLANK REINFORCEMENT PLAN AND SECTION			
NL3-BGE-210-ST-DG-1260 NL3-BGE-210-ST-DG-1270	PRECAST PLANK REINFORCEMENT SECTIONS PRECAST PLANK REINFORCEMENT ABUTMENT & INTERNAL DIAPHRAGMS			
	TALCAST FLAMA ALIM UNCLUDINT ADUTHENT & INTERNAL DIAPAKAUMS			
NL3-BGE-210-ST-DG-1300	DECK CONCRETE PLAN AND DETAILS			
	DECK CONCRETE PLAN AND DETAILS DECK CONCRETE PLAN AND ELEVATION			


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								LOCAL AUTHORITY CITY OF SWAN (109) MAIN ROADS RESPONSIBILITY AREA METROPOLITAN / WHEATBELT
			1					MRWA DRAWING NUMBER
			DRAWN K. TAYLOR 19.02.18	Kellogg Brown & Root Pty Ltd			• main roada	
	GROUND SURVEY STANDARD: 67-08-43	Perth Office-	DESIGNED J. JAMESON 19.02.18	KBR				NORTHLINK WA STAGE 3
	DATE OF CAPTURE: MAPPING SURVEY STANDARD: 67-08-43	484 Murray St, Perth WA 6000 P/+61 8 6364 3300	CHECKED P. THOMPSON 19.02.18		CPB			TONKIN HIGHWAY H017 (15.90 SLK)
0 ISSUED FOR CONSTRUCTION PDT 10.04.18	DATE OF CAPTURE:	E / info@bgeeng.com	APPROVED C. RAMM 02.03.18	Western Australia 6000	CONTRACTORS	INFRASTRUCTU	RE DELIVERY DIRECTORATE	BRIDGE N° 1801 OVER STOCK ROAD WEST INTERCHANGE INDEX SHEET
	MAIN ROADS PROJECT ZONE: PCG94	bgeeng.com-	DRAWING STATUS	R. DENHAM	PROJECT S. NICOLAY 2	3.03.18 PROJECT Y. SIDDIQUI	27.03.18	
AMENDMENTS	HEIGHT DATUM: AHD	BG&E DOC No: P17077	IFC			23.03.18 PROJECT R. ARNOTT	28.03.18 DATE	NL3-BGE-210-ST-DG-1001

REFERENCE DRAWINGS

21-6 LUMINAIRE SUPPORT BRACKET AND COVER PLATE DETAILS

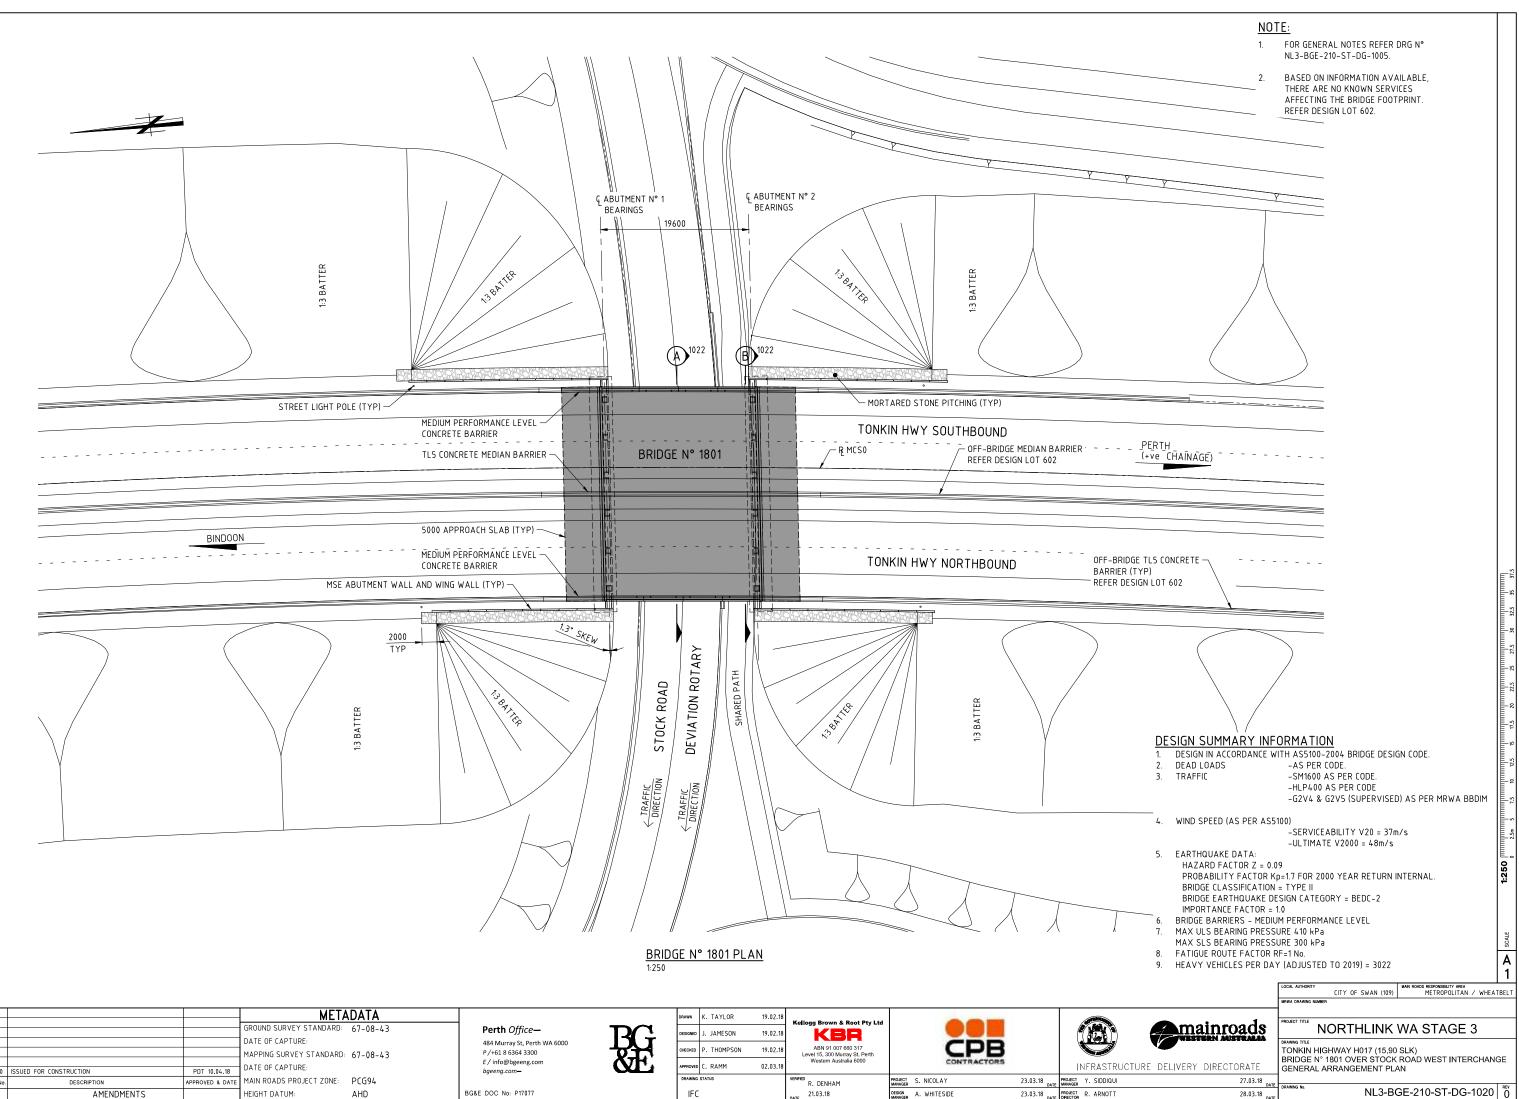



THOMPSON	19.02.18	ABN 91 007 660 317 Level 15, 300 Murray St, Perth			CPB			4	V		
RAMM	02.03.18	Western Australia 6000			CONTRACTORS				١FI	RASTRUC	
S		R. DENHAM	PROJECT	s.	NICOLAY	23.03.18	DATE	PROJECT MANAGER	Υ.	SIDDIQUI	
		21.03.18 DATE	DESIGN MANAGER	A.	WHITESIDE	23.03.18	DATE	PROJECT DIRECTOR	R.	ARNOTT	

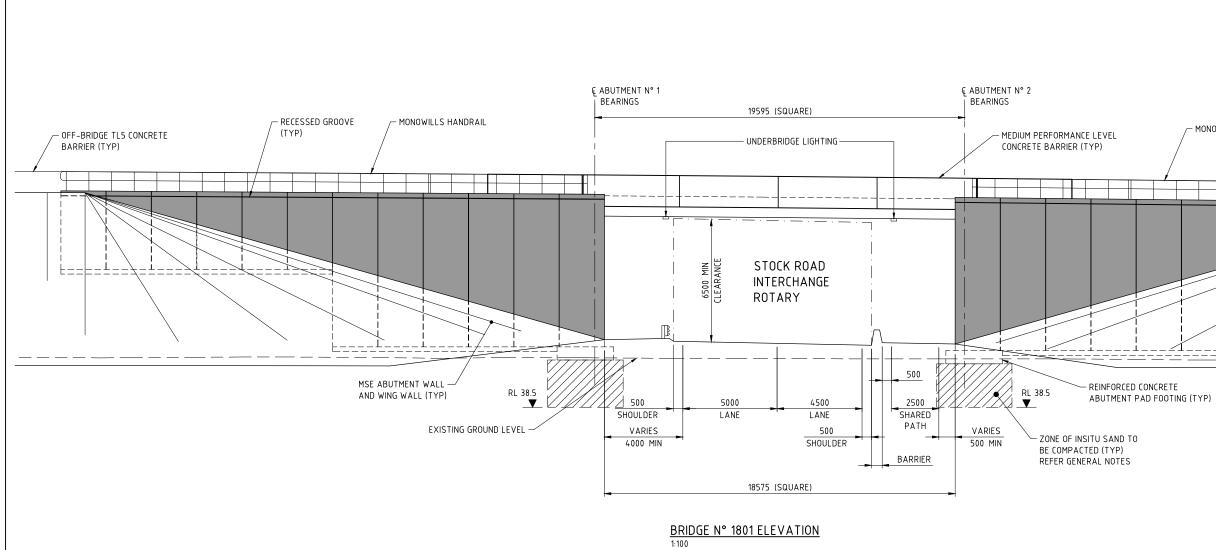

			META	ADATA			DRAWN K. TAYLO	DR 19.02.18				
			GROUND SURVEY STANDARD:		Perth Office—		DESIGNED J. JAMES	ON 19.02.18	Kellogg Brown & Root Pty Ltd			
-			DATE OF CAPTURE:		484 Murray St, Perth WA 6000	-11 <u>†</u>	DESIGNED J. JAPIES	19.02.10	KBR	CDB		
			MAPPING SURVEY STANDARD:	67-08-43	P/+61 8 6364 3300	FEG	CHECKED P. THOM	PSON 19.02.18	ABN 91 007 660 317 Level 15, 300 Murray St, Perth			
_	ISSUED FOR CONSTRUCTION	PDT 10.04.18	DATE OF CAPTURE:		E / info@bgeeng.com	ČTF.	APPROVED C. RAMM	02.03.18	Western Australia 6000	CONTRACTORS		INFRASTRUCTUR
U					bgeeng.com-							
No.	. DESCRIPTION	APPROVED & DATE	MAIN ROADS PROJECT ZONE:	PCG94			DRAWING STATUS		R. DENHAM	PROJECT S. NICOLAY	23.03.18 DATE	PROJECT Y. SIDDIQUI
	AMENDMENTS		HEIGHT DATUM:	AHD	BG&E DOC No: P17077		IFC		21.03.18	DESIGN A. WHITESIDE	23.03.18	PROJECT R. ARNOTT

NOTE: 1. FOR GENERAL NOTES REFER DRG N° NL3-BGE-210-ST-DG-1005.

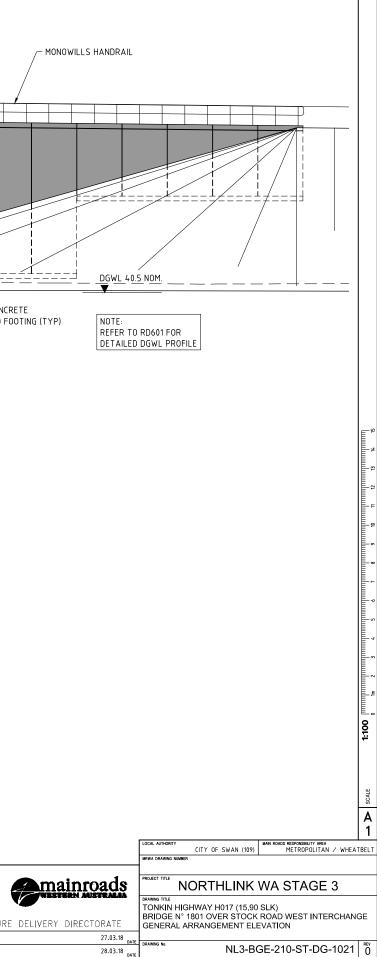

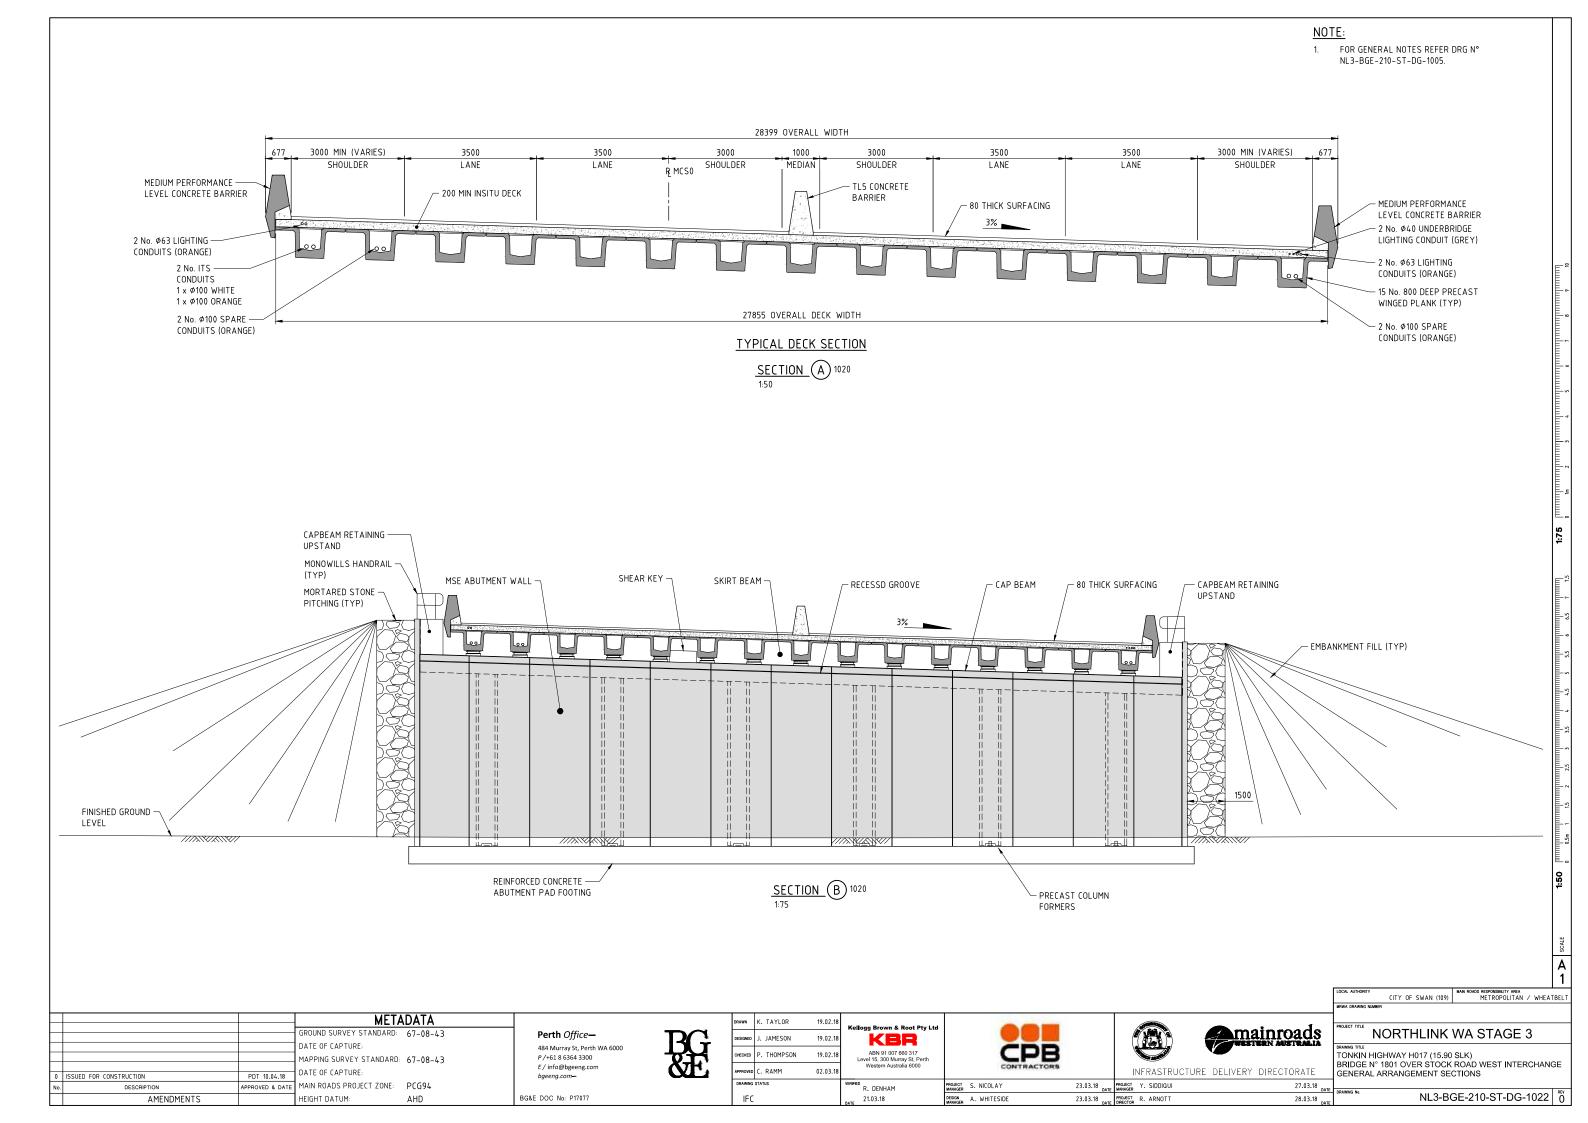



DRAWING INDEX				
DRG N°	DRAWING TITLE	DRG N°	DRAWING TITLE	
GENERAL		SUPER-STRUCTURE (CON'T)		MRWA R
NL3-BGE-210-ST-DG-2000	COVER SHEET	NL3-BGE-210-ST-DG-2315	DECK REINFORCEMENT PLAN	9230-0921-
NL3-BGE-210-ST-DG-2000	INDEX SHEET	NL3-BGE-210-ST-DG-2315	DECK REINFORCEMENT PLAN DECK REINFORCEMENT ELEVATION	72,50-0,721-
NEJ-DGE-210-31-DG-2001		NL3-BGE-210-ST-DG-2330	DECK REINFORCEMENT SECTIONS AND DETAILS	
NL3-BGE-210-ST-DG-2005	GENERAL NOTES		been neini oncenent sections and betales	
		NL3-BGE-210-ST-DG-2340	DECK WATERPROOFING PLAN AND DETAILS	
NL3-BGE-210-ST-DG-2008	CONSTRUCTION NOTES			
		NL3-BGE-210-ST-DG-2350	APPROACH SLAB CONCRETE PLAN AND DETAILS	
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NL3-BGE-210-ST-DG-2011	DESIGN SUMMARY SHEET 2 OF 3	NL3-BGE-210-ST-DG-2355	APPROACH SLAB REINFORCEMENT PLAN AND SECTIONS	
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		NL3-BGE-210-ST-DG-2360	EXPANSION JOINT PLAN AND SECTIONS	
NL3-BGE-210-ST-DG-2020	GENERAL ARRANGEMENT PLAN			
NL3-BGE-210-ST-DG-2021	GENERAL ARRANGEMENT ELEVATION	NL3-BGE-210-ST-DG-2365	COVER PLATE PLAN AND SECTIONS	
NL3-BGE-210-ST-DG-2022	GENERAL ARRANGEMENT SECTIONS	NL3-BGE-210-ST-DG-2366	COVER PLATE DETAILS	
NL3-BGE-210-ST-DG-2040	SITE INVESTIGATION INFORMATION SHEET 1 OF 2	NL3-BGE-210-ST-DG-2370	BARRIER LAYOUT PLAN AND DETAILS	
NL3-BGE-210-ST-DG-2041	SITE INVESTIGATION INFORMATION SHEET 2 OF 2	NL3-BGE-210-ST-DG-2375	BARRIER SECTIONS AND DETAILS	
NL3-BGE-210-ST-DG-2050	GEOMETRIC DATA	NL3-BGE-210-ST-DG-2380	PRECAST PANEL PLANS AND ELEVATIONS – SHEET 1	
NE3-DUE-210-31-DU-2030	deometric data	NL3-BGE-210-ST-DG-2381	PRECAST PANEL PLANS AND ELEVATIONS - SHEET 2	
SUB-STRUCTURE			FRECAST FAMEL FEARS AND LEVATIONS - SHELT Z	
NL3-BGE-210-ST-DG-2080	ABUTMENT N° 1 MSE WALL PLAN AND ELEVATION	NL3-BGE-210-ST-DG-2385	PRECAST PANEL REINFORCEMENT DETAILS	
NL3-BGE-210-ST-DG-2081	ABUTMENT N° 2 MSE WALL PLAN AND ELEVATION			
NL3-BGE-210-ST-DG-2082	ABUTMENT MSE WALL DETAILS	NL3-BGE-210-ST-DG-2395	INSITU BARRIER STITCH ELEVATION AND DETAILS	
NL3-BGE-210-ST-DG-2100	ABUTMENT N° 1 FOOTING CONCRETE PLAN AND SECTIONS	NL3-BGE-210-ST-DG-2400	INSITU TRANSITION BARRIER ELEVATION AND DETAILS	
		NL3-BGE-210-ST-DG-2401	INSITU TRANSITION BARRIER REINFORCEMENT DETAILS	
NL3-BGE-210-ST-DG-2105	ABUTMENT N° 2 FOOTING CONCRETE PLAN AND SECTIONS			
		NL3-BGE-210-ST-DG-2430	SERVICES LAYOUT PLAN AND SECTIONS	
NL3-BGE-210-ST-DG-2110	ABUTMENT N° 1 AND N° 2 FOOTING REINFORCEMENT PLAN AND SECTIONS	NL3-BGE-210-ST-DG-2431	SERVICES SECTION AND DETAILS	
NL3-BGE-210-ST-DG-2115	PRECAST COLUMN FORMER CONCRETE AND REINFORCEMENT DETAILS	NL3-BGE-210-ST-DG-2450	UNDER BRIDGE LIGHTING LAYOUT PLAN AND DETAILS	
NL3-BGE-210-ST-DG-2120	PRECAST COLUMN FORMER INFILL CONCRETE AND REINFORCEMENT DETAILS			
NL3-BGE-210-ST-DG-2125	ABUTMENT N° 1 CAP BEAM CONCRETE PLAN, ELEVATION AND SECTIONS			
NL3-BGE-210-ST-DG-2127	ABUTMENT N° 2 CAP BEAM CONCRETE PLAN, ELEVATION AND SECTIONS			
NL3-BGE-210-ST-DG-2130	ABUTMENT N° 1 AND N° 2 CAPBEAM REINFORCEMENT PLAN AND SECTIONS			
NL3-BGE-210-ST-DG-2190	BEARINGS PLAN AND NOTES			
NL3-BGE-210-ST-DG-2191	BEARINGS SECTIONS AND DETAILS			
SUPER-STRUCTURE				
NL3-BGE-210-ST-DG-2200	PRECAST PLANK LAYOUT PLAN AND DETAILS			
NL3-BGE-210-ST-DG-2210	PRECAST PLANK CONCRETE PLAN AND SECTIONS			
NL3-BGE-210-ST-DG-2220	PRECAST PLANK CONCRETE SECTIONS AND DETAILS			
NL3-BGE-210-ST-DG-2240	PRECAST PLANK PRESTRESS LAYOUT AND NOTES			
NL3-BGE-210-ST-DG-2250	PRECAST PLANK REINFORCEMENT PLAN AND SECTION			
NL3-BGE-210-ST-DG-2260	PRECAST PLANK REINFORCEMENT SECTIONS			
NL3-BGE-210-ST-DG-2270	PRECAST PLANK REINFORCEMENT ABUTMENT & INTERNAL DIAPHRAGMS			
NL3-BGE-210-ST-DG-2300	DECK CONCRETE PLAN AND DETAILS			
NUD DEE 240 ET DE 2240	DECK CONCRETE PLAN AND ELEVATIONS			
NL3-BGE-210-ST-DG-2310 NL3-BGE-210-ST-DG-2311	DECK CONCRETE FEAN AND ELEVATIONS			

										LOCAL AUTHORITY CITY OF SWAN (109) MAIN ROADS RESPONSIBILITY AREA METROPOLITAN / WHEATBELT
						1	1			MRWA DRAWING NUMBER
			METADATA		DRAWN K. TAYLOR 23.02.1	8 Kellogg Brown & Root Pty Ltd			. 1	PROJECT TITLE
_			GROUND SURVEY STANDARD: 67-08-43	Perth Office—	DESIGNED J. JAMESON 23.02.1				mainroads	NORTHLINK WA STAGE 3
		-	DATE OF CAPTURE:	484 Murray St, Perth WA 6000			CDD		WESTERN AUSTRALIA	DRAWING TITLE
			MAPPING SURVEY STANDARD: 67-08-43	P7+61 8 6364 3300	CHECKED P. THOMPSON 23.02.1	 Level 15, 300 Murray St, Perth 	CPB			TONKIN HIGHWAY H017 (15.76 SLK) BRIDGE N° 1802 OVER STOCK ROAD WEST INTERCHANGE
0	ISSUED FOR CONSTRUCTION	PDT 10.04.18	DATE OF CAPTURE:	E / info@bgeeng.com bgeeng.com	APPROVED C. RAMM 20.03.1	Western Australia 6000	CONTRACTORS	INFRASTRUCTURE DELIV		INDEX SHEET
No			MAIN ROADS PROJECT ZONE: PCG94	bgeeng.com	DRAWING STATUS	R. DENHAM	PROJECT S. NICOLAY 27.03.18	PROJECT Y. SIDDIQUI	28.03.18	1
NU.	AMENDMENTS		HEIGHT DATUM: AHD	BG&E DOC No: P17077	IFC	26.03.18		DATE MANAGER PROJECT R. ARNOTT DATE DRECTOR R. ARNOTT	29.03.18 DATE	NL3-BGE-210-ST-DG-2001
	. The Brief of States of S	1	,		- · · -	DATE	MANAGER	DATE UNECTOR	DATE	•

REFERENCE DRAWINGS


21-6 LUMINAIRE SUPPORT BRACKET AND COVER PLATE DETAILS

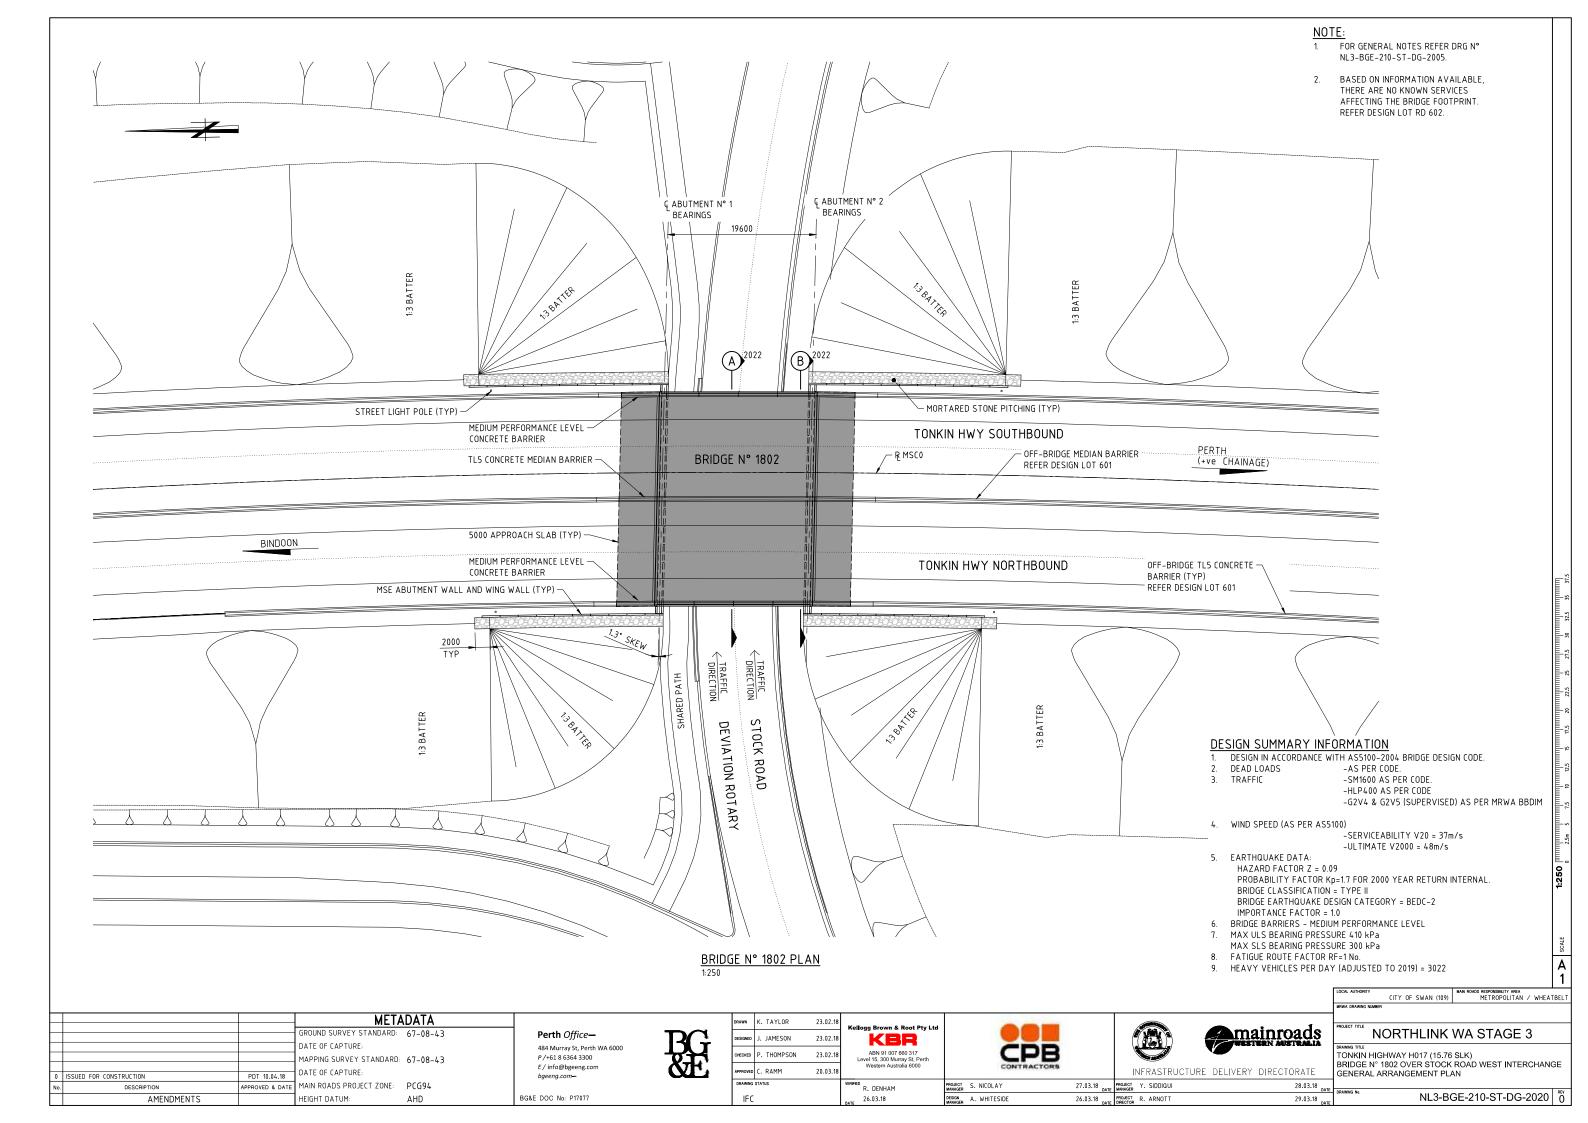

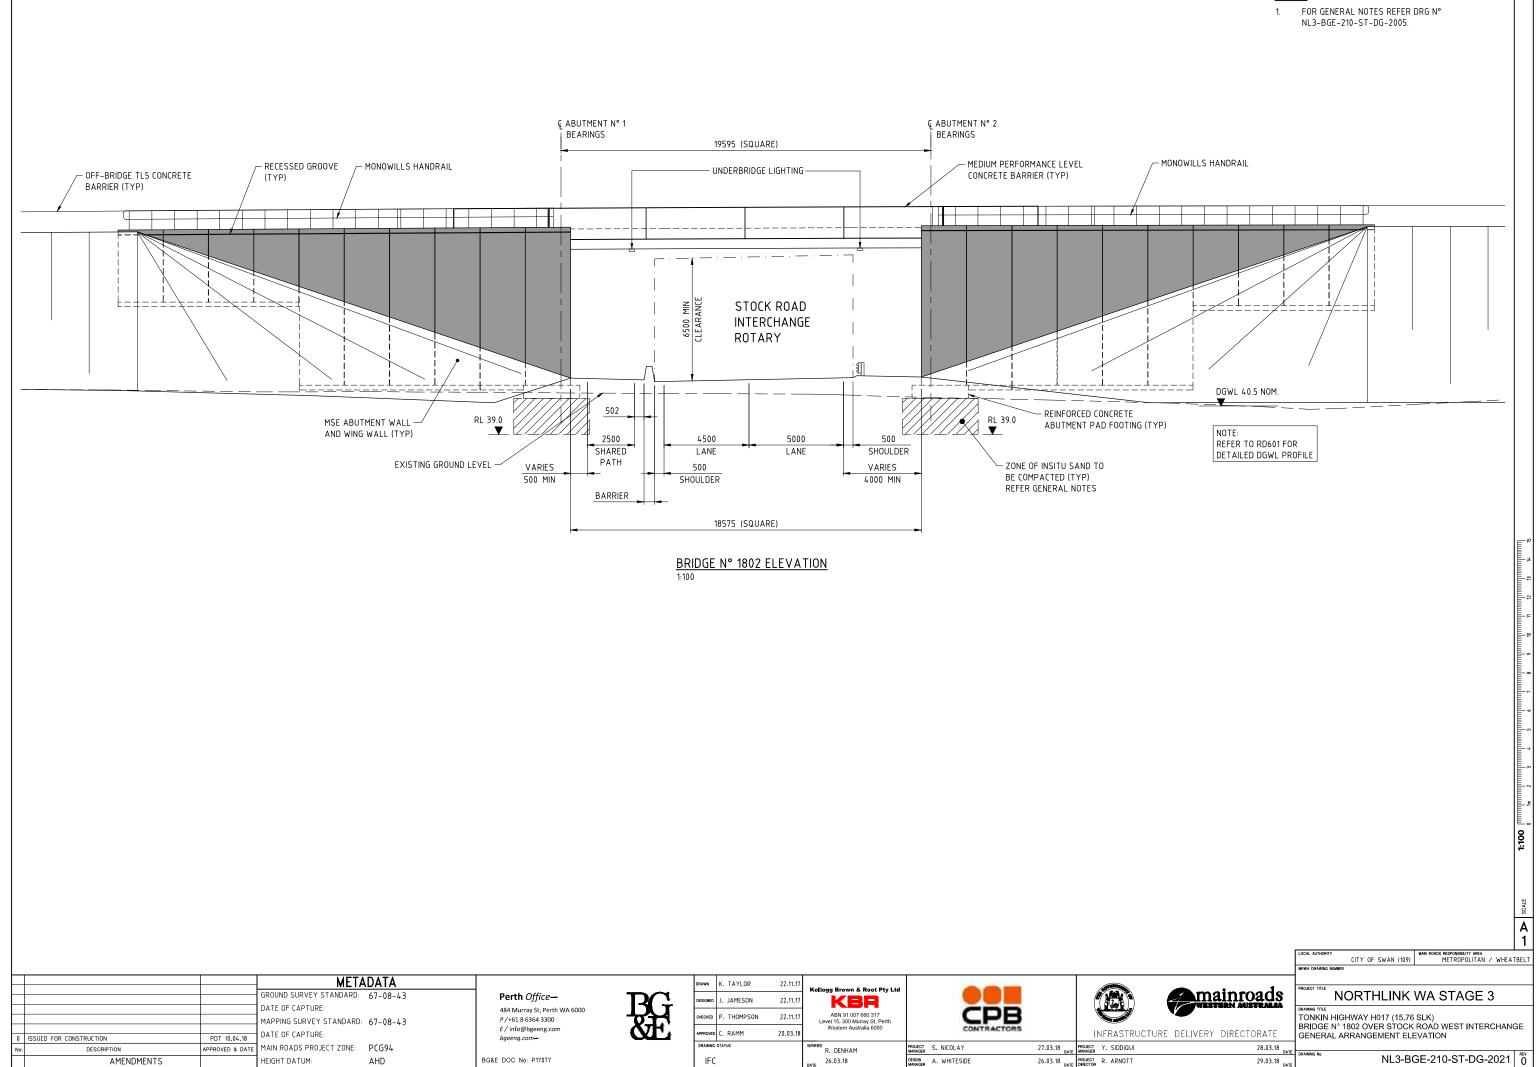

			META	ADATA			DRAWN K. TAYLOR	22.11.17	Kellogg Brown & Root Pty Ltd			
-			GROUND SURVEY STANDARD:	67-08-43	Perth Office-	DC	DESIGNED J. JAMESON	22.11.17				
			DATE OF CAPTURE:		484 Murray St, Perth WA 6000	DU	CHECKED P. THOMPSON	22.11.17	ABN 91 007 660 317	CDP		
			MAPPING SURVEY STANDARD:	67-08-43	P / +61 8 6364 3300 E / info@bgeeng.com	<u>አ</u> ተ			Level 15, 300 Murray St, Perth Western Australia 6000	CONTRACTORS		
0	D ISSUED FOR CONSTRUCTION	PDT 10.04.18	DATE OF CAPTURE:		bgeeng.com-	ŎĿ	APPROVED C. RAMM	20.03.18				INFRASTRUC
N	0. DESCRIPTION	APPROVED & DATE	MAIN ROADS PROJECT ZONE:	PCG94			DRAWING STATUS		R. DENHAM	PROJECT S. NICOLAY	27.03.18 DATE	PROJECT Y. SIDDIQUI
	AMENDMENTS		HEIGHT DATUM:	AHD	BG&E DOC No: P17077		IFC		26.03.18	DESIGN A. WHITESIDE	26.03.18	PROJECT R. ARNOTT


NOTE:

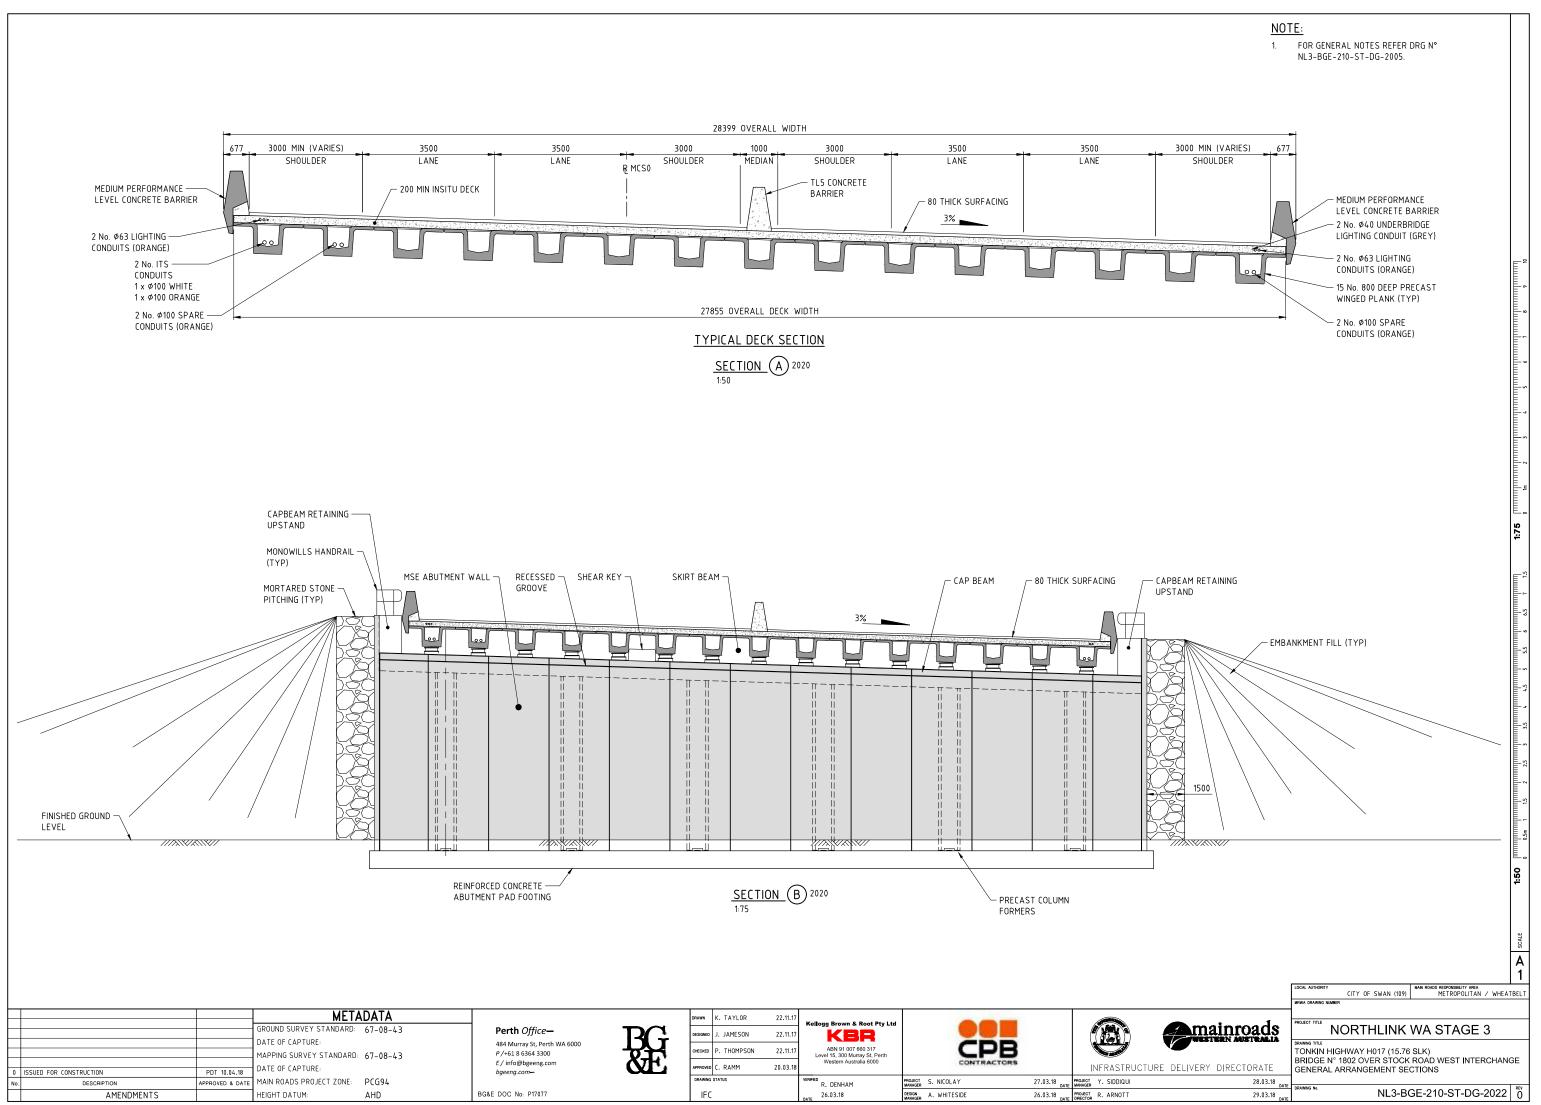

NL 3-BGE-211-ST-DG-1001 NL 3-BGE-211-ST-DG-1005 NL 3-BGE-211-ST-DG-1010 NL 3-BGE-211-ST-DG-1011 NL 3-BGE-211-ST-DG-1012 NL 3-BGE-211-ST-DG-1020 NL 3-BGE-211-ST-DG-1021	DRAWING TITLE COVER SHEET INDEX SHEET GENERAL NOTES DESIGN SUMMARY SHEET 1 OF 3 DESIGN SUMMARY SHEET 2 OF 3 DESIGN SUMMARY SHEET 3 OF 3 GENERAL ARRANGEMENT PLAN GENERAL ARRANGEMENT SECTIONS SITE INVESTIGATION INFORMATION SHEET 1 OF 1
NL3-BGE-211-ST-DG-1000 NL3-BGE-211-ST-DG-1001 NL3-BGE-211-ST-DG-1005 NL3-BGE-211-ST-DG-1010 NL3-BGE-211-ST-DG-1011 NL3-BGE-211-ST-DG-1020 NL3-BGE-211-ST-DG-1021	INDEX SHEET GENERAL NOTES DESIGN SUMMARY SHEET 1 OF 3 DESIGN SUMMARY SHEET 2 OF 3 DESIGN SUMMARY SHEET 3 OF 3 GENERAL ARRANGEMENT PLAN GENERAL ARRANGEMENT SECTIONS
NL3-BGE-211-ST-DG-1001 NL3-BGE-211-ST-DG-1005 NL3-BGE-211-ST-DG-1010 NL3-BGE-211-ST-DG-1011 NL3-BGE-211-ST-DG-1012 NL3-BGE-211-ST-DG-1020 NL3-BGE-211-ST-DG-1021	INDEX SHEET GENERAL NOTES DESIGN SUMMARY SHEET 1 OF 3 DESIGN SUMMARY SHEET 2 OF 3 DESIGN SUMMARY SHEET 3 OF 3 GENERAL ARRANGEMENT PLAN GENERAL ARRANGEMENT SECTIONS
NL3-BGE-211-ST-DG-1001 NL3-BGE-211-ST-DG-1005 NL3-BGE-211-ST-DG-1010 NL3-BGE-211-ST-DG-1011 NL3-BGE-211-ST-DG-1012 NL3-BGE-211-ST-DG-1020 NL3-BGE-211-ST-DG-1021 NL3-BGE-211-ST-DG-1040	GENERAL NOTES DESIGN SUMMARY SHEET 1 OF 3 DESIGN SUMMARY SHEET 2 OF 3 DESIGN SUMMARY SHEET 3 OF 3 GENERAL ARRANGEMENT PLAN GENERAL ARRANGEMENT SECTIONS
NL 3-BGE-211-ST-DG-1010 NL 3-BGE-211-ST-DG-1011 NL 3-BGE-211-ST-DG-1012 NL 3-BGE-211-ST-DG-1020 NL 3-BGE-211-ST-DG-1021	DESIGN SUMMARY SHEET 1 OF 3 DESIGN SUMMARY SHEET 2 OF 3 DESIGN SUMMARY SHEET 3 OF 3 GENERAL ARRANGEMENT PLAN GENERAL ARRANGEMENT SECTIONS
NL3-BGE-211-ST-DG-1011 NL3-BGE-211-ST-DG-1012 NL3-BGE-211-ST-DG-1020 NL3-BGE-211-ST-DG-1021	DESIGN SUMMARY SHEET 2 OF 3 DESIGN SUMMARY SHEET 3 OF 3 GENERAL ARRANGEMENT PLAN GENERAL ARRANGEMENT SECTIONS
NL 3-BGE-211-ST-DG-1012 NL 3-BGE-211-ST-DG-1020 NL 3-BGE-211-ST-DG-1021	DESIGN SUMMARY SHEET 3 OF 3 GENERAL ARRANGEMENT PLAN GENERAL ARRANGEMENT SECTIONS
NL3-BGE-211-ST-DG-1020 NL3-BGE-211-ST-DG-1021	GENERAL ARRANGEMENT PLAN GENERAL ARRANGEMENT SECTIONS
NL3-BGE-211-ST-DG-1021	GENERAL ARRANGEMENT SECTIONS
NI 3-BGE-211-ST-DG-1040	SITE INVESTIGATION INFORMATION SHEET 1 OF 1
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NL3-BGE-211-ST-DG-1081	FOOTING CONCRETE DETAILS SHEET 2
NL3-BGE-211-ST-DG-1082	FOOTING REINFORCEMENT DETAILS SHEET 1
NL3-BGE-211-ST-DG-1083	FOOTING REINFORCEMENT DETAILS SHEET 2
NL3-BGE-211-ST-DG-1100	PRECAST TRAPEZOIDAL UNIT LAYOUT
NL3-BGE-211-ST-DG-1101	PRECAST TRAPEZOIDAL UNIT ASSEMBLY DETAILS
NL3-BGE-211-ST-DG-1105	PRECAST TRAPEZOIDAL UNIT CONCRETE DETAILS
NL3-BGE-211-ST-DG-1110	PRECAST TRAPEZOIDAL UNIT REINFORCEMENT DETAILS SHE
NL3-BGE-211-ST-DG-1111	PRECAST TRAPEZOIDAL UNIT REINFORCEMENT DETAILS SHE
NL3-BGE-211-ST-DG-1112	PRECAST TRAPEZOIDAL UNIT REINFORCEMENT DETAILS SHE
NL3-BGE-211-ST-DG-1120	PRECAST SPANDREL WALL LAYOUT
NL3-BGE-211-ST-DG-1121	PRECAST SPANDREL WALL ASSEMBLY DETAILS SHEET 1
NL3-BGE-211-ST-DG-1122	PRECAST SPANDREL WALL ASSEMBLY DETAILS SHEET 2
NL3-BGE-211-ST-DG-1125	PRECAST SPANDREL WALL 1 CONCRETE DETAILS
NL3-BGE-211-ST-DG-1126	PRECAST SPANDREL WALL 2 CONCRETE DETAILS
NL3-BGE-211-ST-DG-1127	PRECAST SPANDREL WALL 3 CONCRETE DETAILS
NL3-BGE-211-ST-DG-1128	PRECAST SPANDREL WALL 4 CONCRETE DETAILS
NL3-BGE-211-ST-DG-1130	PRECAST SPANDREL WALL REINFORCEMENT DETAILS SHEET
NL3-BGE-211-ST-DG-1131	PRECAST SPANDREL WALL REINFORCEMENT DETAILS SHEET
NL3-BGE-211-ST-DG-1135	PRECAST SPANDREL WALL INSTALLATION BRACKET DETAIL
NL3-BGE-211-ST-DG-1150	SKYLIGHT PLAN
NL3-BGE-211-ST-DG-1151	SKYLIGHT DETAILS
NL3-BGE-211-ST-DG-1160	PRECAST WINGWALL AND RETAINING WALL LAYOUT PLAN
NL3-BGE-211-ST-DG-1161	PRECAST WINGWALL AND RETAINING WALL ELEVATIONS
NL3-BGE-211-ST-DG-1165	PRECAST WINGWALL AND RETAINING WALL ASSEMBLY DET/
NC3-DUL-211-31-DU-1103	SHEET 1
NL3-BGE-211-ST-DG-1166	PRECAST WINGWALL AND RETAINING WALL ASSEMBLY DET/ SHEET 2
NL3-BGE-211-ST-DG-1175	PRECAST RETAINING WALL REINFORCEMENT DETAILS
NL3-BGE-211-ST-DG-1176	PRECAST WINGWALL REINFORCEMENT DETAILS SHEET 1
NL3-BGE-211-ST-DG-1177	PRECAST WINGWALL REINFORCEMENT DETAILS SHEET 2


		MET GROUND SURVEY STANDARD:	ADATA 67-08-43	Perth Office—			K. TAYLOR	23.02.18	Kellogg Brown & Root Pty Ltd				
0	ISSUED FOR CONSTRUCTION	DATE OF CAPTURE: MAPPING SURVEY STANDARD: DATE OF CAPTURE:		484 Murray St, Perth WA 6000 P/+61 8 6364 3300 E / info@bgeeng.com bgeeng.com	BC j	CHECKED	C.KANDANARAC P. THOMPSON P. THOMPSON	23.02.18 23.02.18 12.04.18	ABN 91 007 660 317 Level 15, 300 Murray St, Perth Western Australia 6000				NFRASTRUCTURE
No.		MAIN ROADS PROJECT ZONE:	PCG94			DRAWING ST	STATUS		R. DENHAM	PROJECT S. NICOLAY	17.04.18 DAT	PROJECT MANAGER	Y. SIDDIQUI
	AMENDMENTS	HEIGHT DATUM:	AHD	BG&E DOC No: P17077		IFC			16.04.18 DATE	DESIGN A. WHITESIDE	17.04.18 DATE	PROJECT DIRECTOR	R. ARNOTT

		A 1
	LOCAL AUTHORITY CITY OF SWAN (109)	MAIN ROADS RESPONSIBILITY AREA METROPOLITAN / WHEATBELT
	MRWA DRAWING NUMBER	
mainroads		WA STAGE 3
RE DELIVERY DIRECTORATE	DRAWING TITLE TONKIN HIGHWAY H017 UNDERPASS N° 9438 UNDER S INDEX SHEET	STOCK ROAD WEST
19.04.18 DATE	DRAWING No.	
19.04.18	NL3-B	GE-211-ST-DG-1001 ີດໍ

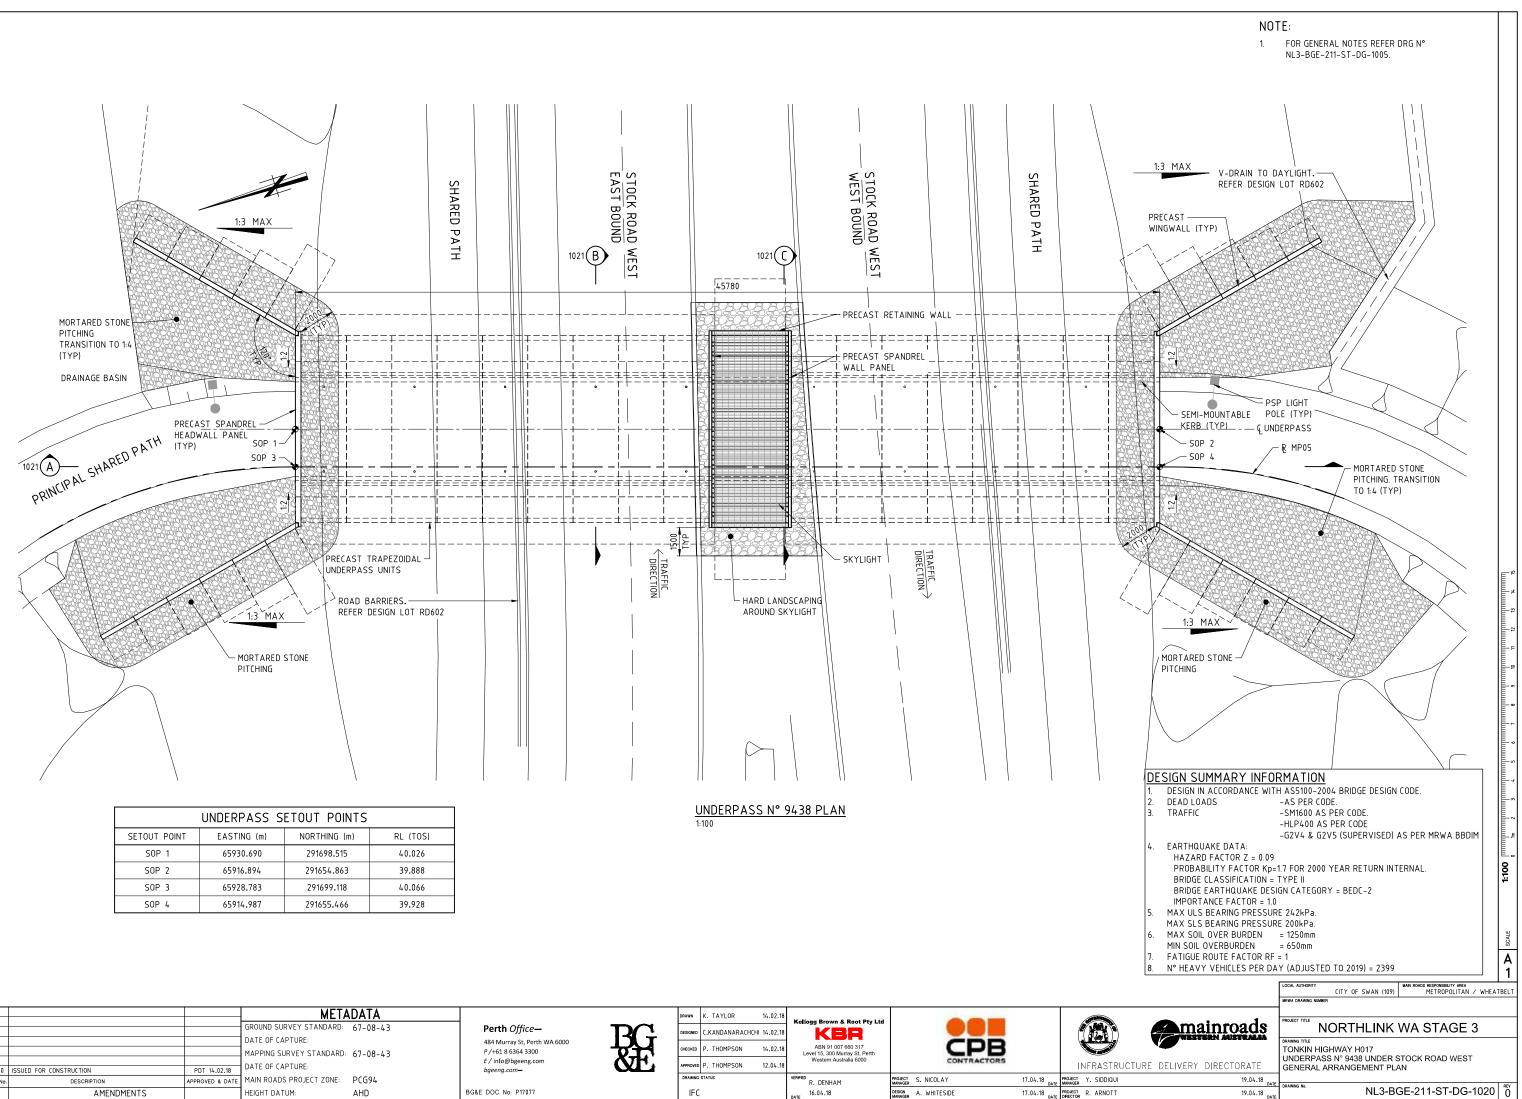

UNDERPASS SETOUT POINTS								
SETOUT POINT	EASTING (m)	RL (TOS)						
SOP 1	65930.690	291698.515	40.026					
SOP 2	65916.894	291654.863	39.888					
SOP 3	65928.783	291699.118	40.066					
SOP 4	65914.987	291655.466	39.928					

	METADATA		DRAWN K. TAYLOR 14.02.18				
	GROUND SURVEY STANDARD: 67-08-43	Perth Office—	DESIGNED C.KANDANARACHCHI 14.02.18	Kellogg Brown & Root Pty Ltd			
	DATE OF CAPTURE:	484 Murray St, Perth WA 6000		ABN 91 007 660 317	CPB		
	MAPPING SURVEY STANDARD: 67-08-43	P/+61 8 6364 3300	CHECKED P. THOMPSON 14.02.18	Level 15, 300 Murray St, Perth Western Australia 6000			
0 ISSUED FOR CONSTRUCTION PDT 14.02.18	DATE OF CAPTURE:	E / info@bgeeng.com bgeeng.com	APPROVED P. THOMPSON 12.04.18	Western Australia 6000	CONTRACTORS		INFRASTRUCTU
	MAIN ROADS PROJECT ZONE: PCG94		DRAWING STATUS	R. DENHAM	PROJECT S. NICOLAY	17.04.18 DATE	PROJECT Y. SIDDIQUI
AMENDMENTS	HEIGHT DATUM: AHD	BG&E DOC No: P17077	IFC	DATE 16.04.18	DESIGN A. WHITESIDE	17.04.18 _{date}	PROJECT R. ARNOTT DRECTOR

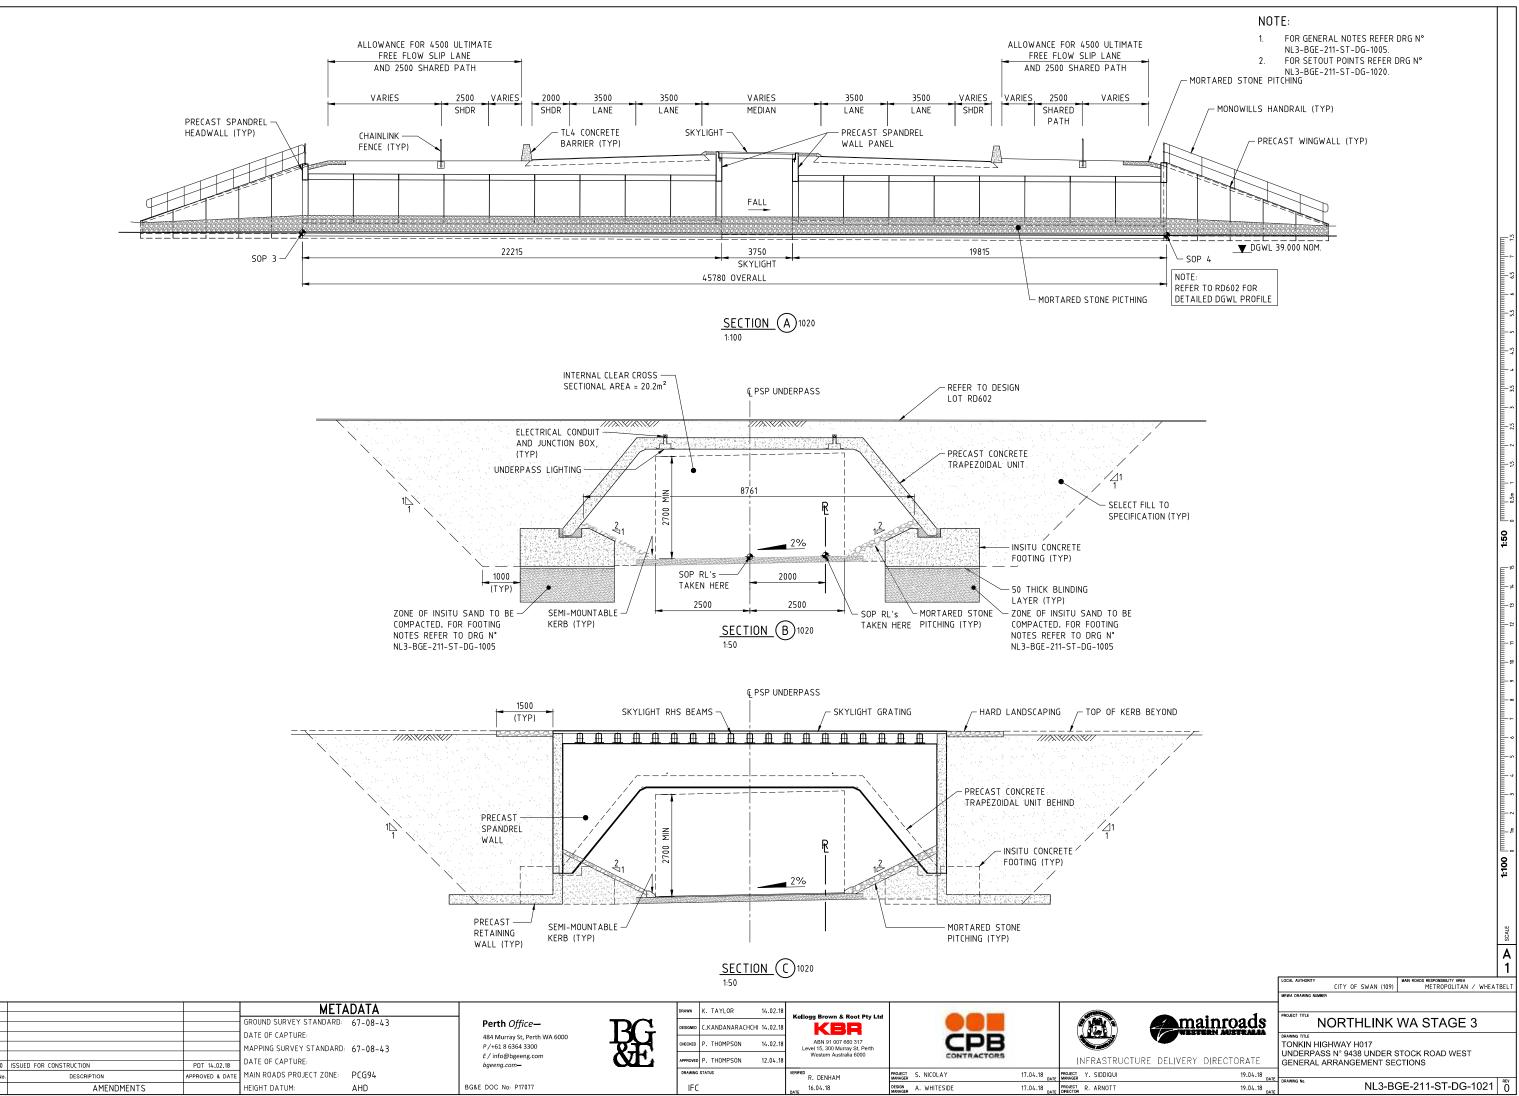


NORTHLINK STAGE 3 DRAWING INDEX				
<u>DRG N°</u>	DRAWING TITLE	<u>DRG N°</u>	DRAWING TITLE	
GENERAL		SUPER-STRUCTURE (CON'T)		MRWA F
NL3-BGE-220-ST-DG-1000	COVER SHEET			9230-0921-
NL3-BGE-220-ST-DG-1001	INDEX SHEET	NL3-BGE-220-ST-DG-1310	DECK CONCRETE PLANS AND ELEVATION	
		NL3-BGE-220-ST-DG-1311	DECK CONCRETE SECTIONS AND DETAILS	
NL3-BGE-220-ST-DG-1005	GENERAL NOTES	NL3-BGE-220-ST-DG-1315	DECK REINFORCEMENT PLAN	
NL3-BGE-220-ST-DG-1008	CONSTRUCTION NOTES			
		NL3-BGE-220-ST-DG-1320	DECK REINFORCEMENT ELEVATION	
NL3-BGE-220-ST-DG-1010	DESIGN SUMMARY SHEET 1 OF 3			
NL3-BGE-220-ST-DG-1011 NL3-BGE-220-ST-DG-1012	DESIGN SUMMARY SHEET 2 OF 3 DESIGN SUMMARY SHEET 3 OF 3	NL3-BGE-220-ST-DG-1330	DECK REINFORCEMENT SECTIONS AND DETAILS	
NES-DGE-220-31-DG-1012		NL3-BGE-220-ST-DG-1340	DECK WATERPROOFING PLAN AND DETAILS	
NL3-BGE-220-ST-DG-1020	GENERAL ARRANGEMENT PLAN			
NL3-BGE-220-ST-DG-1021	GENERAL ARRANGEMENT ELEVATION	NL3-BGE-220-ST-DG-1350	APPROACH SLAB CONCRETE PLAN AND DETAILS	
NL3-BGE-220-ST-DG-1022	GENERAL ARRANGEMENT SECTIONS	NL3-BGE-220-ST-DG-1355	APPROACH SLAB REINFORCEMENT PLAN AND SECTIONS	
NL3-BGE-220-ST-DG-1040	SITE INVESTIGATION INFORMATION SHEET 1 OF 2	NL3-DUE-220-51-DU-1555	APPROACH SLAD REINFORCEMENT PLAN AND SECTIONS	
NL3-BGE-220-ST-DG-1041	SITE INVESTIGATION INFORMATION SHEET 2 OF 2	NL3-BGE-220-ST-DG-1360	EXPANSION JOINT PLAN AND SECTIONS	
NL3-BGE-220-ST-DG-1050	GEOMETRIC DATA	NL3-BGE-220-ST-DG-1365	COVER PLATE PLAN AND SECTIONS	
SUB-STRUCTURE		NL3-BGE-220-ST-DG-1366	COVER PLATE DETAILS	
NL3-BGE-220-ST-DG-1080	ABUTMENT N° 1 MSE WALL PLAN AND ELEVATION	NL3-BGE-220-ST-DG-1370	BARRIER LAYOUT PLAN AND DETAILS	
NL3-BGE-220-ST-DG-1081	ABUTMENT N° 2 MSE WALL PLAN AND ELEVATION			
NL3-BGE-220-ST-DG-1082	ABUTMENT MSE WALL DETAILS	NL3-BGE-220-ST-DG-1375	BARRIER SECTIONS AND DETAILS	
NL3-BGE-220-ST-DG-1100	ABUTMENT N° 1 FOOTING CONCRETE PLAN AND SECTIONS	NL3-BGE-220-ST-DG-1380	PRECAST PANEL PLANS AND ELEVATIONS - SHEET 1	
NES-DOL-220-31-DO-1100	ADDITIENT NOTING CONCILETERN AND SECTIONS	NL3-BGE-220-ST-DG-1381	PRECAST PANEL PLANS AND ELEVATIONS - SHEET 2	
NL3-BGE-220-ST-DG-1105	ABUTMENT N° 2 FOOTING CONCRETE PLAN AND SECTIONS	NL3-BGE-220-ST-DG-1382	PRECAST PANEL PLANS AND ELEVATIONS - SHEET 3	
NL3-BGE-220-ST-DG-1110	ABUTMENT N° 1 AND N° 2 FOOTING REINFORCEMENT PLAN AND SECTIONS	NL3-BGE-220-ST-DG-1385	PRECAST PANEL REINFORCEMENT DETAILS	
NL3-BGE-220-ST-DG-1115	PRECAST COLUMN FORMER CONCRETE AND REINFORCEMENT DETAILS	NL3-BGE-220-ST-DG-1395	INSITU BARRIER STITCH ELEVATION AND DETAILS	
NL3-BGE-220-ST-DG-1120	PRECAST COLUMN FORMER INFILL CONCRETE AND REINFORCEMENT DETAILS	NL3-BGE-220-ST-DG-1400	INSITU TRANSITION BARRIER ELEVATION AND DETAILS	
NL3-BGE-220-ST-DG-1125	ABUTMENT N° 1 CAP BEAM CONCRETE PLAN. ELEVATION AND SECTIONS	NL3-BGE-220-ST-DG-1401	INSITU TRANSITION BARRIER REINFORCEMENT DETAILS	
NLJ-DUL-220-31-DU-1125	ADDITIENT NOT CALIBERT CONCILIE FEAN, LEEVATION AND SECTIONS	NL3-BGE-220-ST-DG-1430	SERVICES LAYOUT PLAN AND SECTIONS	
NL3-BGE-220-ST-DG-1127	ABUTMENT N° 2 CAP BEAM CONCRETE PLAN AND ELEVATION	NL3-BGE-220-ST-DG-1431	SERVICES SECTIONS AND DETAILS	
NL3-BGE-220-ST-DG-1130	ABUTMENT N° 1 & N° 2 CAPBEAM REINFORCEMENT PLAN AND SECTIONS	NL3-BGE-220-ST-DG-1450	UNDER BRIDGE LIGHTING LAYOUT PLAN AND DETAILS	
NL3-BGE-220-ST-DG-1190	BEARINGS PLAN AND NOTES			
NL3-BGE-220-ST-DG-1191	BEARINGS SECTIONS AND DETAILS			
SUPER-STRUCTURE				
NL3-BGE-220-ST-DG-1200	PRECAST PLANK LAYOUT PLAN AND DETAILS			
NL3-BGE-220-ST-DG-1210	PRECAST PLANK CONCRETE PLAN AND SECTIONS			
NL3-BGE-220-ST-DG-1220	PRECAST PLANK CONCRETE SECTIONS AND DETAILS			
NL3-BGE-220-ST-DG-1240	PRECAST PLANK PRESTRESS LAYOUT AND NOTES			
NL3-BGE-220-ST-DG-1250	PRECAST PLANK REINFORCEMENT PLAN AND SECTION			
NL3-BGE-220-ST-DG-1260	PRECAST PLANK REINFORCEMENT SECTIONS			
NL3-BGE-220-ST-DG-1270	PRECAST PLANK REINFORCEMENT ABUTMENT & INTERNAL DIAPHRAGMS			
	THEORET FRANK REAL ORCENENT ADOTTERT & INTERNAL DIALTIKADIS			
NL3-BGE-220-ST-DG-1300	DECK CONCRETE PLAN AND DETAILS			

NL3-BGE-220-ST-DG-1300	DE	CK CONCRETE PLAN AND DETAILS											A
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												LOCAL AUTHORITY CITY OF SWAN (109)	MAIN ROADS RESPONSIBILITY AREA METROPOLITAN / WHEATBELT
					_					1		MRWA DRAWING NUMBER	
		METADATA			DRAWN K. TA	YLOR 02.	2.18 Kellogg Brown & Root Pty Ltd				• • 1	PROJECT TITLE	
		GROUND SURVEY STANDARD: 67-08-43	Perth Office—	DC	DESIGNED H. AL	.GUIRE 02.					mainroads	NORTHLINK	WA STAGE 3
		DATE OF CAPTURE:	484 Murray St, Perth WA 6000					CPB			WEETERN AUSTRALIA		
		MAPPING SURVEY STANDARD: 67-08-43	P/+61 8 6364 3300		CHECKED P. TH	IOMPSON 02.	Level 15, 300 Murray St, Perth	CPD			-	TONKIN HIGHWAY H017 (11.17 BRIDGE N° 1793 OVER NEAVE	
0 ISSUED FOR CONSTRUCTION	PDT 10.04.18	DATE OF CAPTURE:	E / info@bgeeng.com bgeeng.com—	Æ	APPROVED C. RA	MM 12.	Western Australia 6000 12.18	CONTRACTORS		INFRASTRUCTU	IRE DELIVERY DIRECTORATE	INDEX SHEET	S ROAD INTERCHANGE
		TE MAIN ROADS PROJECT ZONE: PCG94	bycengieoni		DRAWING STATUS		R. DENHAM	PROJECT S. NICOLAY	15.02.18	PROJECT Y. SIDDIQUI	19.02.18		
AMENDMENTS		HEIGHT DATUM: AHD	BG&E DOC No: P17077		IFC		14.02.18	DESIGN A. WHITESIDE		PROJECT R. ARNOTT	20.02.18	DRAWING NO. NL3-BC	GE-220-ST-DG-1001

A REFERENCE DRAWINGS

921-6 LUMINAIRE SUPPORT BRACKET AND COVER PLATE DETAILS

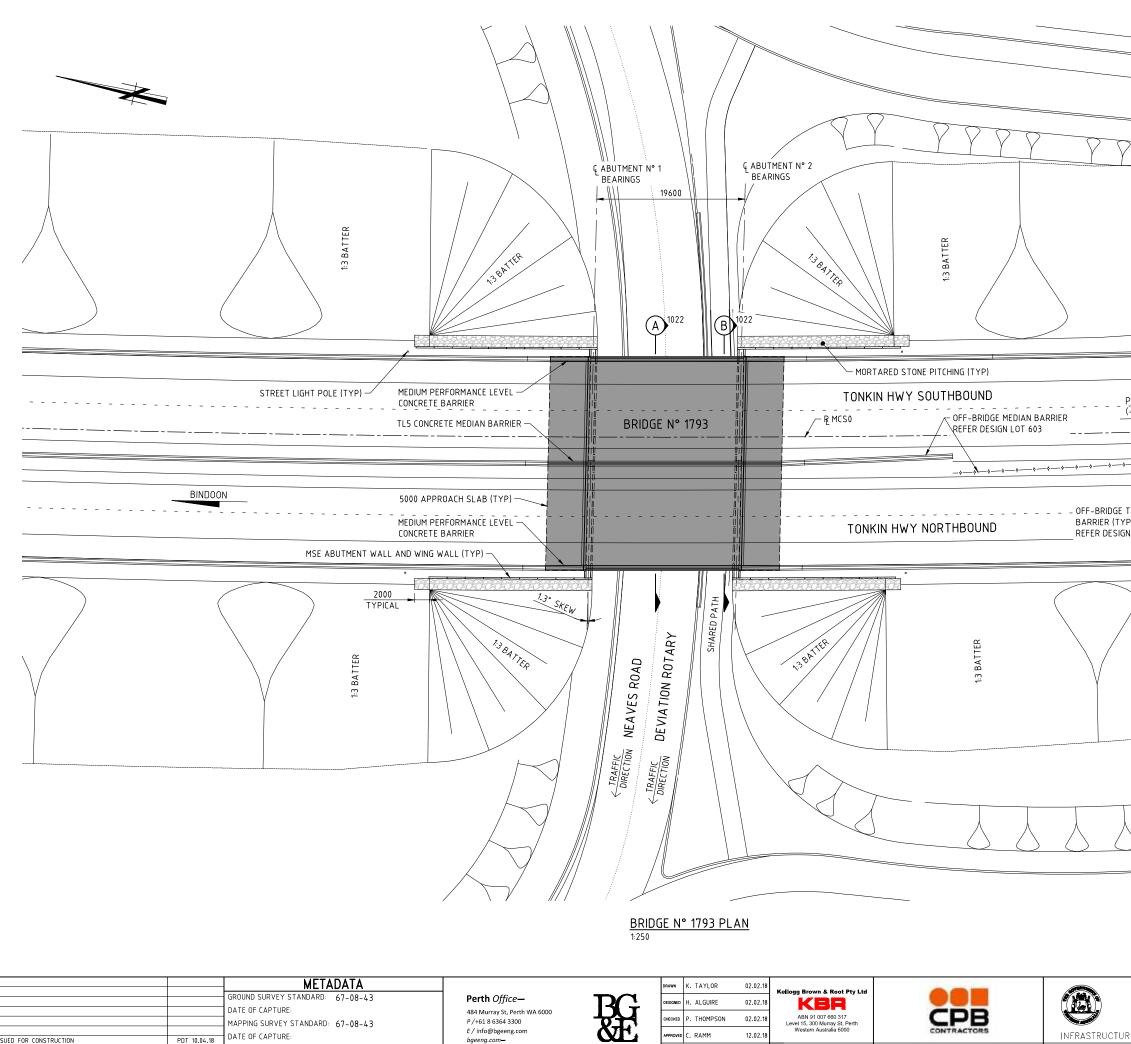

E / info@bgeeng.com

bgeeng.com-

BG&E DOC No: P17077

DATE OF CAPTURE:

HEIGHT DATUM:

APPROVED & DATE MAIN ROADS PROJECT ZONE: PCG94

AHD

PDT 10.04.18

0 ISSUED FOR CONSTRUCTION

DESCRIPTION

AMENDMENTS

PROVED C. RAMM

IFC

12.02.18


R. DENHAM


14.02.18

PROJECT S. NICOLAY MANAGER A. WHITESIDE

15.02.18 DROJECT Y. SIDDIQUI MANAGER Y. SIDDIQUI 15.02.18 DATE PROJECT R. ARNOTT

NOT		
1.	FOR GENERAL NOTES REFER DRG N° NL3-BGE-220-ST-DG-1005.	
2.	BASED ON INFORMATION AVAILABLE, THERE ARE NO KNOWN SERVICES AFFECTING THE BRIDGE FOOTPRINT. REFER DESIGN LOT 603.	
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PERTH		
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OFF-BRIDGE TL5 CONCRETE		
REFER DESIGN LOT 603		шп 37.5
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		mmmm 27.5
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		minim 17.5
DESIGN SUMMARY INFO	ORMATION	12.5 tS
2. DEAD LOADS	ITH AS5100-2004 BRIDGE DESIGN CODE. -AS PER CODE.	2 2 2
3. TRAFFIC	-SM1600 AS PER CODE. -HLP400 AS PER CODE	mmmm 7.5
4. WIND SPEED (AS PER AS5	-G2V4 & G2V5 (SUPERVISED) AS PER MRWA BBDIM	որուուրը 2.5m 5
	-SERVICEABILITY V20 = 37m/s	E.
5. EARTHQUAKE DATA: HAZARD FACTOR Z = 0.0	,	1:250
BRIDGE CLASSIFICATION	p=1.7 FOR 2000 YEAR RETURN INTERNAL. = TYPE II SIGN CATEGORY = BEDC-2	
IMPORTANCE FACTOR = 1 6. BRIDGE BARRIERS - MEDIU	1.0	SCALE
7. MAX ULS BEARING PRESS MAX SLS BEARING PRESS	URE 300 kPa	Å
8. FATIGUE ROUTE FACTOR R 2019) = 2661	Image: Second conduction Image: Second c	1
	MRWA DRAWING NUMBER	JELI
mainroads	PROJECT TITLE NORTHLINK WA STAGE 3	
INFRASTRUCTURE DELIVERY DIRECTORATE	TONKIN HIGHWAY H017 (11.17 SLK) BRIDGE N° 1793 OVER NEAVES ROAD INTERCHANGE GENERAL ARRANGEMENT PLAN	
ST X CIDDIOUI 10.02.19	DRAWING No. NL3-BGE-220-ST-DG-1020	REV 0

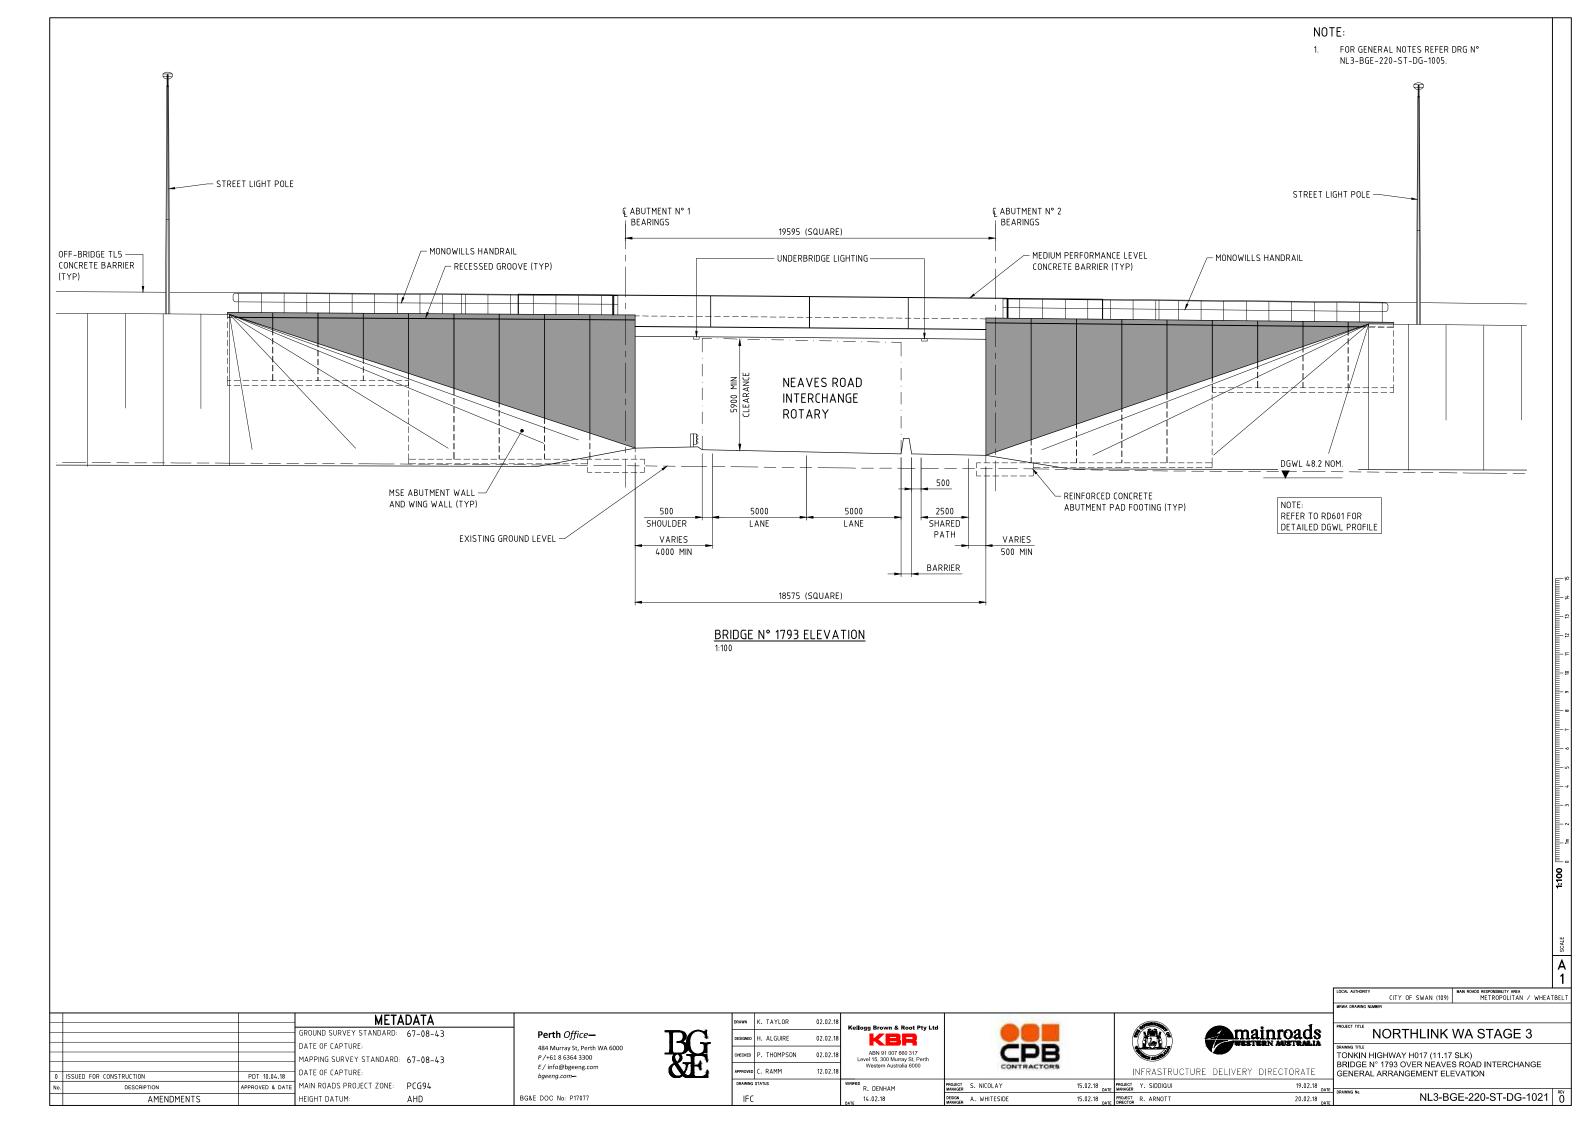

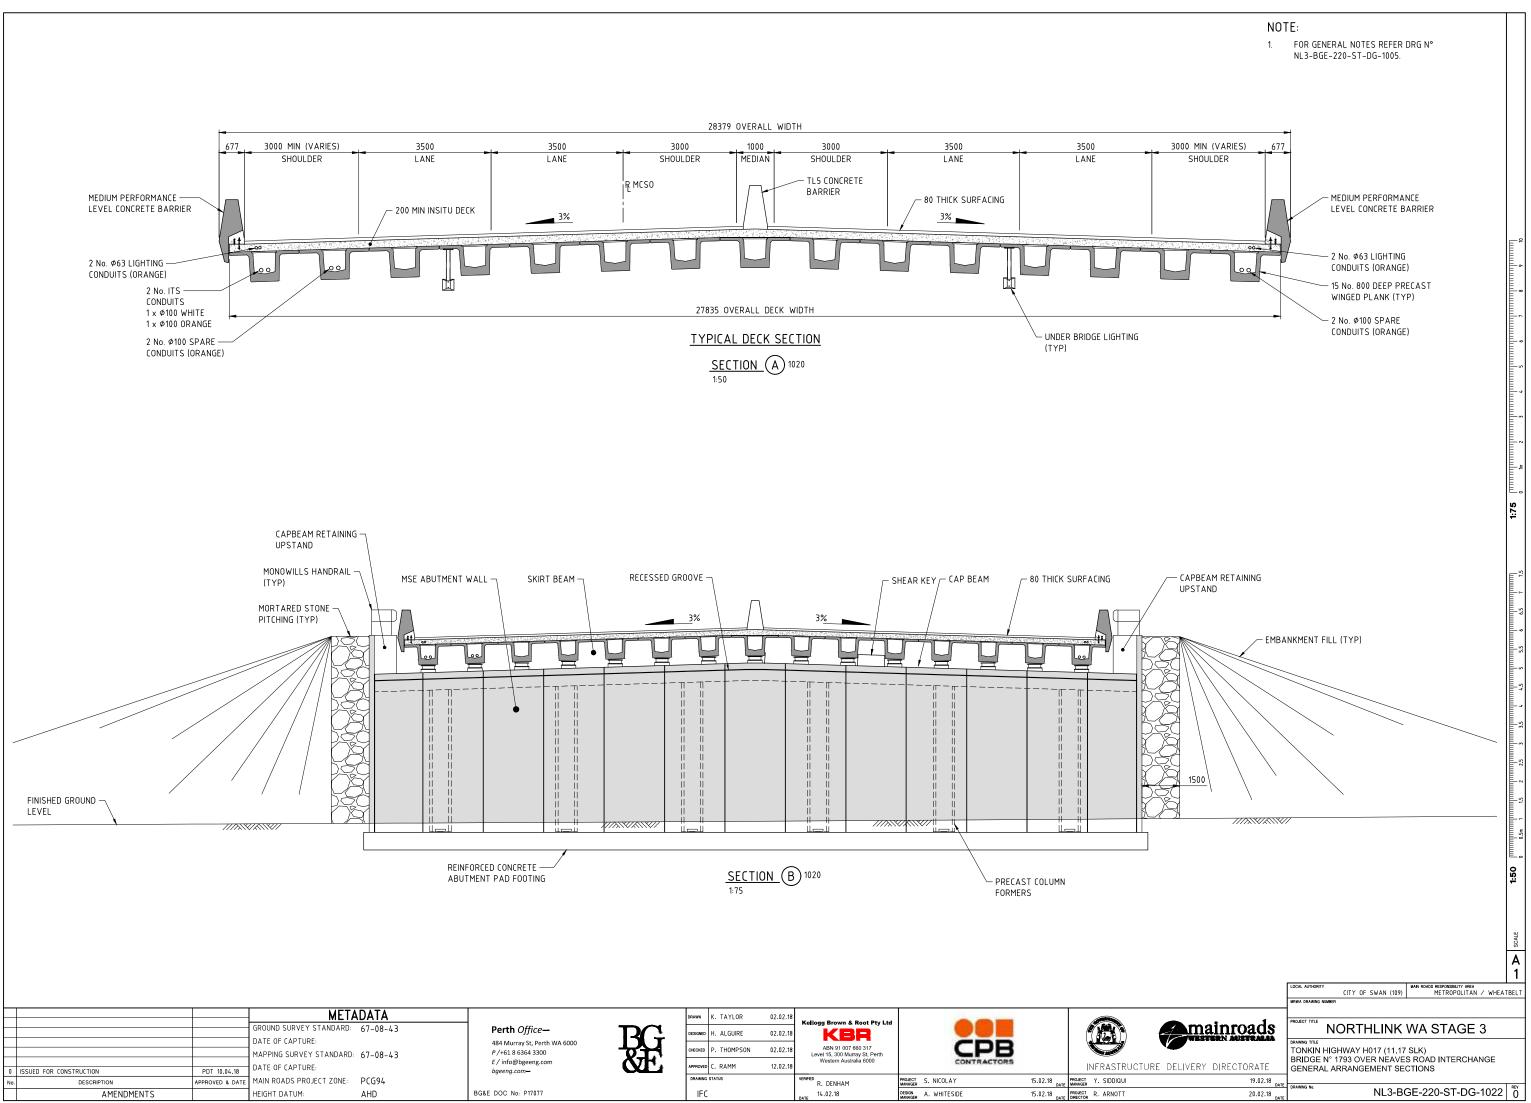


NORTHLINK STAGE 3 DRAWING INDEX				
DRG N°	DRAWING TITLE	<u>DRG N°</u>	DRAWING TITLE	
GENERAL		SUPER-STRUCTURE (CON'T)		MRWA R
NL3-BGE-220-ST-DG-2001	INDEX SHEET	NL3-BGE-220-ST-DG-2315	DECK REINFORCEMENT PLAN	9230-0921-6
		NL3-BGE-220-ST-DG-2320	DECK REINFORCEMENT ELEVATION	
NL3-BGE-220-ST-DG-2005	GENERAL NOTES	NL3-BGE-220-ST-DG-2330	DECK REINFORCEMENT SECTIONS AND DETAILS	
NL3-BGE-220-ST-DG-2008	CONSTRUCTION NOTES	NL3-BGE-220-ST-DG-2340	DECK WATERPROOFING PLAN AND DETAILS	
NL3-BGE-220-ST-DG-2010	DESIGN SUMMARY SHEET 1 OF 3	NL3-BGE-220-ST-DG-2350	APPROACH SLAB CONCRETE PLAN AND DETAILS	
NL3-BGE-220-ST-DG-2011	DESIGN SUMMARY SHEET 2 OF 3			
NL3-BGE-220-ST-DG-2012	DESIGN SUMMARY SHEET 3 OF 3	NL3-BGE-220-ST-DG-2355	APPROACH SLAB REINFORCEMENT PLAN AND SECTIONS	
NL3-BGE-220-ST-DG-2020	GENERAL ARRANGEMENT PLAN	NL3-BGE-220-ST-DG-2360	EXPANSION JOINT PLAN AND SECTIONS	
NL3-BGE-220-ST-DG-2021	GENERAL ARRANGEMENT ELEVATION			
NL3-BGE-220-ST-DG-2022	GENERAL ARRANGEMENT SECTIONS			
		NL3-BGE-220-ST-DG-2365	COVER PLATE PLAN AND SECTIONS	
NL3-BGE-220-ST-DG-2040	SITE INVESTIGATION INFORMATION SHEET 1 OF 2	NL3-BGE-220-ST-DG-2366	COVER PLATE DETAILS	
NL3-BGE-220-ST-DG-2041	SITE INVESTIGATION INFORMATION SHEET 2 OF 2			
		NL3-BGE-220-ST-DG-2370	BARRIER LAYOUT PLAN AND DETAILS	
NL3-BGE-220-ST-DG-2050	GEOMETRIC DATA	NL3-BGE-220-ST-DG-2375	BARRIER SECTIONS AND DETAILS	
SUB-STRUCTURE		NL3-BGE-220-ST-DG-2380	PRECAST PANEL PLANS AND ELEVATIONS - SHEET 1	
NL3-BGE-220-ST-DG-2080	ABUTMENT N° 1 MSE WALL PLAN AND ELEVATION	NL3-BGE-220-ST-DG-2381	PRECAST PANEL PLANS AND ELEVATIONS - SHEET 2	
NL3-BGE-220-ST-DG-2081	ABUTMENT N° 2 MSE WALL PLAN AND ELEVATION	NL3-BGE-220-ST-DG-2382	PRECAST PANEL PLANS AND ELEVATIONS - SHEET 3	
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		NL3-BGE-220-ST-DG-2385	PRECAST PANEL REINFORCEMENT DETAILS	
NL3-BGE-220-ST-DG-2100	ABUTMENT N° 1 FOOTING CONCRETE PLAN AND SECTIONS			
		NL3-BGE-220-ST-DG-2395	INSITU BARRIER STITCH ELEVATION AND DETAILS	
NL3-BGE-220-ST-DG-2105	ABUTMENT N° 2 FOOTING CONCRETE PLAN AND SECTIONS			
		NL3-BGE-220-ST-DG-2400	INSITU TRANSITION BARRIER ELEVATION AND DETAILS	
NL3-BGE-220-ST-DG-2110	ABUTMENT N° 1 AND N° 2 FOOTING REINFORCEMENT PLAN AND SECTIONS	NL3-BGE-220-ST-DG-2401	INSITU TRANSITION BARRIER REINFORCEMENT DETAILS	
NL3-BGE-220-ST-DG-2115	PRECAST COLUMN FORMER CONCRETE AND REINFORCEMENT DETAILS	NL3-BGE-220-ST-DG-2430	SERVICES LAYOUT PLAN AND SECTIONS	
		NL3-BGE-220-ST-DG-2431	SERVICES SECTIONS AND DETAILS	
NL3-BGE-220-ST-DG-2120	PRECAST COLUMN FORMER INFILL CONCRETE AND REINFORCEMENT DETAILS			
		NL3-BGE-220-ST-DG-2450	UNDER BRIDGE LIGHTING LAYOUT PLAN AND DETAILS	
NL3-BGE-220-ST-DG-2125	ABUTMENT N° 1 CAP BEAM CONCRETE PLAN, ELEVATION AND SECTIONS			
NL3-BGE-220-ST-DG-2127	ABUTMENT N° 2 CAP BEAM CONCRETE PLAN AND ELEVATION			
NL3-BGE-220-ST-DG-2130	ABUTMENT N° 1 AND N° 2 CAP BEAM REINFORCEMENT PLAN AND SECTIONS			
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NL3-BGE-220-ST-DG-2191	BEARINGS SECTIONS AND DETAILS			
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NL3-BGE-220-ST-DG-2210 NL3-BGE-220-ST-DG-2220	PRECAST PLANK CONCRETE PLAN AND SECTIONS PRECAST PLANK CONCRETE SECTIONS AND DETAILS			
NC3-DQC-220-31-DQ-2220	FREEAST FLANK CONCRETE SECTIONS AND DETAILS			
NL3-BGE-220-ST-DG-2240	PRECAST PLANK PRESTRESS LAYOUT AND NOTES			
NL3-BGE-220-ST-DG-2250	PRECAST PLANK REINFORCEMENT PLAN AND SECTION			
NL3-BGE-220-ST-DG-2260	PRECAST PLANK REINFORCEMENT SECTIONS			
NL3-BGE-220-ST-DG-2270	PRECAST PLANK REINFORCEMENT ABUTMENT & INTERNAL DIAPHRAGMS			
NL3-BGE-220-ST-DG-2300	DECK CONCRETE PLAN AND DETAILS			
	DECK CONCRETE PLANS AND ELEVATION			
NL3-BGE-220-ST-DG-2310	DECK CONCRETE LEANS AND LEEVATION			


						A
						1
						LOCAL AUTHORITY CITY OF SWAN (109) MAIN ROADS RESPONSIBILITY AREA METROPOLITAN / WHEATBELT
			1		1	MRWA DRAWING NUMBER
METADATA		DRAWN K. TAYLOR 07.02.	18 Kellogg Brown & Root Pty Ltd			PROJECT TITLE
GROUND SURVEY STANDARD: 67-08-4	Berth Office—	DESIGNED H. ALGUIRE 07.02.			mainroads	NORTHLINK WA STAGE 3
DATE OF CAPTURE:	484 Murray St, Perth WA 6000			CDD	WESTERN AUSTRALIA	DRAWING TITLE
MAPPING SURVEY STANDARD: 67-08-4	P /+61 8 6364 3300 E / info@bgeeng.com bgeeng.com-	CHECKED P. THOMPSON 07.02.	Level 15, 300 Murray St, Perth	CPB		TONKIN HIGHWAY H017 (11.04 SLK)
0 ISSUED FOR CONSTRUCTION PDT 10.04.18 DATE OF CAPTURE:	E / info@bgeeng.com	APPROVED C. RAMM 14.02.	Western Australia 6000 18	CONTRACTORS	INFRASTRUCTURE DELIVERY DIRECTORATE	BRIDGE N° 1794 OVER NEAVES ROAD INTERCHANGE INDEX SHEET
No. DESCRIPTION APPROVED & DATE MAIN ROADS PROJECT ZONE: PCG94	bgeeng.com-	DRAWING STATUS	VERIFIED R. DENHAM	PROJECT S. NICOLAY 23.02.18	PROJECT Y. SIDDIQUI 26.02.18	
AMENDMENTS HEIGHT DATUM: AHD	BG&E DOC No: P17077	IFC	20.02.18	MARAGER D	PROJECT R. ARNOTT 27.02.18	NL3-BGE-220-ST-DG-2001


REFERENCE DRAWINGS

21-6 LUMINAIRE SUPPORT BRACKET AND COVER PLATE DETAILS

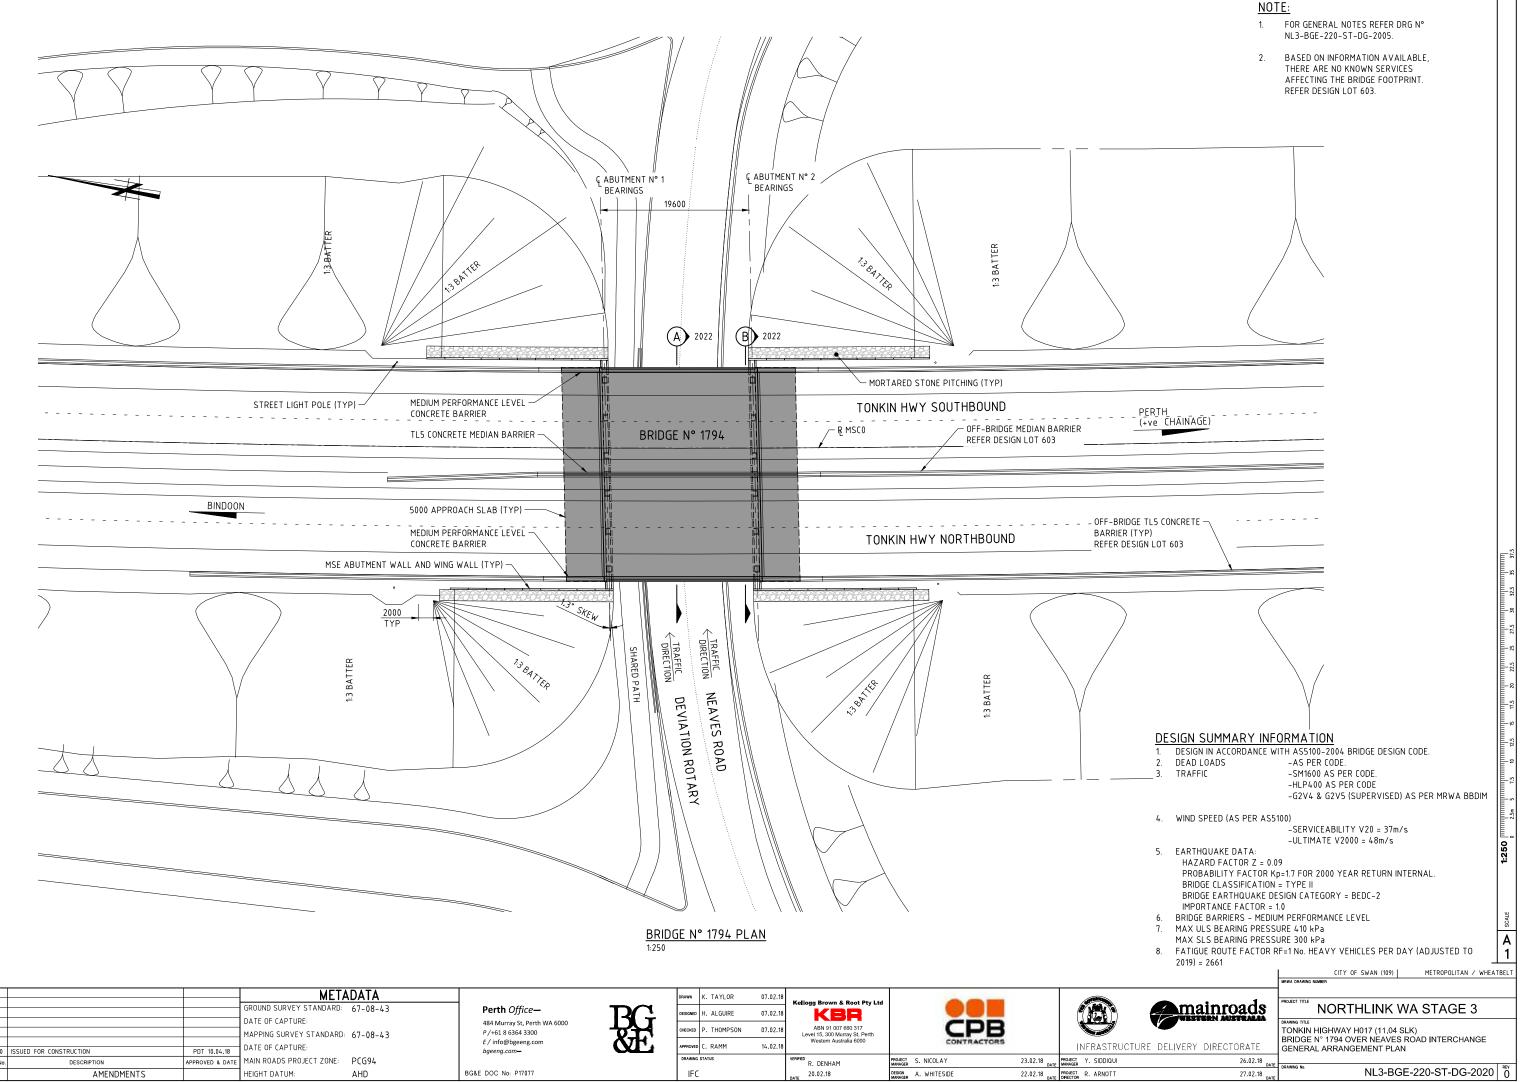



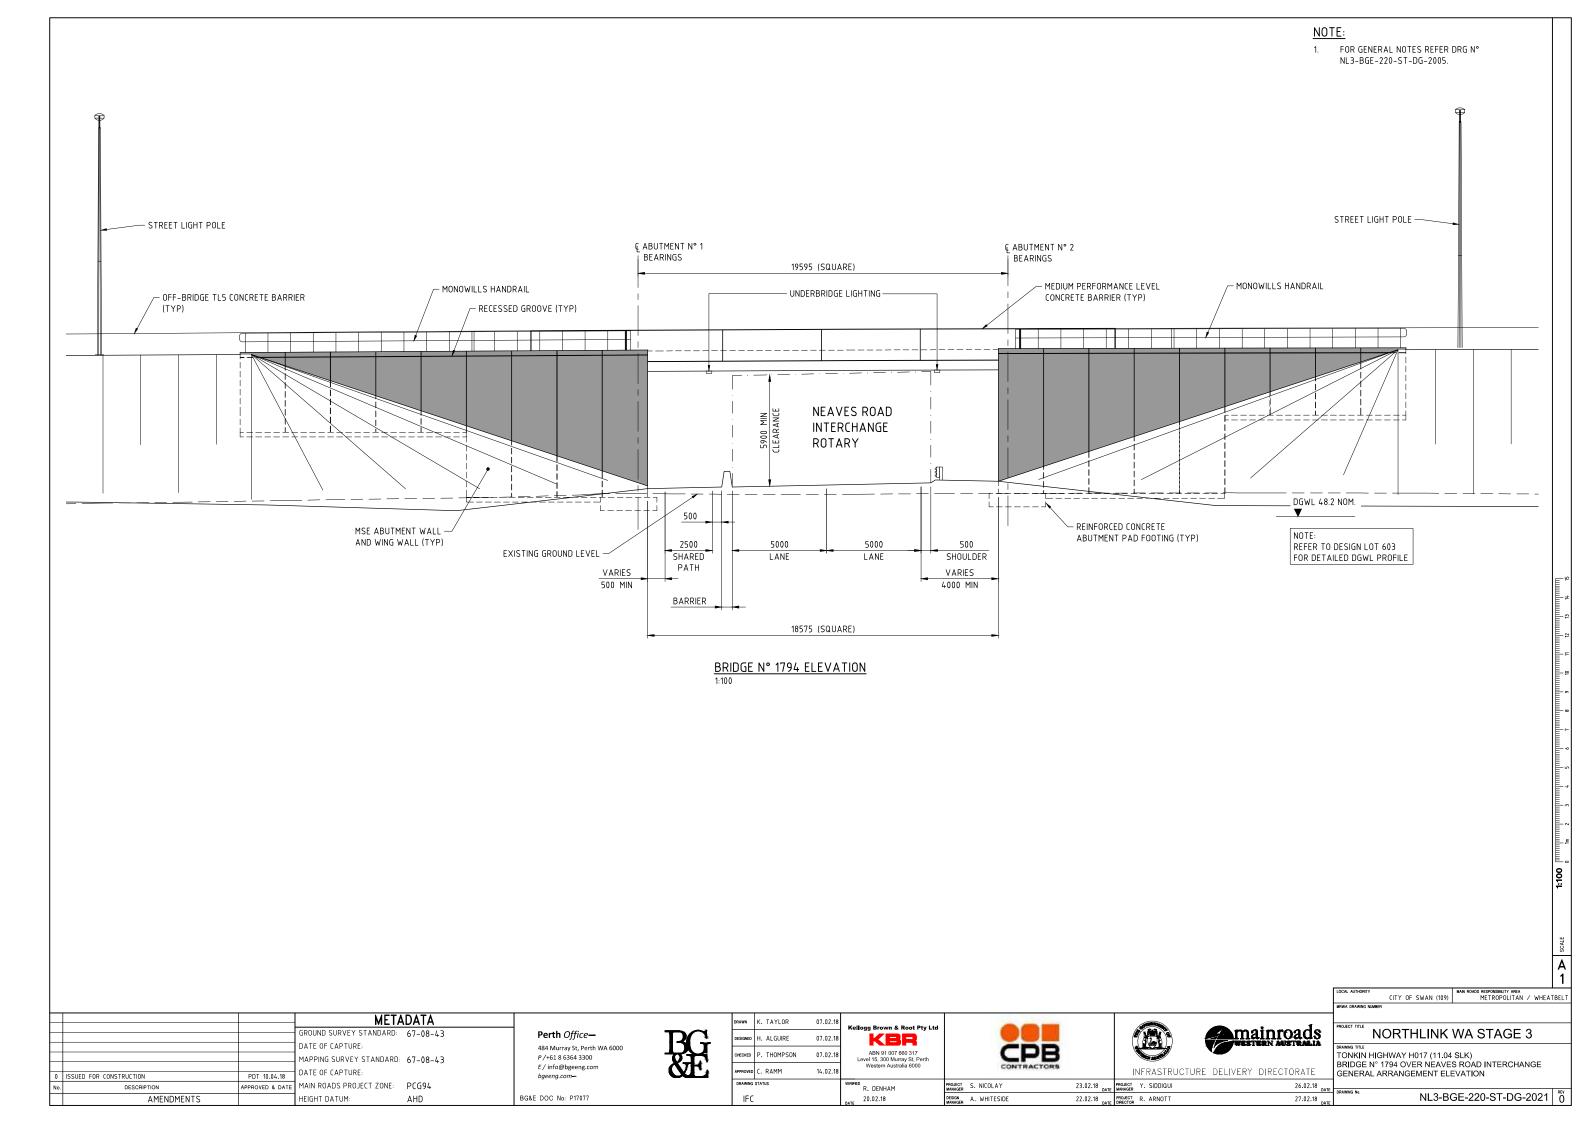

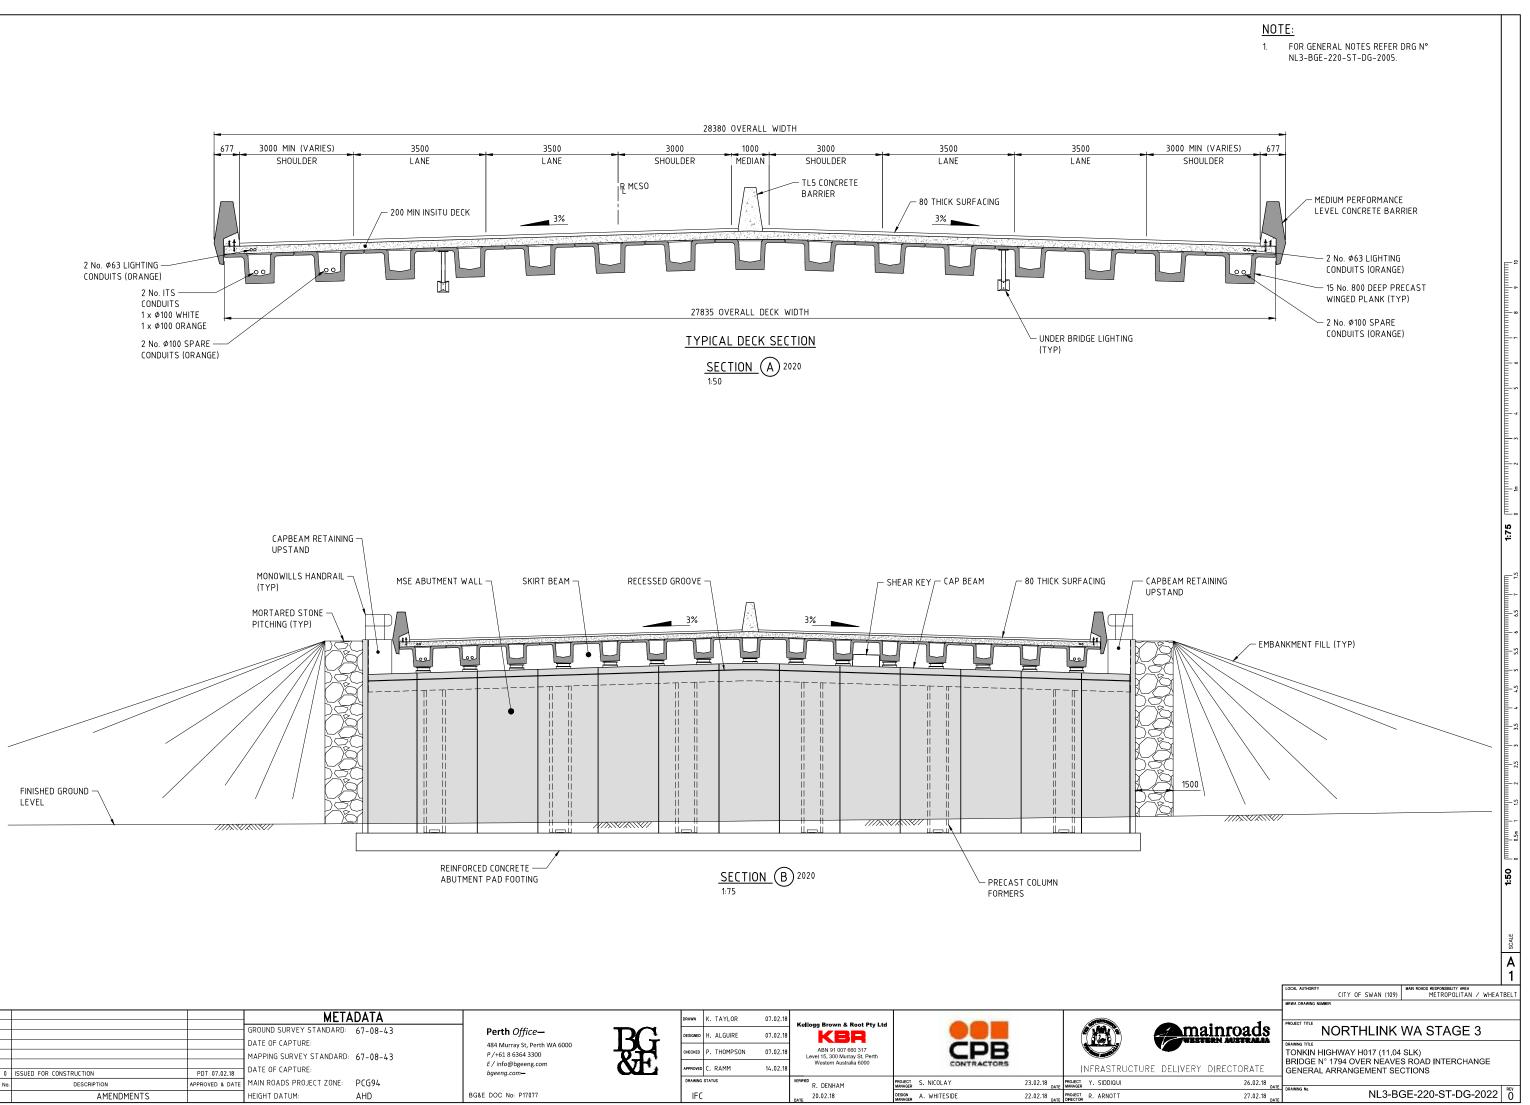

NORTHLINK STAGE 3 DRAWING INDEX

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NL3-BGE-140-ST-DG-1001	INDEX SHEET			NL3-BGE-140-ST-DG-1340
		NL3-BGE-140-ST-DG-1165	DEFLECTION WALL REINFORCEMENT ELEVATION AND DETAILS	
NL3-BGE-140-ST-DG-1005	GENERAL NOTES	NL3-BGE-140-ST-DG-1166	PIER WALL REINFORCEMENT ELEVATION AND DETAILS	NL3-BGE-140-ST-DG-1350
		NL3-BGE-140-ST-DG-1167	PIER COLUMN REINFORCEMENT PLAN AND SECTIONS	NL3-BGE-140-ST-DG-1351
NL3-BGE-140-ST-DG-1008	CONSTRUCTION NOTES SHEET 1			
NL3-BGE-140-ST-DG-1009	CONSTRUCTION NOTES SHEET 2	NL3-BGE-140-ST-DG-1190	BEARINGS PLAN AND NOTES	NL3-BGE-140-ST-DG-1355
		NL3-BGE-140-ST-DG-1191	BEARINGS SCHEDULE	
NL3-BGE-140-ST-DG-1010	DESIGN SUMMARY SHEET 1 OF 3	NL3-BGE-140-ST-DG-1192	BEARINGS SECTIONS AND DETAILS SHEET 1	NL3-BGE-140-ST-DG-1360
NL3-BGE-140-ST-DG-1011	DESIGN SUMMARY SHEET 2 OF 3	NL3-BGE-140-ST-DG-1193	BEARINGS SECTIONS AND DETAILS SHEET 2	
NL3-BGE-140-ST-DG-1012	DESIGN SUMMARY SHEET 3 OF 3			NL3-BGE-140-ST-DG-1365
		SUPER-STRUCTURE		NL3-BGE-140-ST-DG-1366
NL3-BGE-140-ST-DG-1020	GENERAL ARRANGEMENT PLAN	NL3-BGE-140-ST-DG-1200	PRECAST BEAM LAYOUT PLAN AND DETAILS	
NL3-BGE-140-ST-DG-1021	GENERAL ARRANGEMENT ELEVATION AND SECTION	NL3-BGE-140-ST-DG-1210	PRECAST BEAM CONCRETE PLAN AND ELEVATION SHEET 1 OF 8	NL3-BGE-140-ST-DG-1370
NL3-BGE-140-ST-DG-1022	GENERAL ARRANGEMENT SECTIONS	NL3-BGE-140-ST-DG-1211	PRECAST BEAM CONCRETE PLAN AND ELEVATION SHEET 2 OF 8	NL3-BGE-140-ST-DG-1375
		NL3-BGE-140-ST-DG-1212	PRECAST BEAM CONCRETE PLAN AND ELEVATION SHEET 3 OF 8	NL3-BGE-140-ST-DG-1376
NL3-BGE-140-ST-DG-1040	SITE INVESTIGATION INFORMATION SHEET 1 OF 3	NL3-BGE-140-ST-DG-1213	PRECAST BEAM CONCRETE PLAN AND ELEVATION SHEET 4 OF 8	
NL3-BGE-140-ST-DG-1041	SITE INVESTIGATION INFORMATION SHEET 2 OF 3	NL3-BGE-140-ST-DG-1214	PRECAST BEAM CONCRETE PLAN AND ELEVATION SHEET 5 OF 8	NL3-BGE-140-ST-DG-1380
NL3-BGE-140-ST-DG-1042	SITE INVESTIGATION INFORMATION SHEET 3 OF 3	NL3-BGE-140-ST-DG-1215	PRECAST BEAM CONCRETE PLAN AND ELEVATION SHEET 6 OF 8	NL3-BGE-140-ST-DG-1381
		NL3-BGE-140-ST-DG-1216	PRECAST BEAM CONCRETE PLAN AND ELEVATION SHEET 7 OF 8	
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NL3-BGE-140-ST-DG-1071	ABUTMENT No. 2 MSE WALL PLAN AND ELEVATION	NL3-BGE-140-ST-DG-1222	PRECAST BEAM CONCRETE SECTIONS AND DETAILS	
NL3-BGE-140-ST-DG-1072	ABUTMENT MSE WALL DETAILS			NL3-BGE-140-ST-DG-1400
		NL3-BGE-140-ST-DG-1240	PRECAST BEAM PRESTRESS LAYOUT AND NOTES - SHEET 1 OF 3	NL3-BGE-140-ST-DG-1401
NL3-BGE-140-ST-DG-1100	ABUTMENT No. 1 FOOTING CONCRETE PLAN AND SECTIONS	NL3-BGE-140-ST-DG-1241	PRECAST BEAM PRESTRESS LAYOUT AND NOTES - SHEET 2 OF 3	
		NL3-BGE-140-ST-DG-1242	PRECAST BEAM PRESTRESS LAYOUT AND NOTES - SHEET 3 OF 3	NL3-BGE-140-ST-DG-1405
NL3-BGE-140-ST-DG-1105	ABUTMENT No. 2 FOOTING CONCRETE PLAN AND SECTIONS	NL3-BGE-140-ST-DG-1245	PRECAST BEAM POST TENSIONING DETAILS SHEET 1 OF 2	
		NL3-BGE-140-ST-DG-1246	PRECAST BEAM POST TENSIONING DETAILS SHEET 2 OF 2	NL3-BGE-140-ST-DG-1420
NL3-BGE-140-ST-DG-1110	ABUTMENT No. 1 AND No. 2 FOOTING REINFORCEMENT PLAN AND SECTIONS		PRECAST BEAM REINFORCEMENT PLAN AND ELEVATIONS SHEET 1	NL3-BGE-140-ST-DG-1421
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NL3-BGE-140-ST-DG-1115	PRECAST COLUMN FORMER CONCRETE AND REINFORCEMENT	NL3-BGE-140-ST-DG-1251	PRECAST BEAM REINFORCEMENT PLAN AND ELEVATIONS SHEET 2	NL3-BGE-140-ST-DG-1425
	DETAILS			NL3-BGE-140-ST-DG-1430
		NL3-BGE-140-ST-DG-1252	PRECAST BEAM REINFORCEMENT PLAN AND ELEVATIONS SHEET 3 OF 4	
NL3-BGE-140-ST-DG-1120	PRECAST COLUMN FORMER INFILL CONCRETE AND REINFORCEMENT DETAILS		PRECAST BEAM REINFORCEMENT PLAN AND ELEVATIONS SHEET 4	NL3-BGE-140-ST-DG-1460
		NL3-BGE-140-ST-DG-1253	OF 4	
NL3-BGE-140-ST-DG-1130	ABUTMENT N° 1 CAP BEAM CONCRETE PLAN AND ELEVATION			MRWA REFERENCE DRAWINGS
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NL3-BGE-140-ST-DG-1132	ABUTMENT CAP BEAM CONCRETE TYPICAL DETAILS			0430–1314 PRECAST PARAPET PARA
		NL3-BGE-140-ST-DG-1270	PRECAST BEAM REINFORCEMENT ABUTMENT END DIAPHRAGM	
NL3-BGE-140-ST-DG-1135	ABUTMENT CAP BEAM REINFORCEMENT PLAN AND SECTIONS	NL3-BGE-140-ST-DG-1280	PRECAST BEAM REINFORCEMENT INTERNAL DIAPHRAGM	
		NL3-BGE-140-ST-DG-1290	PRECAST BEAM REINFORCEMENT PIER END DIAPHRAGM	
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		NL3-BGE-140-ST-DG-1301	DELK CONCRETE LEVEL TADLES	
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	SECTION			
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NL3-BGE-140-ST-DG-1151	PILE REINFORCEMENT ELEVATIONS AND SECTIONS			
		NL3-BGE-140-ST-DG-1320	DECK REINFORCEMENT PLAN AND DETAILS	
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NL3-BGE-140-ST-DG-1161	PIER No. 1 CONCRETE PLAN AND SECTIONS			
NL3-BGE-140-ST-DG-1162	PIER No. 2 CONCRETE PLAN AND SECTIONS	NL3-BGE-140-ST-DG-1325	SKIRT BEAM REINFORCEMENT ELEVATIONS	

F				ADATA			DRAWN	K. TAYLOR	04.05.18	Kellogg Brown & Root Pty Ltd				
			GROUND SURVEY STANDARD	67-08-43	Perth Office-		DESIGNED	J. deBURGH	04.05.18	KBR				
-			DATE OF CAPTURE:	(5.00.10	484 Murray St, Perth WA 6000 P /+61 8 6364 3300		CHECKED	P. THOMPSON	04.05.18	ABN 91 007 660 317	CDB			
			MAPPING SURVEY STANDARD: DATE OF CAPTURE:	67-08-43	E/info@bgeeng.com	Ö E	APPROVED	P. THOMPSON	07.06.18	Level 15, 300 Murray St, Perth Western Australia 6000	CONTRACTORS		INFRASTRUCTUR	ər
	0 ISSUED FOR CONSTRUCTION	PDT 04.05.18	DATE OF CAPTORE:		bgeeng.com-			1. 11011 3011	07100110				INTRASTRUCTOR	·L
	No. DESCRIPTION	APPROVED & DATE	MAIN ROADS PROJECT ZONE:	PCG94			DRAWING	STATUS		R. DENHAM	PROJECT C. SAXON	14.06.18 DA1	PROJECT Y. SIDDIQUI	
	AMENDMENTS		HEIGHT DATUM:	AHD	BG&E DOC No: P17077		IFC			11.06.18	DESIGN A. WHITESIDE	11.06.18	PROJECT R. ARNOTT	

DRAWING TITLE

DECK WATERPROOFING PLAN AND DETAILS

APPROACH SLAB CONCRETE PLANS APPROACH SLAB CONCRETE SECTIONS AND DETAILS

APPROACH SLAB REINFORCEMENT PLAN AND SECTIONS

EXPANSION JOINT PLAN AND SECTIONS

COVER PLATE PLAN AND SECTIONS COVER PLATE DETAILS

BARRIER LAYOUT PLAN AND DETAILS BARRIER SECTIONS AND DETAILS SHEET 1 BARRIER SECTIONS AND DETAILS SHEET 2

PRECAST PANEL PLANS AND ELEVATIONS SHEET 1 OF 2 PRECAST PANEL PLANS AND ELEVATIONS SHEET 2 OF 2

PRECAST PANEL REINFORCEMENT DETAILS SHEET 1 PRECAST PANEL REINFORCEMENT DETAILS SHEET 2

INSITU BARRIER STITCH ELEVATION AND DETAILS

TRANSITION BARRIER DETAILS SHEET 1 TRANSITION BARRIER DETAILS SHEET 2

TRANSITION BARRIER REINFORCEMENT DETAILS

ANTI-THROW SCREEN PLANS AND ELEVATIONS ANTI-THROW SCREEN DETAILS

PRECAST PARAPET PANEL DETAILS


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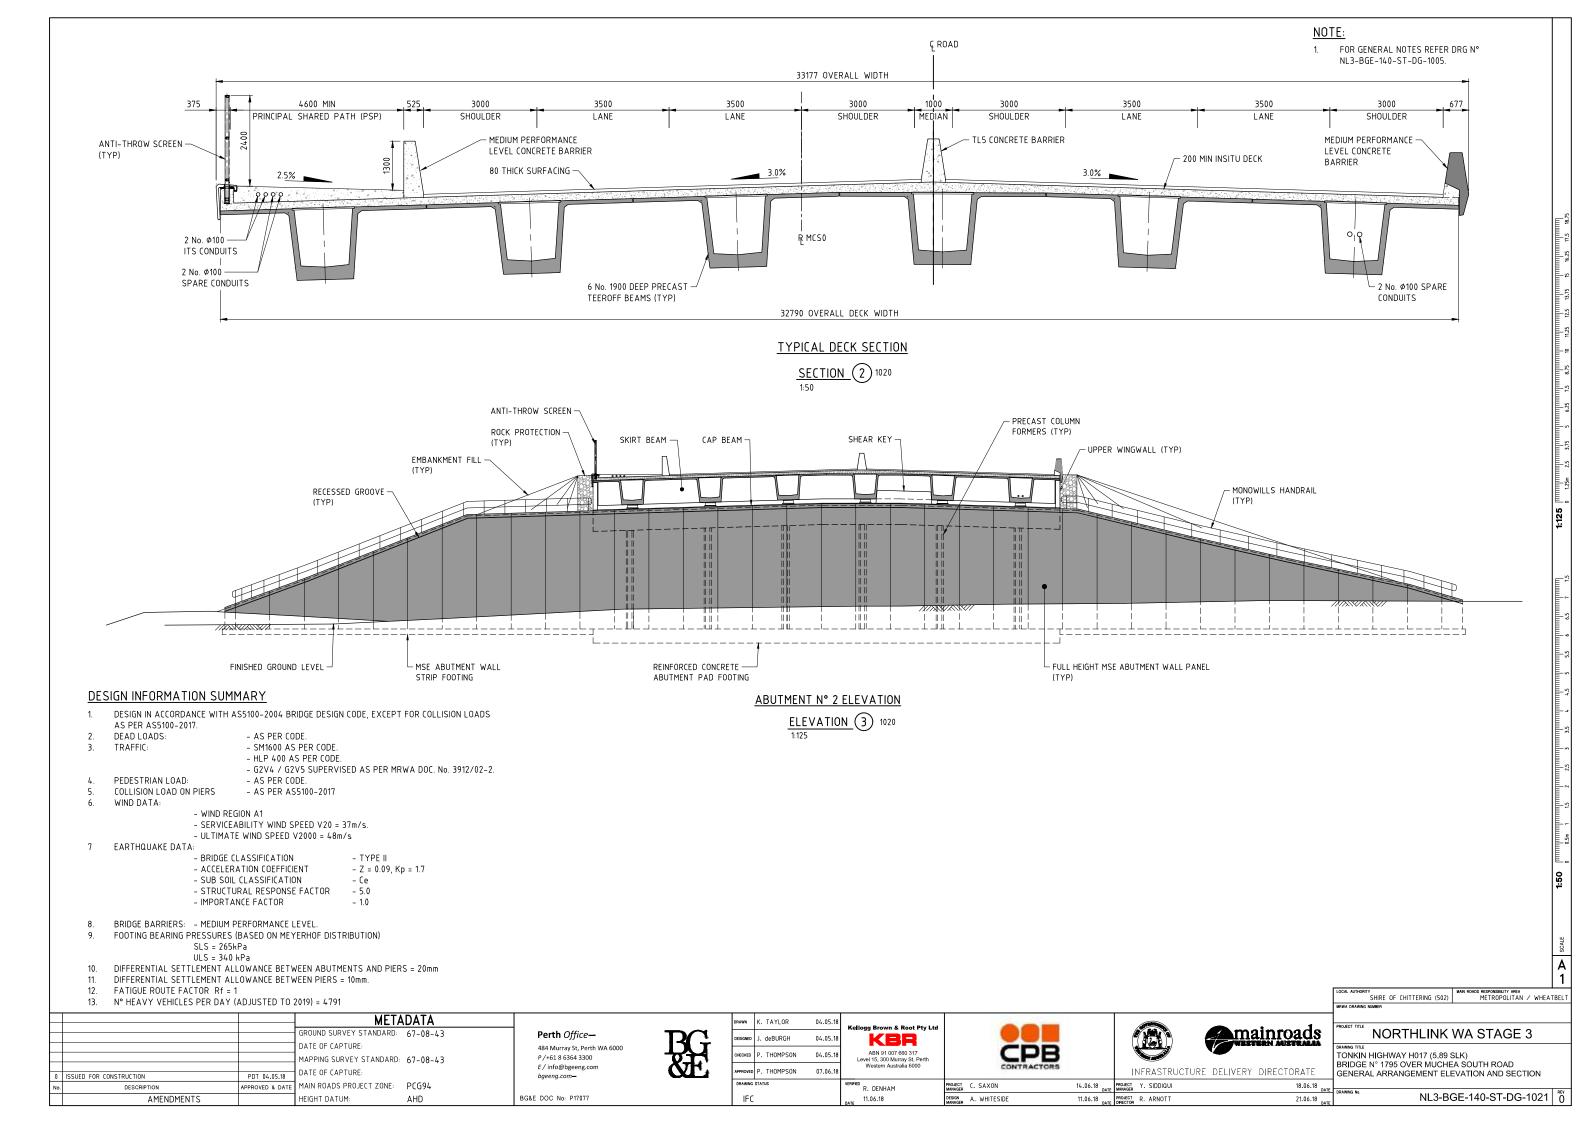
PSP INFILL CONCRETE AND JOINT DETAILS


REFERENCE DRAWINGS PRECAST PARAPET PANELS

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	MRWA DRAWING NUMBER	HETROPOLITAN / WHEATBLET
mainroads		WA STAGE 3
	DRAWING TITLE TONKIN HIGHWAY H017 (5.89 S BRIDGE N° 1795 OVER MUCHE	
RE DELIVERY DIRECTORATE	INDEX SHEET	.A 3001111(0AD
18.06.18 DATE	DRAWING No.	REV
21.06.18	NL3-BC	GE-140-ST-DG-1001 ີ ດັ

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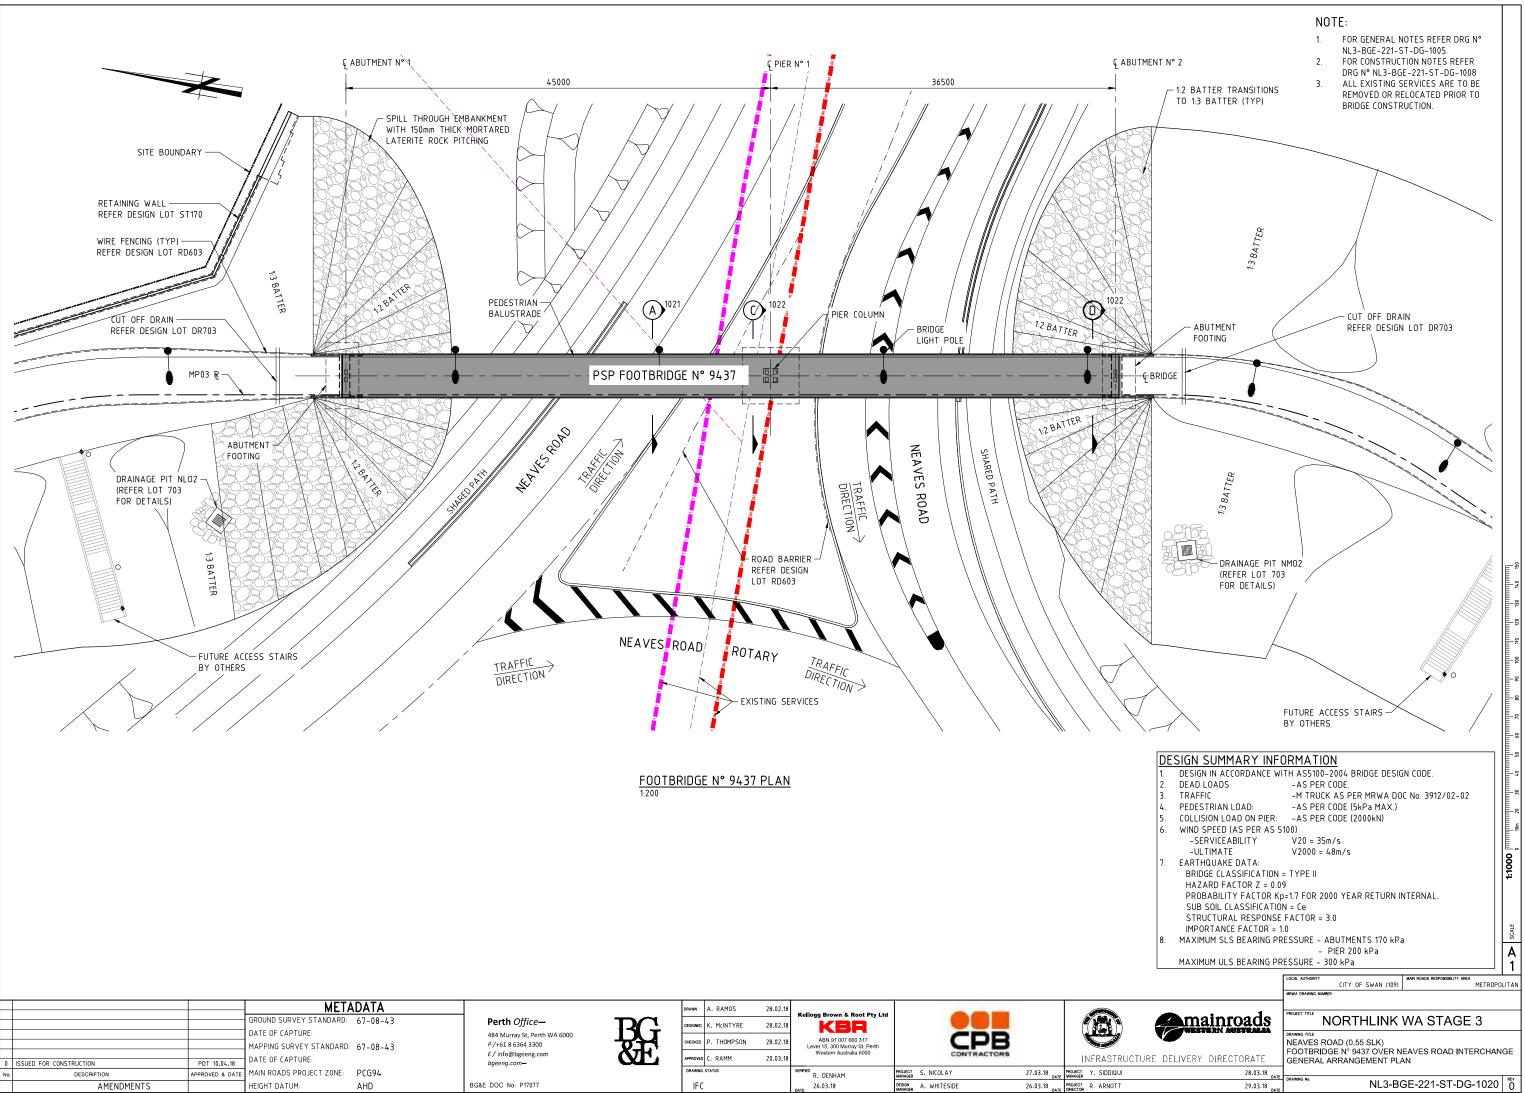
NORTHLINK STAGE 3 DRAWING INDEX	3				
DRG No.	DRAWING TITLE	DRG No.	DRAWING TITLE		
GENERAL		SUPER-STRUCTURE	E (CON'T)	MRWA REF	ERENCE DRAW
NL3-BGE-221-ST-DG-1000 NL3-BGE-221-ST-DG-1001	COVER SHEET INDEX SHEET	NL3-BGE-221-ST-DG-1320	DECK REINFORCEMENT PLAN	0730-0406-2 0630-1902	BRIDGE ACCES BRIDGE LIGHT
NL3-BGE-221-ST-DG-1005	GENERAL NOTES	NL3-BGE-221-ST-DG-1360	EXPANSION JOINT PLAN AND SECTIONS		
NL3-BGE-221-ST-DG-1008	CONSTRUCTION NOTES	NL3-BGE-221-ST-DG-1420 NL3-BGE-221-ST-DG-1421	PEDESTRIAN BALUSTRADE DETAILS SHEET 1 OF 2 PEDESTRIAN BALUSTRADE DETAILS SHEET 2 OF 2		
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NL3-BGE-221-ST-DG-1011	DESIGN SUMMARY SHEET 2 OF 3	NL3-BGE-221-ST-DG-1430	LIGHTING AND SERVICES LAYOUT PLAN AND SECTIONS		
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NLJ-DUE-221-31-DU-1022	GENERAL ARRANGEMENT SECTIONS				
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NL3-BGE-221-ST-DG-1050	GEOMETRIC DATA				
SUB-STRUCTURE					
NL3-BGE-221-ST-DG-1080	ABUTMENT No. 1 CONCRETE PLAN AND ELEVATIONS				
NL3-BGE-221-ST-DG-1081	ABUTMENT No. 2 CONCRETE PLAN AND ELEVATIONS				
NL3-BGE-221-ST-DG-1090	ABUTMENT No. 1 REINFORCEMENT PLAN AND ELEVATION				
NL3-BGE-221-ST-DG-1091	ABUTMENT No. 1 REINFORCEMENT WINGWALL ELEVATIONS AND DETAILS				
NL3-BGE-221-ST-DG-1095	ABUTMENT No. 2 REINFORCEMENT PLAN AND ELEVATION				
NL3-BGE-221-ST-DG-1096	ABUTMENT No. 2 REINFORCEMENT WINGWALL ELEVATIONS AND DETAILS				
NL3-BGE-221-ST-DG-1150	PIER CONCRETE PLAN AND ELEVATION				
NL3-BGE-221-ST-DG-1155	PIER REINFORCEMENT ELEVATION AND DETAILS				
SUPER-STRUCTURE					
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NL3-BGE-221-ST-DG-1220	PRECAST BEAM CONCRETE SECTIONS				
NL3-BGE-221-ST-DG-1221	PRECAST BEAM CONCRETE SECTIONS AND DETAILS				
NL3-BGE-221-ST-DG-1240	PRECAST BEAM No.1 PRESTRESS LAYOUT AND NOTES				
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NL3-BGE-221-ST-DG-1250	PRECAST BEAM No.1 REINFORCEMENT PLAN AND ELEVATIONS				
NL3-BGE-221-ST-DG-1251	PRECAST BEAM No.2 REINFORCEMENT PLAN AND ELEVATIONS				
NL3-BGE-221-ST-DG-1260	PRECAST BEAM REINFORCEMENT SECTIONS				
NID DEE 221 ET DE 1270					
NL3-BGE-221-ST-DG-1270	PRECAST BEAM REINFORCEMENT ABUTMENT END DIAPHRAGM				
NL3-BGE-221-ST-DG-1280	PRECAST BEAM REINFORCEMENT INTERNAL END DIAPHRAGM				
NL3-BGE-221-ST-DG-1290	PRECAST BEAM REINFORCEMENT PIER END DIAPHRAGM				
NL3-BGE-221-ST-DG-1300	DECK CONCRETE PLAN				
NL3-BGE-221-ST-DG-1305	DECK CONCRETE DETAILS AND ELEVATIONS				

		META	ADATA			DRAWN A. RAMOS	28.02.18				
		GROUND SURVEY STANDARD:	67-08-43	Perth Office—		DESIGNED K. MCINTYRE	28.02.18	Kellogg Brown & Root Pty Ltd			
		DATE OF CAPTURE:		484 Murray St, Perth WA 6000		CHECKED P. THOMPSON	28.02.18	ABN 91 007 660 317	CPB		
		MAPPING SURVEY STANDARD:	67-08-43	P / +61 8 6364 3300 E / info@bgeeng.com	&E	CHECKED P. THUMPSON	20.02.10	Level 15, 300 Murray St, Perth Western Australia 6000	CONTRACTORS		
0 ISSUED FOR CONSTRUCTION	PDT 10.04.18	DATE OF CAPTURE:		bgeeng.com-		APPROVED C. RAMM	20.03.18		CONTRACTORS		INFRASTRUCTURE
No. DESCRIPTION APP	PROVED & DATE	MAIN ROADS PROJECT ZONE:	PCG94			DRAWING STATUS		R. DENHAM	PROJECT S. NICOLAY	27.03.18 DATE	PROJECT Y. SIDDIQUI
AMENDMENTS		HEIGHT DATUM:	AHD	BG&E DOC No: P17077		IFC		26.03.18 DATE	DESIGN A. WHITESIDE	26.03.18 DATE	PROJECT R. ARNOTT

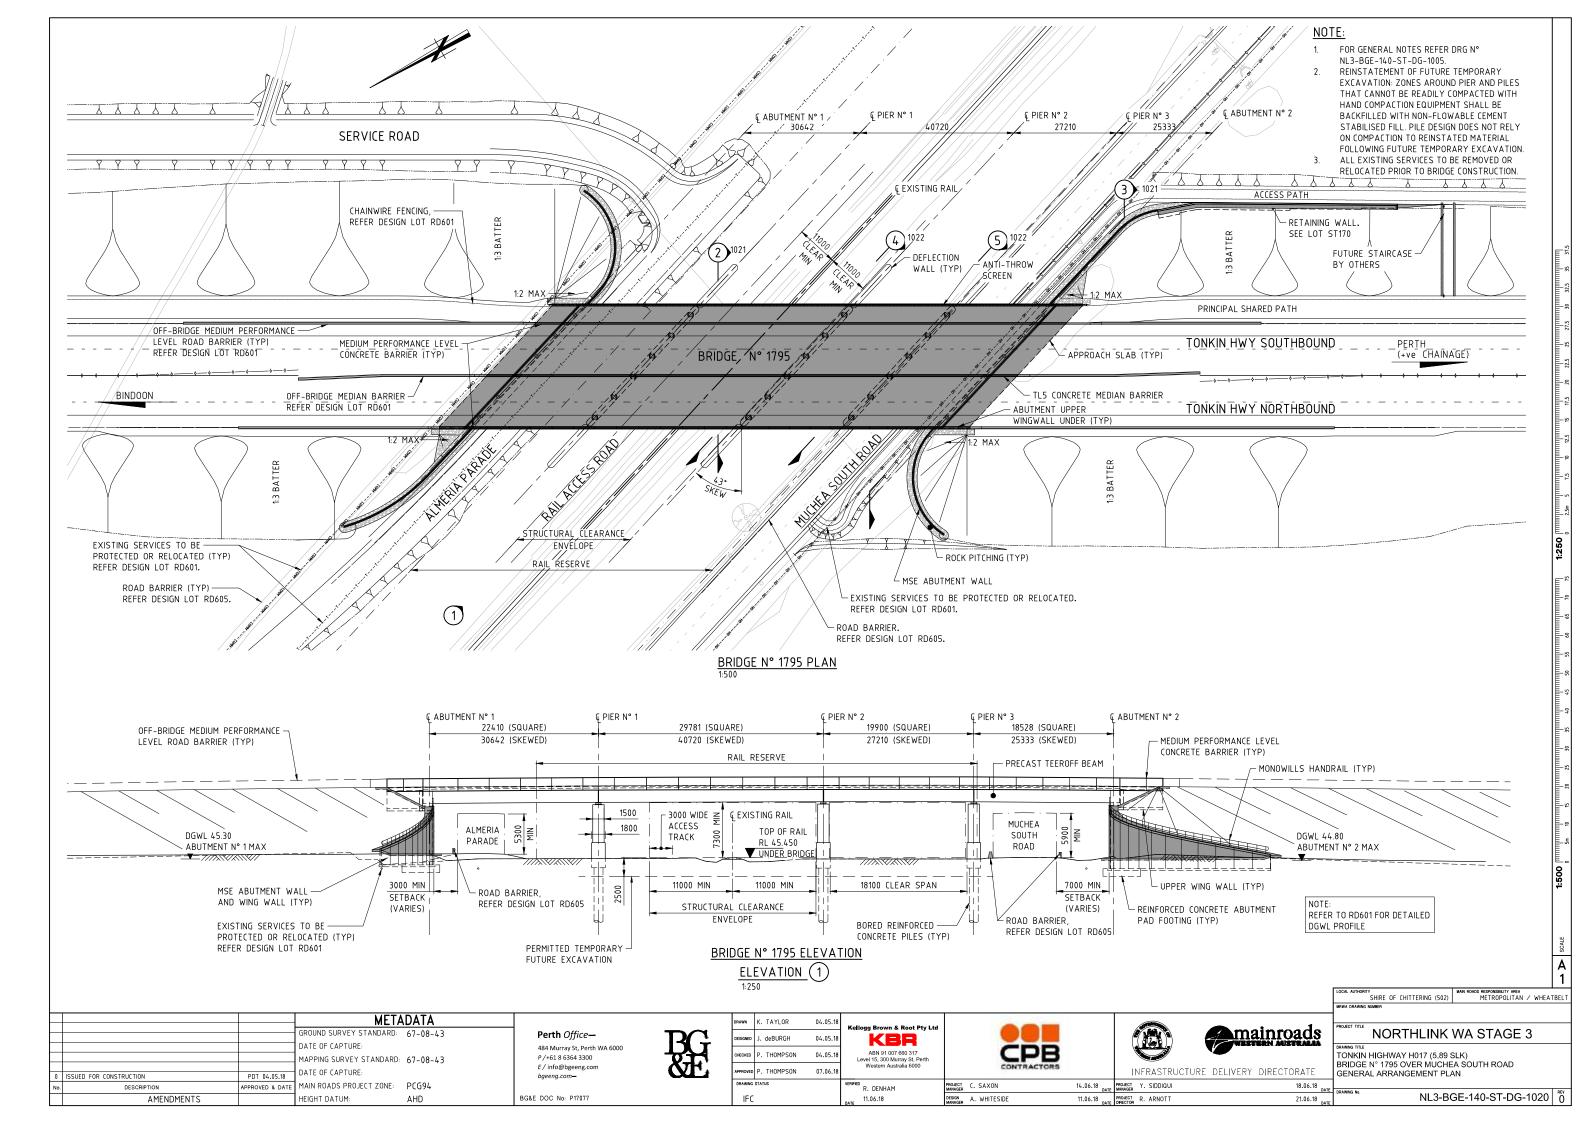
AWINGS

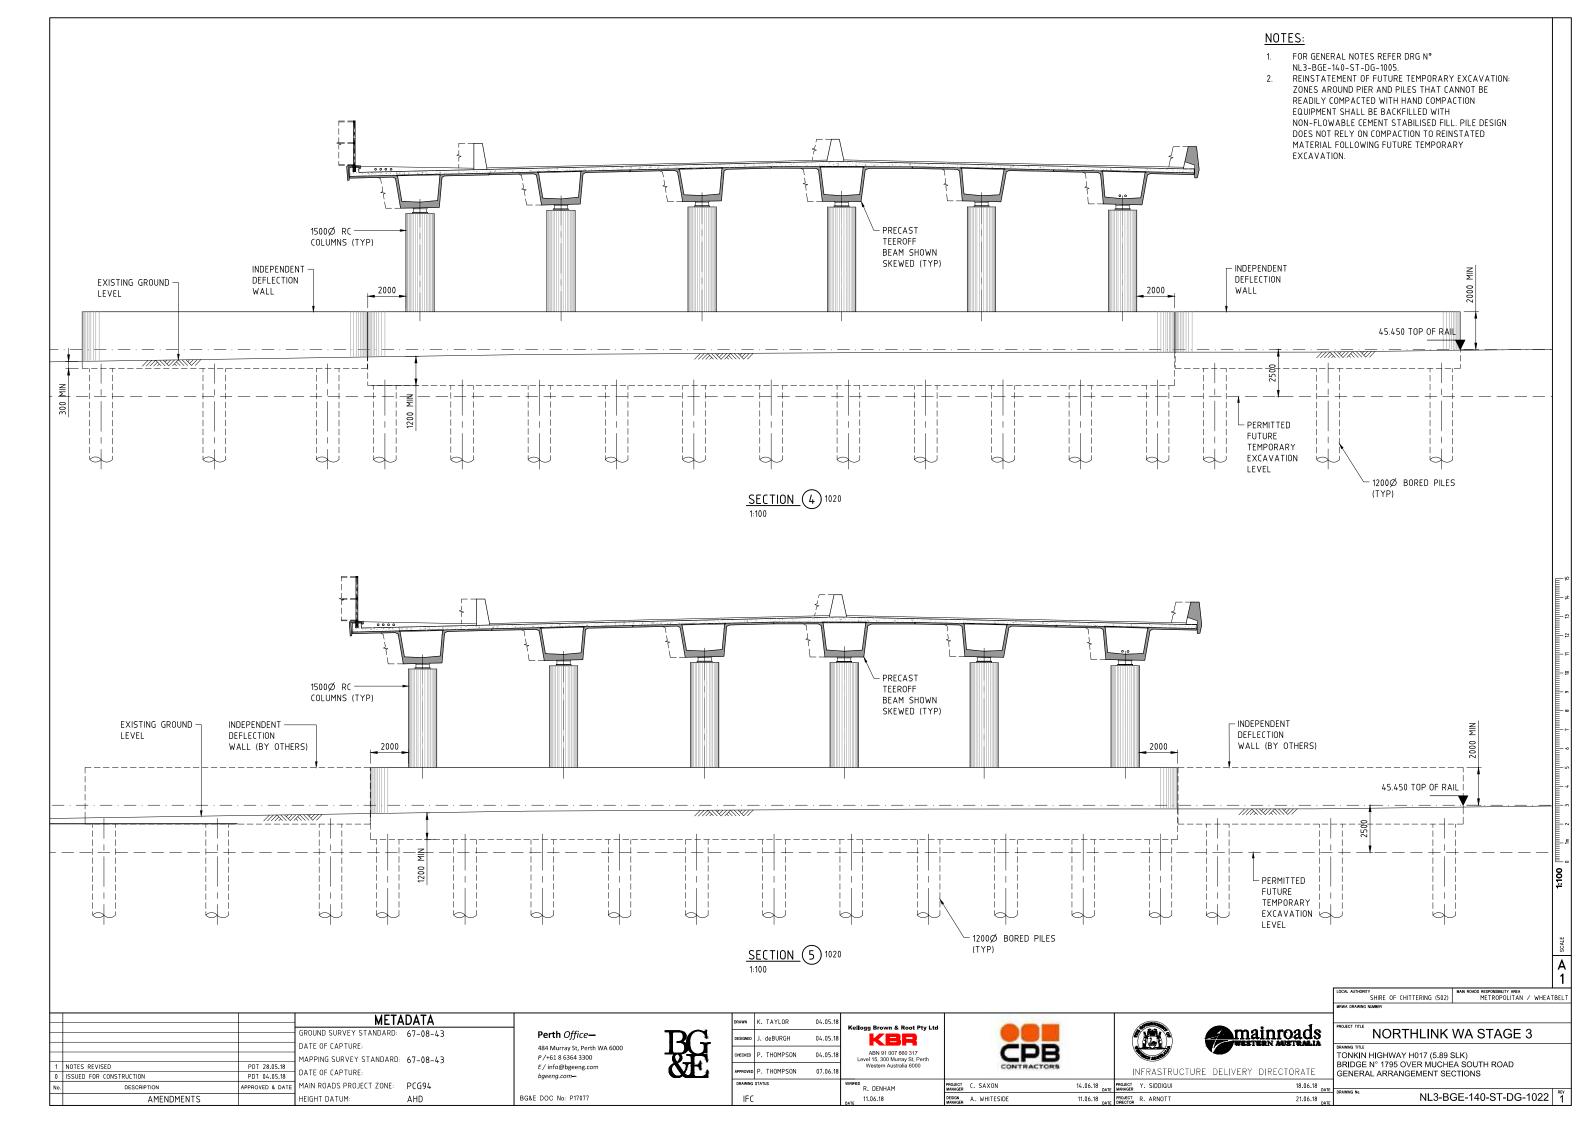CCESS WAY SHEET N° 1 IGHT POLE BASE SHEET N° 2


		SCALE
		A
	LOCAL AUTHORITY CITY OF SWAN (109)	MAIN ROADS RESPONSIBILITY AREA METROPOLITAN
	MRWA DRAWING NUMBER	
mainroads		WA STAGE 3
RE DELIVERY DIRECTORATE	DRAWING TITLE NEAVES ROAD (0.55 SLK) FOOTBRIDGE N° 9437 OVER N INDEX SHEET	EAVES ROAD INTERCHANGE
28.03.18 DATE	DRAWING No.	REV
29.03.18 DATE	NL3-B	GE-221-ST-DG-1001



-			MET	ADATA			DRAWN	A. RAMOS	28.02.18	Kallana Barra & Barra Bia I da						
ŀ			GROUND SURVEY STANDARD:	67-08-43	Perth Office-	DC	DESIGNED	K. McINTYRE	28.02.18	Kellogg Brown & Root Pty Ltd				1		1
			DATE OF CAPTURE:		484 Murray St, Perth WA 6000	DU I		P. THOMPSON	28.02.18	ABN 91 007 660 317		CDP		4		
-			MAPPING SURVEY STANDARD	67-08-43	P/+61 8 6364 3300	VI. +	CHECKED	P. THUMPSUN	28.02.18	Level 15, 300 Murray St, Perth Western Australia 6000		CPD				
ŀ	0 ISSUED FOR CONSTRUCTION	PDT 10.04.18	DATE OF CAPTURE:		E / info@bgeeng.com bgeeng.com—	QT.	APPROVED	C. RAMM	20.03.18	Western Australia 6000		CONTRACTORS		1	NFRASTRUCTURE	Ε
			MAIN ROADS PROJECT ZONE:	PCG94	~g.co.g.co		DRAWING S	STATUS		R. DENHAM	PROJECT	S. NICOLAY	27.03.18 DAT	PROJECT NANAGER	Y. SIDDIQUI	-
	AMENDMENTS		HEIGHT DATUM:	AHD	BG&E DOC No: P17077		IFC			26.03.18	DESIGN MANAGER	A. WHITESIDE	26.03.18 DAT	PROJECT DIRECTOR	R. ARNOTT	

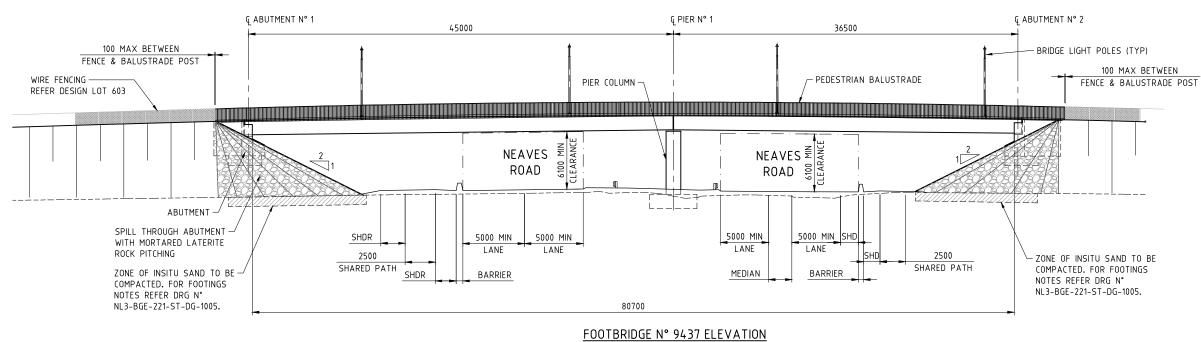

1:200

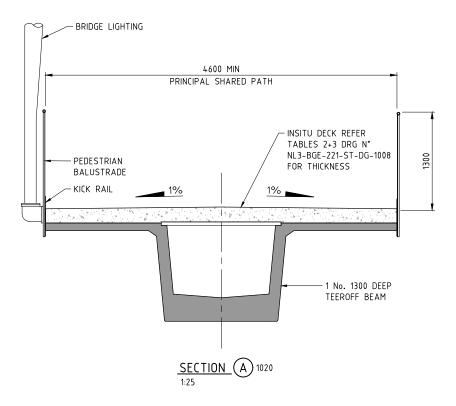



			METADATA GROUND SURVEY STANDARD: 67-08-43 DATE OF CAPTURE: MAPPING SURVEY STANDARD: 67-08-43	Perth Office 484 Murray 5t, Perth WA 6000 P/+61.8 6364 3300	DRAWN A. RAMOS 28.02.18 designed K. McINTYRE 28.02.18 cheoked P. THOMPSON 28.02.18	Kellogg Brown & Root Pty Ltd	СРВ		mainroads
0	ISSUED FOR CONSTRUCTION	PDT 10.04.18	DATE OF CAPTURE:	E / info@bgeeng.com	APPROVED C. RAMM 20.03.18		CONTRACTORS	INFRASTRUCTUR	RE DELIVERY DIRECTORATE
No		APPROVED & DATE	MAIN ROADS PROJECT ZONE: PCG94		DRAWING STATUS	R. DENHAM	PROJECT S. NICOLAY 27.03.18	TE NANAGER Y. SIDDIQUI	28.03.18 DA
	AMENDMENTS		HEIGHT DATUM: AHD	BG&E DOC No: P17077	IFC	26.03.18 DATE	DESIGN A. WHITESIDE 26.03.18	TE DRECTOR R. ARNOTT	29.03.18 pa



CITY OF SWAN (109)

FOR GENERAL NOTES REFER DRG N° NL3-BGE-221-ST-DG-1005.

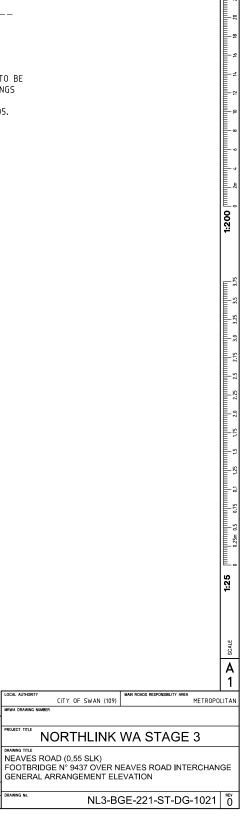

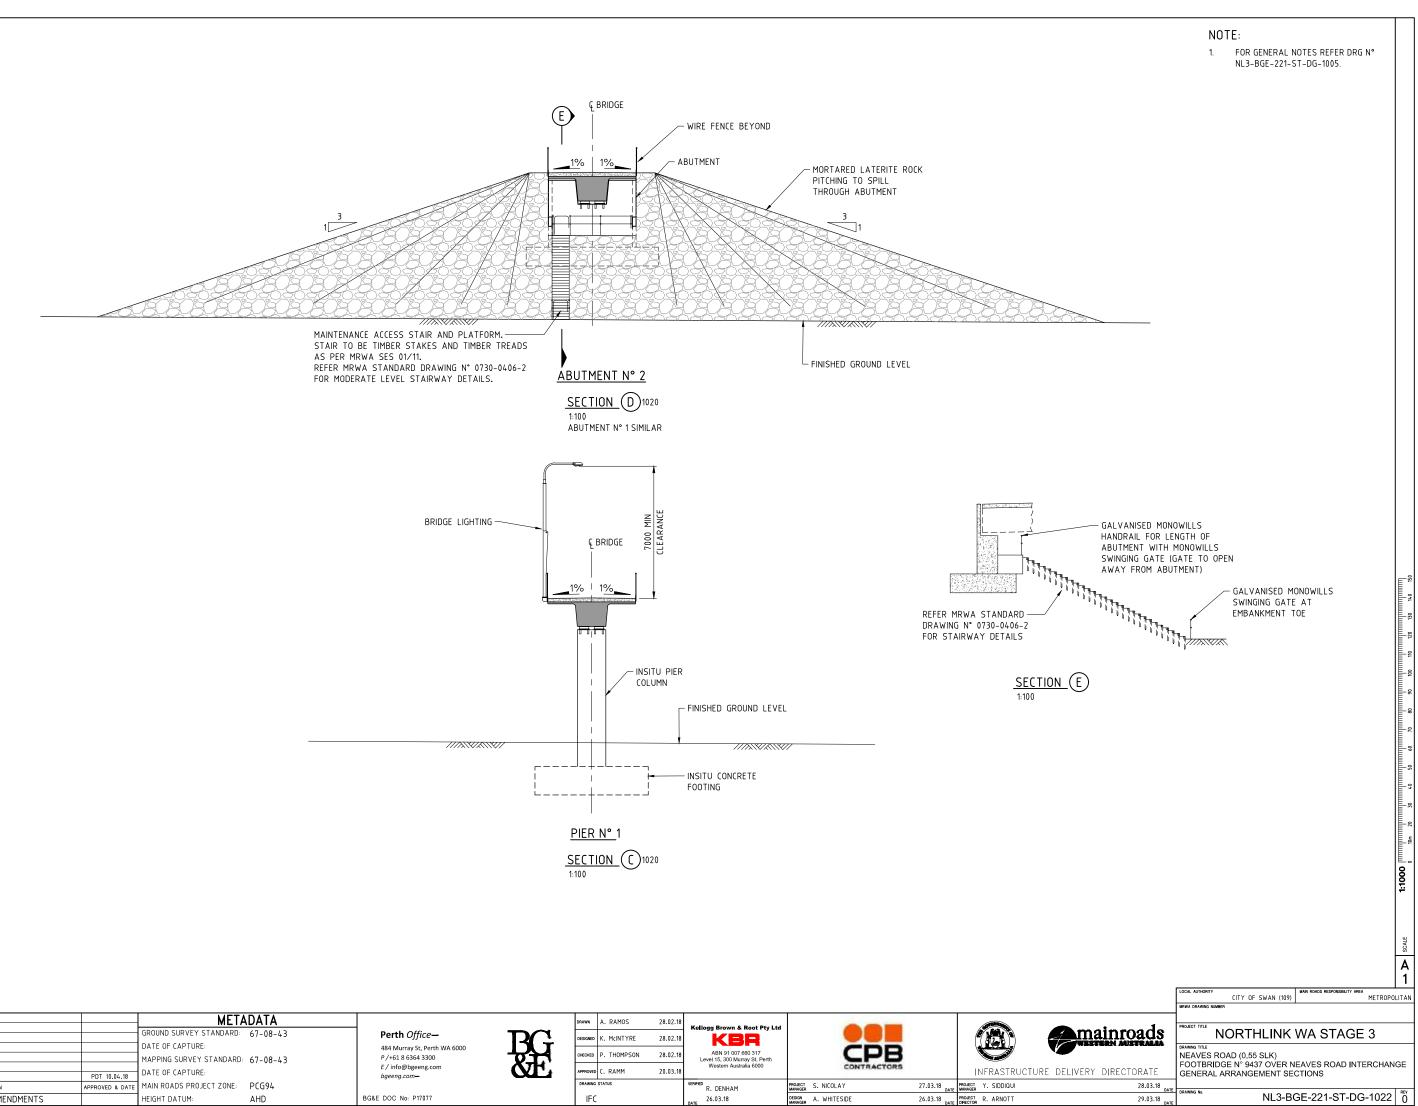

F			META	ADATA			DRAWN	A. RAMOS	28.02.18				
-			GROUND SURVEY STANDARD:	67-08-43	Perth Office—		DESIGNED	K. McINTYRE	28.02.18	Kellogg Brown & Root Pty Ltd			
			DATE OF CAPTURE:		484 Murray St, Perth WA 6000					ABN 91 007 660 317	CDP		
			MAPPING SURVEY STANDARD:	67-08-43	P/+61 8 6364 3300		CHECKED	P. THOMPSON	28.02.18	Level 15, 300 Murray St, Perth Western Australia 6000			
- F			DATE OF CAPTURE:		E / info@bgeeng.com	ŎТЕ –	APPROVED	C. RAMM	20.03.18	Western Australia 6000	CONTRACTORS		INFRASTRUCTURE
	0 ISSUED FOR CONSTRUCTION	PDT 10.04.18	DATE OF CALIFORE.		bgeeng.com-								
	No. DESCRIPTION	APPROVED & DATE	MAIN ROADS PROJECT ZONE:	PCG94			DRAWING S	STATUS		R. DENHAM	PROJECT S. NICOLAY	27.03.18 DATE	PROJECT Y. SIDDIQUI
	AMENDMENTS		HEIGHT DATUM:	AHD	BG&E DOC No: P17077		IFC			26.03.18	DESIGN A. WHITESIDE	26.03.18 DATE	PROJECT R. ARNOTT

NORTHLINK STAGE 3 DRAWING INDEX

DRAWING INDEX		
DRG No.	DRAWING TITLE	DRG No.
GENERAL		SUPER-STRUCTURE
NL3-BGE-130-ST-DG-1000	COVER SHEET	NL3-BGE-130-ST-DG-1220
NL3-BGE-130-ST-DG-1001	INDEX SHEET	
		NL3-BGE-130-ST-DG-1240
NL3-BGE-130-ST-DG-1005	GENERAL NOTES	
		NL3-BGE-130-ST-DG-1250
NL3-BGE-130-ST-DG-1008	CONSTRUCTION NOTES	NL3-BGE-130-ST-DG-1260
NL3-BGE-130-ST-DG-1010	DESIGN SUMMARY SHEET 1 OF 3	NL3-BGE-130-ST-DG-1270
NL3-BGE-130-ST-DG-1011	DESIGN SUMMARY SHEET 2 OF 3	
NL3-BGE-130-ST-DG-1012	DESIGN SUMMARY SHEET 3 OF 3	NL3-BGE-130-ST-DG-1300
		NL3-BGE-130-ST-DG-1305
NL3-BGE-130-ST-DG-1020	GENERAL ARRANGEMENT PLAN	NL3-BGE-130-ST-DG-1310
NL3-BGE-130-ST-DG-1021	GENERAL ARRANGEMENT ELEVATION	
NL3-BGE-130-ST-DG-1022	GENERAL ARRANGEMENT SECTIONS	NL3-BGE-130-ST-DG-1320
NU 2 DOE 424 OF DE 4424		NL3-BGE-130-ST-DG-1325
NL3-BGE-130-ST-DG-1030 NL3-BGE-130-ST-DG-1031	EMBANKMENT DETAILS EMBANKMENT SECTIONS	NL3-BGE-130-ST-DG-1330
NES-DUE-150-51-DU-1051	LIDANNIENT SECTIONS	
NL3-BGE-130-ST-DG-1040	SITE INVESTIGATION INFORMATION SHEET 1 OF 2	NL3-BGE-130-ST-DG-1340
NL3-BGE-130-ST-DG-1041	SITE INVESTIGATION INFORMATION SHEET FOR 2	NL3-BGE-130-ST-DG-1345
		NL3-BGE-130-ST-DG-1350
NL3-BGE-130-ST-DG-1050	GEOMETRIC DATA	NC2-D0C-120-21-D0-1220
		NL3-BGE-130-ST-DG-1355
SUB-STRUCTURE		
NL3-BGE-130-ST-DG-1060	PILE LAYOUT PLAN AND DETAILS	NL3-BGE-130-ST-DG-1360
NL3-BGE-130-ST-DG-1061	PILE REINFORCEMENT ELEVATIONS AND SECTIONS	
		NL3-BGE-130-ST-DG-1365
NL3-BGE-130-ST-DG-1070 NL3-BGE-130-ST-DG-1071	PRECAST WINGWALL LAYOUT PLAN AND DETAILS PRECAST WINGWALL SECTION AND DETAILS	NL3-BGE-130-ST-DG-1366
NED-DAF-120-31-DA-1071	FRECAST WINDWALL SECTION AND DETAILS	NL3-BGE-130-ST-DG-1367
NL3-BGE-130-ST-DG-1075	PRECAST WINGWALL REINFORCEMENT DETAILS SHEET 1 OF 2	NL3-BGE-130-ST-DG-1370
NL3-BGE-130-ST-DG-1077	PRECAST WINGWALL REINFORCEMENT DETAILS SHEET 2 OF 2	
		NL3-BGE-130-ST-DG-1375
NL3-BGE-130-ST-DG-1080	ABUTMENT No. 1 CONCRETE PLAN AND ELEVATION	NL3-BGE-130-ST-DG-1376
NL3-BGE-130-ST-DG-1085	ABUTMENT No. 2 CONCRETE PLAN AND ELEVATION	
NL3-BGE-130-ST-DG-1086	ABUTMENT CONCRETE SECTIONS AND DETAILS	NL3-BGE-130-ST-DG-1380
		NL3-BGE-130-ST-DG-1381
NL3-BGE-130-ST-DG-1090 NL3-BGE-130-ST-DG-1091	ABUTMENT No. 1 REINFORCEMENT PLAN AND ELEVATION ABUTMENT No. 1 REINFORCEMENT SECTIONS AND DETAILS	
NED-DOE-190-31-DO-1091	ADDITIENT NO. TREINFORCEMENT SECTIONS AND DETAILS	NL3-BGE-130-ST-DG-1385
NL3-BGE-130-ST-DG-1095	ABUTMENT No. 2 REINFORCEMENT PLAN AND ELEVATION	
NL3-BGE-130-ST-DG-1096	ABUTMENT NO. 2 REINEORCEMENT SECTIONS AND DETAILS	NL3-BGE-130-ST-DG-1395
	· · · · · · · · · · · · · · · · · · ·	N N
NL3-BGE-130-ST-DG-1150	PIER NO. 1 CONCRETE PLAN AND ELEVATION	NL3-BGE-130-ST-DG-1400
NL3-BGE-130-ST-DG-1151	PIER No. 2 CONCRETE PLAN AND ELEVATION	NL3-BGE-130-ST-DG-1401
NL3-BGE-130-ST-DG-1152	PIER CONCRETE SECTIONS AND DETAILS	
		NL3-BGE-130-ST-DG-1405
NL3-BGE-130-ST-DG-1155	PIER REINFORCEMENT ELEVATION AND DETAILS	
NL3-BGE-130-ST-DG-1190	BEARINGS PLAN AND NOTES	NL3-BGE-130-ST-DG-1420
NL3-BGE-130-ST-DG-1191	BEARINGS TABLES	
NL3-BGE-130-ST-DG-1192	BEARINGS ATTACHMENT PLATE PLANS AND DETAILS	NL3-BGE-130-ST-DG-1425
		NL3-BGE-130-ST-DG-1430
SUPER-STRUCTURE		
NL3-BGE-130-ST-DG-1200	PRECAST PLANK LAYOUT PLAN AND DETAILS	

NL3-BGE-130-ST-DG-1210 PRECAST PLANK CONCRETE PLAN AND ELEVATION SHEET 1 OF 4 NL3-BGE-130-ST-DG-1211 PRECAST PLANK CONCRETE PLAN AND ELEVATION SHEET 2 OF 4 NL3-BGE-130-ST-DG-1212 PRECAST PLANK CONCRETE PLAN AND ELEVATION SHEET 3 OF 4 NL3-BGE-130-ST-DG-1213 PRECAST PLANK CONCRETE PLAN AND ELEVATION SHEET 4 OF 4

No. ER-STRUCTURE CONT.. 3GE-130-ST-DG-1220

DRAWING TITLE

PRECAST PLANK CONCRETE SECTIONS

PRECAST PLANK PRESTRESS LAYOUT AND NOTES

PRECAST PLANK REINFORCEMENT PLAN AND ELEVATIONS PRECAST PLANK REINFORCEMENT SECTIONS PRECAST PLANK REINFORCEMENT ABUTMENT, PIER END AND INTERNAL DIAPHRAGMS

DECK CONCRETE PLAN DECK CONCRETE DETAILS AND ELEVATIONS DECK CONCRETE SECTIONS AND DETAILS

DECK REINFORCEMENT PLAN

DECK REINFORCEMENT ELEVATIONS DECK REINFORCEMENT SECTIONS AND DETAILS

DECK WATERPROOFING PLAN AND DETAILS DECK WATERPROOFING SECTION AND DETAILS

APPROACH SLAB CONCRETE PLAN AND SECTIONS

APPROACH SLAB REINFORCEMENT PLAN AND SECTIONS

EXPANSION JOINT PLAN AND SECTIONS

COVER PLATE PLAN AND SECTIONS COVER PLATE DETAILS SHEET 1 COVER PLATE DETAILS SHEET 2

BARRIER LAYOUT PLAN AND DETAILS

BARRIER SECTIONS AND DETAILS SHEET 1 OF 2 BARRIER SECTIONS AND DETAILS SHEET 2 OF 2

PRECAST BARRIER PANEL PLANS AND ELEVATIONS SHEET 1 OF 2 PRECAST BARRIER PANEL PLANS AND ELEVATIONS SHEET 2 OF 2

PRECAST PANEL REINFORCEMENT DETAILS

INSITU STITCH POUR DETAILS

TRANSITIONAL BARRIERS DETAILS SHEET 1 TRANSITIONAL BARRIERS DETAILS SHEET 2

TRANSITIONAL BARRIERS REINFORCEMENT DETAILS

PEDESTRIAN BALUSTRADE DETAILS

PRECAST PARAPET PANEL DETAILS

SERVICES LAYOUT PLAN AND SECTIONS


	METADATA		DRAWN A.RIECK 03.04.18	Kellogg Brown & Root Pty Ltd		
	GROUND SURVEY STANDARD: 67-08-43	Perth Office—	DESIGNED J. JAMESON 03.04.18			
	DATE OF CAPTURE:	484 Murray St, Perth WA 6000	CHECKED P. THOMPSON 03.04.18		CDB	
1 PRECAST FORMER WALL PANELS REMOVED PDT 17.04.18	MAPPING SURVEY STANDARD: 67-08-43	P/+61 8 6364 3300	CHECKED P. THOMPSON 05.04.10	Level 15, 300 Murray St, Perth Western Australia 6000		
	DATE OF CAPTURE:	E / info@bgeeng.com	APPROVED P. THOMPSON 02.05.18	Western Australia 6000	CONTRACTORS	INFRASTRUCTURE
U ISSUED FOR CONSTRUCTION PDT 03.04.18		bgeeng.com				
No. DESCRIPTION APPROVED & DATE	MAIN ROADS PROJECT ZONE: PCG94		DRAWING STATUS	R. DENHAM	PROJECT S. NICOLAY	08.05.18 DATE PROJECT Y. SIDDIQUI
AMENDMENTS	HEIGHT DATUM: AHD	BG&E DOC No: P17077	IFC	04.05.18 DATE	DESIGN A. WHITESIDE	07.05.18 PROJECT R. ARNOTT


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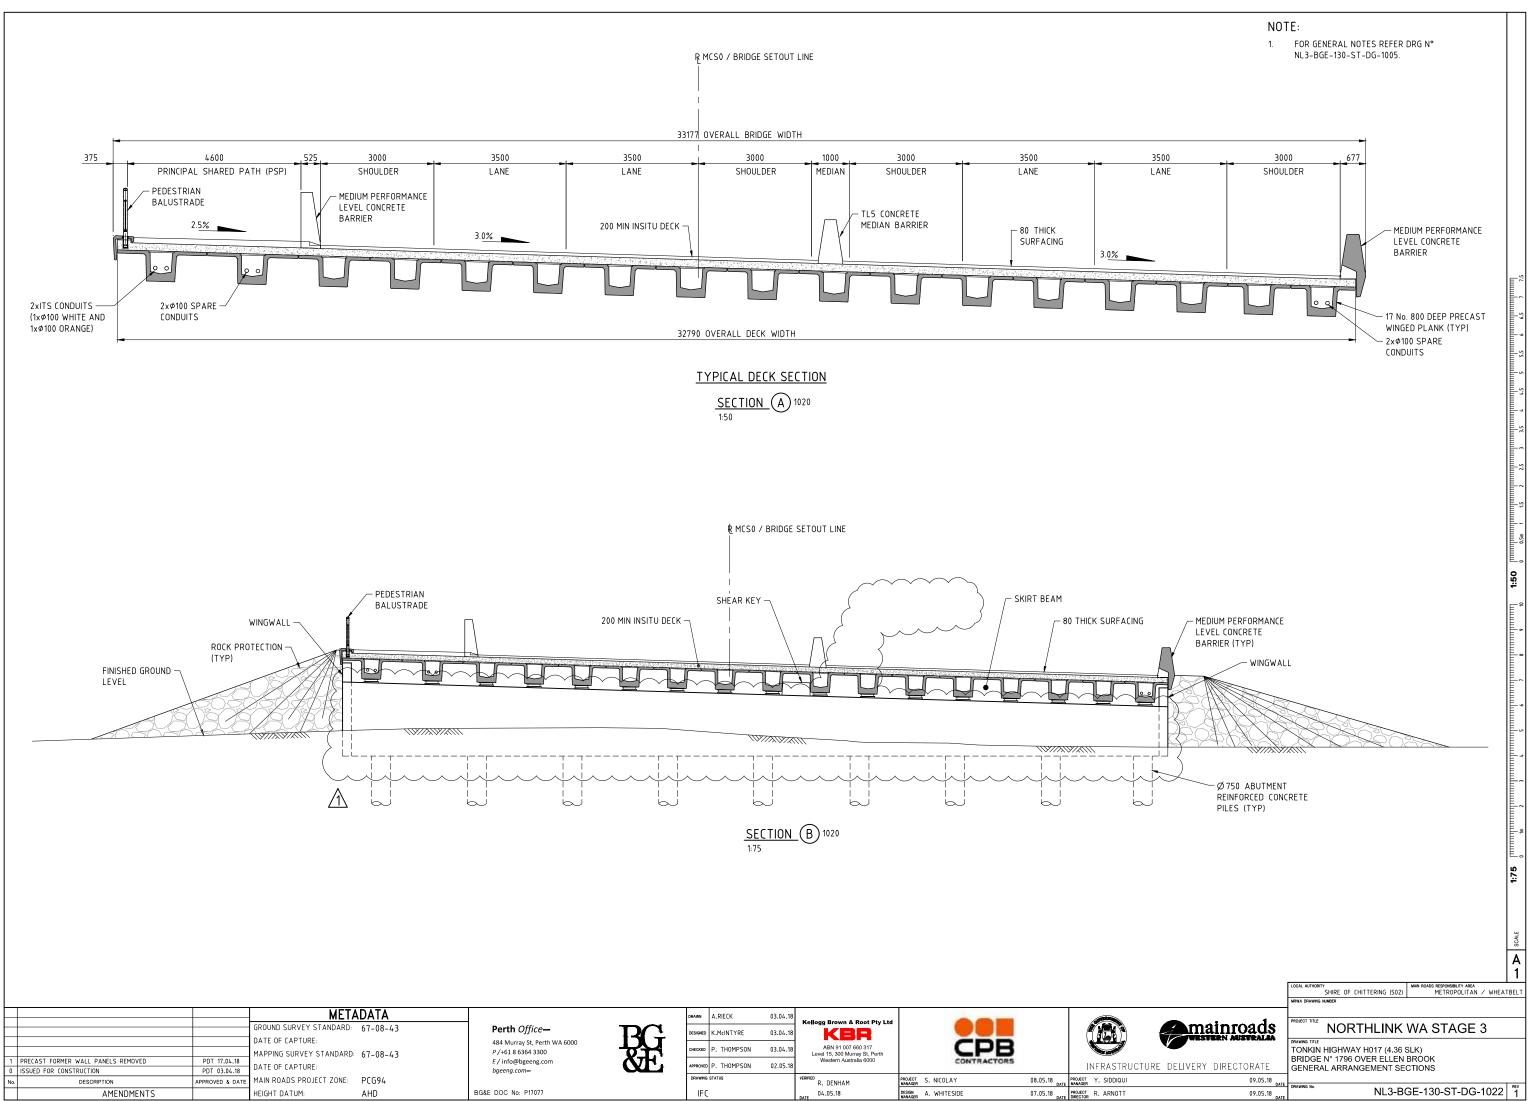
0730-0406-1 0730-0407 0530-1087-1 0530-1307-1

PRECAST PARAPET PANEL DETAILS BRIDGE ACCESS WAY SHEET N° 1 BRIDGE ACCESS WAY SHEET N° 2 BRIDGE BALUSTRADE FOR PRINCIPAL SHARED PATHS - SHEET N° 1 BRIDGE BALUSTRADE FOR PRINCIPAL SHARED PATHS - SHEET N° 2

		A 1
	SHIRE OF CHITTERING (502)	MAIN ROADS RESPONSIBILITY AREA METROPOLITAN / WHEATBELT
	MRWA DRAWING NUMBER	
mainroads	NORTHLINK	WA STAGE 3
RE DELIVERY DIRECTORATE	CRAWING TITLE TONKIN HIGHWAY H017 (4.36 S BRIDGE N° 1796 OVER ELLEN INDEX SHEET	
09.05.18 DATE		
09.05.18		GE-130-ST-DG-1001



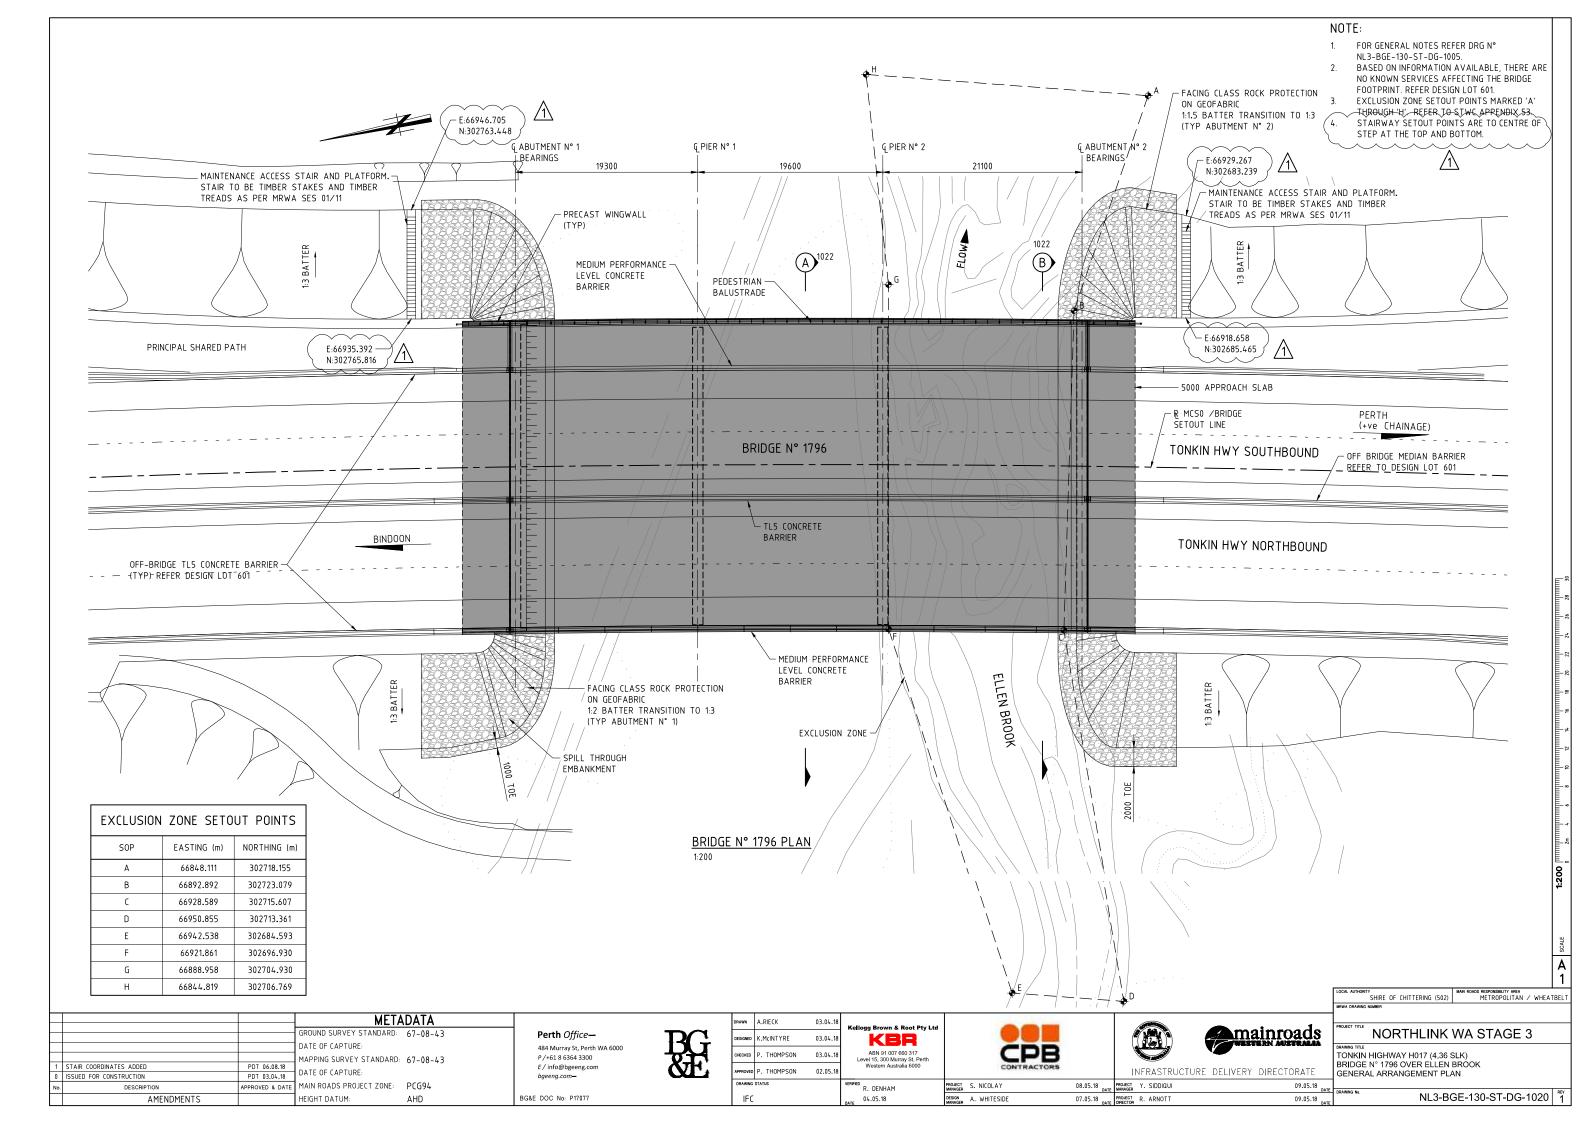

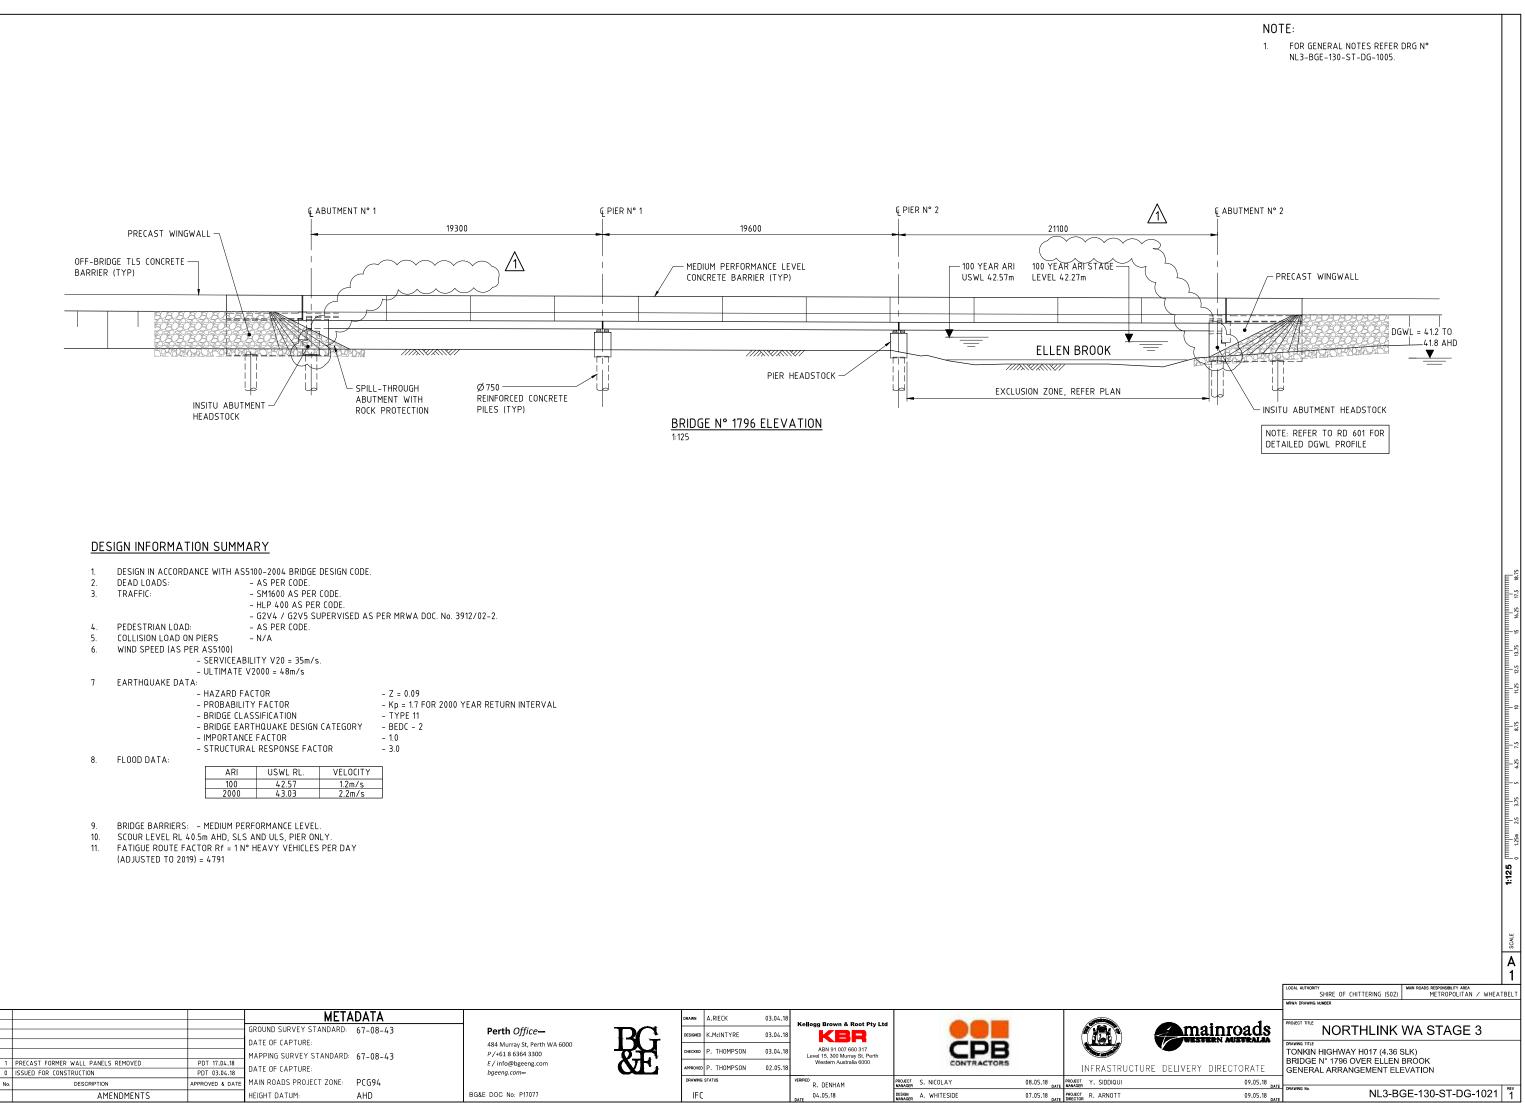

NORTHLINK STAGE 3

NL3-BGE-150-ST-DG-1250

NL3-BGE-150-ST-DG-1260

NL3-BGE-150-ST-DG-1270

NL3-BGE-150-ST-DG-1280

DRAWING INDEX	
DRG No.	DRAWING TITLE
GENERAL	
NL3-BGE-150-ST-DG-1000	COVER SHEET
NL3-BGE-150-ST-DG-1001	INDEX SHEET
NL3-BGE-150-ST-DG-1005	GENERAL NOTES
NL3-BGE-150-ST-DG-1008	CONSTRUCTION NOTES
NL3-BGE-150-ST-DG-1010	DESIGN SUMMARY SHEET 1 OF 3
NL3-BGE-150-ST-DG-1011	DESIGN SUMMARY SHEET 2 OF 3
NL3-BGE-150-ST-DG-1012	DESIGN SUMMARY SHEET 3 OF 3
NL3-BGE-150-ST-DG-1020	GENERAL ARRANGEMENT PLAN
NL3-BGE-150-ST-DG-1021	GENERAL ARRANGEMENT ELEVATION
NL3-BGE-150-ST-DG-1022	GENERAL ARRANGEMENT SECTIONS
NL3-BGE-150-ST-DG-1040	SITE INVESTIGATION INFORMATION SHEET 1 OF 2
NL3-BGE-150-ST-DG-1041	SITE INVESTIGATION INFORMATION SHEET 2 OF 2
NL3-BGE-150-ST-DG-1050	GEOMETRIC DATA
SUB-STRUCTURE	
NL3-BGE-150-ST-DG-1080	ABUTMENT No. 1 MSE WALL PLAN AND ELEVATION
NL3-BGE-150-ST-DG-1081	ABUTMENT No. 2 MSE WALL PLAN AND ELEVATION
NL3-BGE-150-ST-DG-1082	ABUTMENT MSE WALL DETAILS
NL3-BGE-150-ST-DG-1100	ABUTMENT No. 1 FOOTING CONCRETE PLAN AND SECTIONS
NL3-BGE-150-ST-DG-1105	ABUTMENT No. 2 FOOTING CONCRETE PLAN AND SECTIONS
NL3-BGE-150-ST-DG-1110	ABUTMENT No. 1 AND No. 2 FOOTING REINFORCMENT PLAN AND SECTIONS
NL3-BGE-150-ST-DG-1115	PRECAST COLUMN FORMER CONCRETE AND REINFORCEMENT DETAILS
NL3-BGE-150-ST-DG-1120	PRECAST COLUMN FORMER INFILL CONCRETE AND REINFORCEMEN DETAILS
NL3-BGE-150-ST-DG-1125	ABUTMENT No. 1 CAP BEAM CONCRETE PLAN AND ELEVATION
NL3-BGE-150-ST-DG-1127	ABUTMENT No. 2 CAP BEAM CONCRETE PLAN AND ELEVATION
NL3-BGE-150-ST-DG-1128	ABUTMENT No. 1 AND No. 2 CAP BEAM CONCRETE SECTIONS
NL3-BGE-150-ST-DG-1130	ABUTMENT No. 1 AND No. 2 CAP BEAM REINFORCMENT PLAN AND SECTIONS
NL3-BGE-150-ST-DG-1190	BEARINGS PLAN AND NOTES
NL3-BGE-150-ST-DG-1191	BEARINGS SECTIONS AND DETAILS
SUPER-STRUCTURE	
NL3-BGE-150-ST-DG-1200	PRECAST BEAM LAYOUT PLAN AND DETAILS
NL3-BGE-150-ST-DG-1210	PRECAST BEAM CONCRETE PLAN AND BELAILS
NL3-BGE-150-ST-DG-1210	PRECAST BEAM CONCRETE PLAN AND ELEVATION PRECAST BEAM CONCRETE PLANS
NL3-BGE-150-ST-DG-1220	PRECAST BEAM CONCRETE SECTIONS
NL3-BGE-150-ST-DG-1221	PRECAST BEAM CONCRETE SECTIONS AND DETAILS
NL3-BGE-150-ST-DG-1240	PRECAST BEAM PRESTRESS LAYOUT AND NOTES

PRECAST BEAM REINFORCEMENT PLAN AND ELEVATIONS PRECAST BEAM REINFORCEMENT SECTIONS PRECAST BEAM REINFORCEMENT ABUTMENT END DIAPHRAGM PRECAST BEAM REINFORCEMENT INTERNAL DIAPHRAGM

DRG No. SUPER-STRUCTURE (CON'T)

NL3-BGE-150-ST-DG-1300 NL3-BGE-150-ST-DG-1305 NL3-BGE-150-ST-DG-1310

NL3-BGE-150-ST-DG-1315 NL3-BGE-150-ST-DG-1320 NL3-BGE-150-ST-DG-1330

NL3-BGE-150-ST-DG-1340

NL3-BGE-150-ST-DG-1350

NL3-BGE-150-ST-DG-1355

NL3-BGE-150-ST-DG-1360

NL3-BGE-150-ST-DG-1365 NL3-BGE-150-ST-DG-1366

NL3-BGE-150-ST-DG-1370 NL3-BGE-150-ST-DG-1375 NL3-BGE-150-ST-DG-1376

NL3-BGE-150-ST-DG-1380 NL3-BGE-150-ST-DG-1381

NL3-BGE-150-ST-DG-1385 NL3-BGE-150-ST-DG-1395

NL3-BGE-150-ST-DG-1400

NL3-BGE-150-ST-DG-1401

NL3-BGE-150-ST-DG-1405

NL3-BGE-150-ST-DG-1420

NL3-BGE-150-ST-DG-1421

NL3-BGE-150-ST-DG-1425 NL3-BGE-150-ST-DG-1430

NL3-BGE-150-ST-DG-1431

NL3-BGE-150-ST-DG-1450

DRAWING TITLE

DECK CONCRETE PLAN DECK CONCRETE DETAILS AND ELEVATIONS DECK CONCRETE SECTIONS AND DETAILS

DECK REINFORCEMENT PLAN DECK REINFORCEMENT ELEVATIONS DECK REINFORCEMENT SECTIONS AND DETAILS

DECK WATERPROOFING PLAN AND DETAILS

APPROACH SLAB CONCRETE PLAN AND SECTIONS

APPROACH SLAB REINFORCEMENT PLAN AND SECTIONS

EXPANSION JOINT PLAN AND SECTIONS

COVER PLATE PLAN AND SECTIONS COVER PLATE DETAILS

BARRIERLAYOUT PLAN AND DETAILSBARRIERSECTIONS AND DETAILS SHEET 1 OF 2BARRIERSECTIONS AND DETAILS SHEET 2 OF 2

PRECAST PANEL PLANS AND ELEVATIONS SHEET 1 PRECAST PANEL PLANS AND ELEVATIONS SHEET 2

PRECAST PANEL REINFORCEMENT DETAILS

INSITU BARRIER STITCH ELEVATIONS AND DETAILS

TRANSITION BARRIER DETAILS SHEET 1 TRANSITION BARRIER DETAILS SHEET 2

TRANSITION BARRIER REINFORCEMENT DETAILS

PEDESTRIAN BALUSTRADE DETAILS

LIGHT POLE FIXING DETAILS

PRECAST PARAPET PANEL PLAN AND DETAILS

SERVICES LAYOUT PLAN AND SECTIONS SERVICES SECTIONS AND DETAILS

UNDER BRIDGE LIGHTING LAYOUT PLAN AND DETAILS


			MET	ADATA			DRAWN K. TAYLOR	20.04.18	Kellogg Brown & Root Pty Ltd			
			GROUND SURVEY STANDARD:	67-08-43	Perth Office-	DC	DESIGNED C.KANDANARACH	CHI 20.4.18	KBR			
			DATE OF CAPTURE:		484 Murray St, Perth WA 6000				ABN 91 007 660 317	CDP		
			MAPPING SURVEY STANDARD:	67-08-43	P/+61 8 6364 3300		CHECKED P. THOMPSON	20.04.18	Level 15, 300 Murray St, Perth	CPD		
			DATE OF CAPTURE:		E / info@bgeeng.com	ŏ₽Ľ	APPROVED P. THOMPSON	02.05.18	Western Australia 6000	CONTRACTORS		INFRASTRUCTURE
0	ISSUED FOR CONSTRUCTION	PDT 20.04.18	prine of the fone		bgeeng.com-							
No.	DESCRIPTION	APPROVED & DATE	MAIN ROADS PROJECT ZONE:	PCG94			DRAWING STATUS		R. DENHAM	PROJECT S. NICOLAY MANAGER	08.05.18 DATE	PROJECT Y. SIDDIQUI
	AMENDMENTS		HEIGHT DATUM:	AHD	BG&E DOC No: P17077		IFC		04.05.18 DATE	DESIGN A. WHITESIDE	07.05.18 DATE	PROJECT R. ARNOTT


MRWA REFERENCE DRAWINGS


9230-0921-6	LUMINAIRE
0530-1087-1	BRIDGE BAL
0530-1307-1	BRIDGE BAL
0630-1901	BRIDGE LIGH
0430-1314	PRECAST P

LUMINAIRE SUPPORT BRACKET AND COVER PLATE DETAILS BRIDGE BALUSTRADE FOR PRINCIPAL SHARED PATHS - SHEET N° 1 BRIDGE BALUSTRADE FOR PRINCIPAL SHARED PATHS - SHEET N° 2 BRIDGE LIGHT POLE BASE - SHEET N° 1 PRECAST PARAPET PANELS

			A 1
	LOCAL AUTHORITY SHIRE OF CHITTERING (502)	MAIN ROADS RESPONSIBILITY AREA METROPOLITAN / WHEAT	BELT
	MRWA DRAWING NUMBER		
mainroads		WA STAGE 3	
DELIVERY DIRECTORATE	DRAWING TITLE TONKIN HIGHWAY H017 (2.06 S BRIDGE N° 1797 OVER BRAND INDEX SHEET		
09.05.18 DATE	DRAWING No.		REV
09.05.18 DATE	NL3-BC	GE-150-ST-DG-1001	Õ

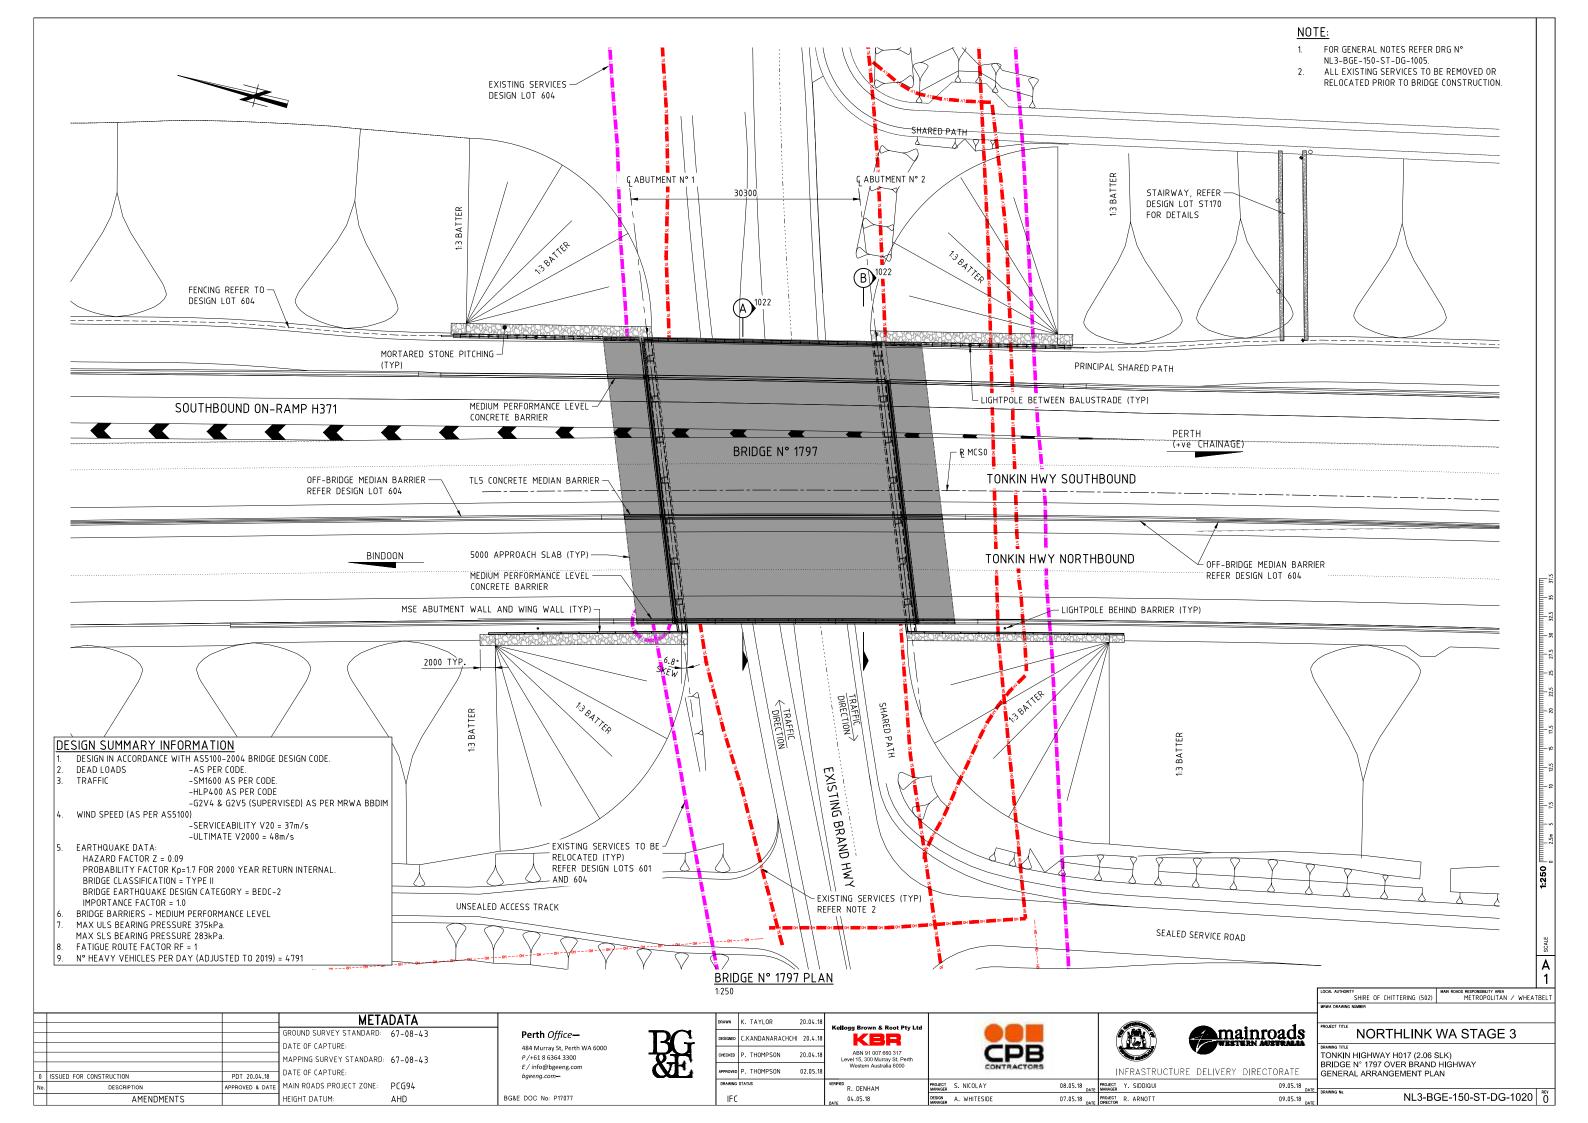

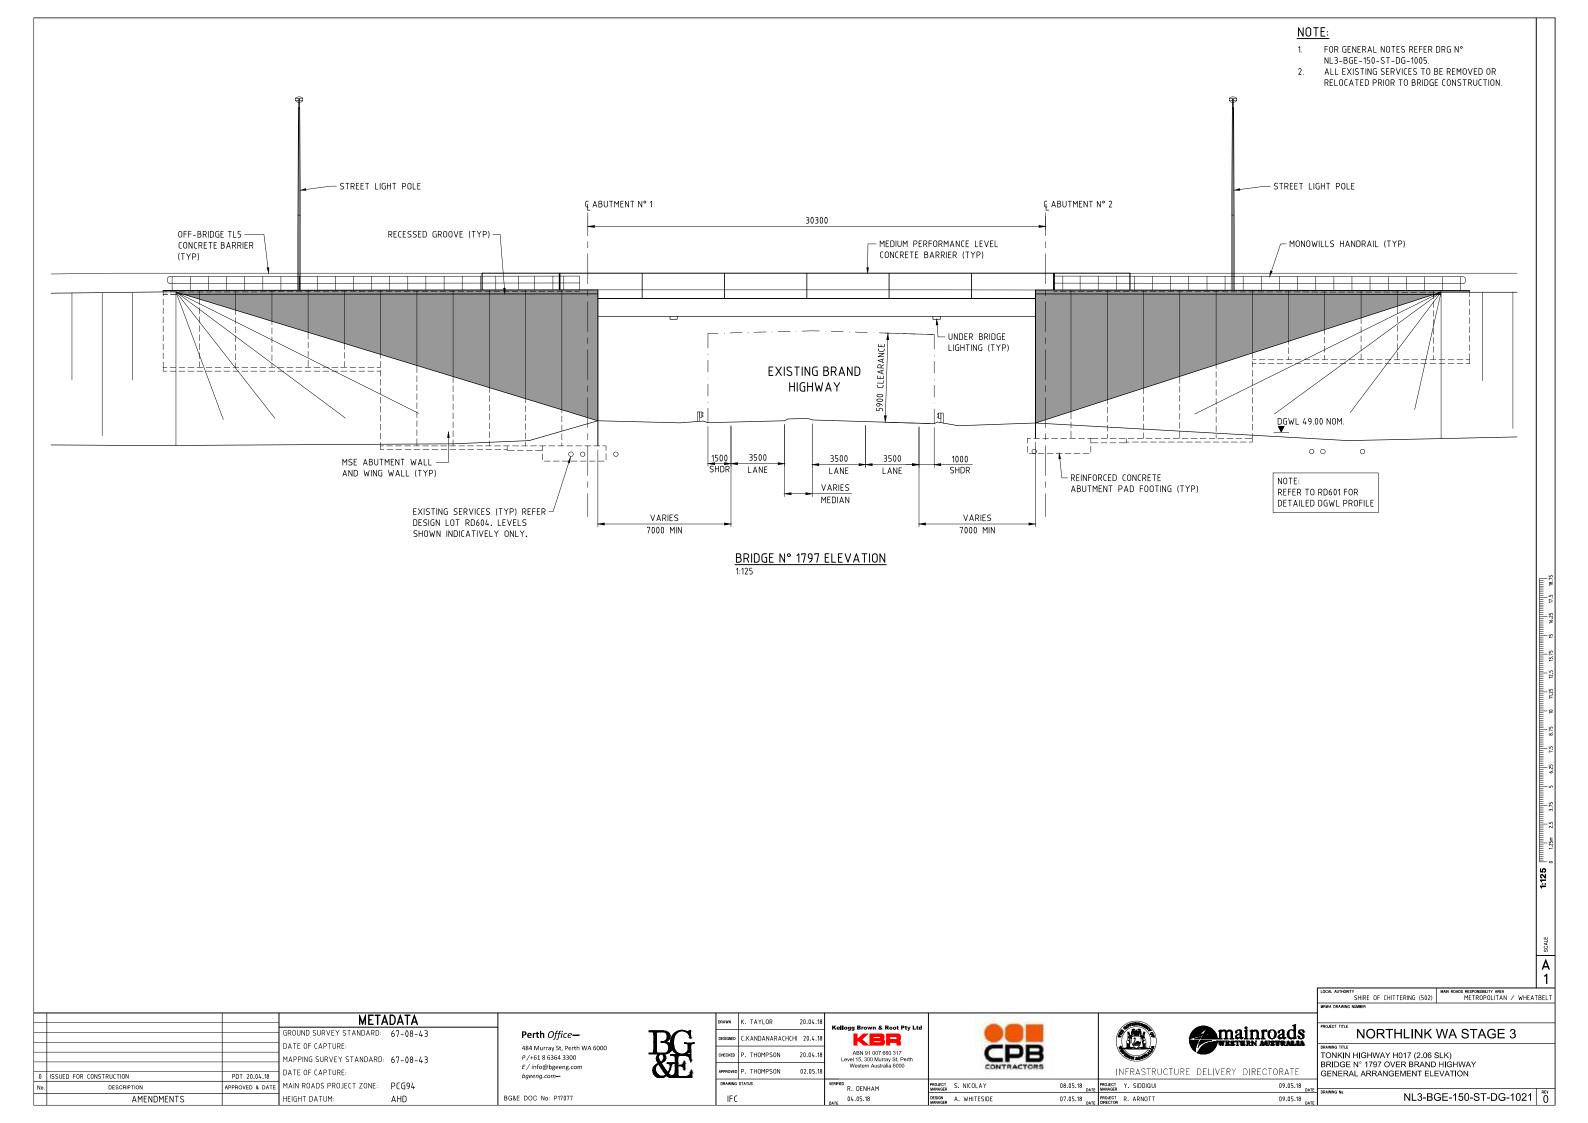

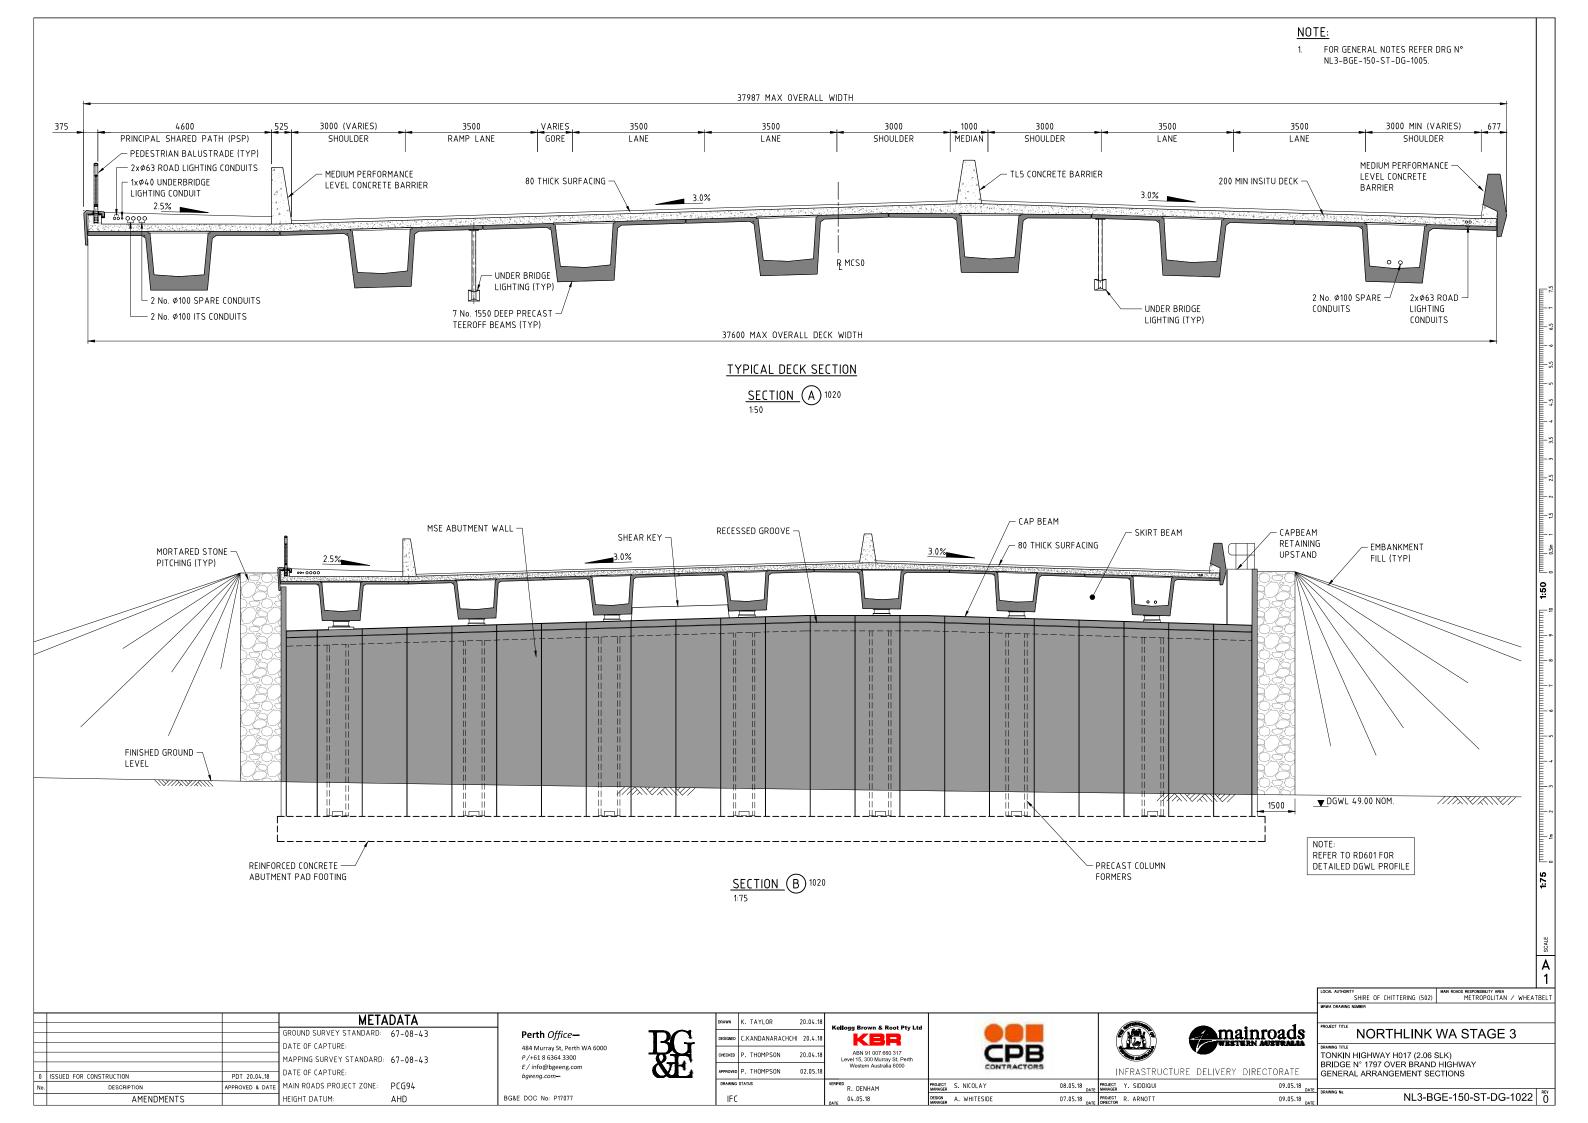

NORTHLINK STAGE 3 DRA

DRAWING INDEX DRG No.	DRAWING TITLE
GENERAL	
NL3-BGE-120-ST-DG-1000	COVER SHEET
NL3-BGE-120-ST-DG-1001	INDEX SHEET
NL3-BGE-120-ST-DG-1005	GENERAL NOTES
NL3-BGE-120-ST-DG-1008	CONSTRUCTION NOTES
NL3-BGE-120-ST-DG-1010	DESIGN SUMMARY SHEET 1 OF 3
NL3-BGE-120-ST-DG-1011	DESIGN SUMMARY SHEET 2 OF 3
NL3-BGE-120-ST-DG-1012	DESIGN SUMMARY SHEET 3 OF 3
NL3-BGE-120-ST-DG-1020	GENERAL ARRANGEMENT PLAN
NL3-BGE-120-ST-DG-1021	GENERAL ARRANGEMENT ELEVATION
NL3-BGE-120-ST-DG-1022	GENERAL ARRANGEMENT SECTIONS
NL3-BGE-120-ST-DG-1030	EMBANKMENT PLAN
NL3-BGE-120-ST-DG-1031	EMBANKMENT SECTIONS
NL3-BGE-120-ST-DG-1040	SITE INVESTIGATION INFORMATION SHEET 1 OF 2
NL3-BGE-120-ST-DG-1041	SITE INVESTIGATION INFORMATION SHEET 2 OF 2
NL3-BGE-120-ST-DG-1050	GEOMETRIC DATA
SUB-STRUCTURE	
NL3-BGE-120-ST-DG-1060	PILE LAYOUT PLAN AND DETAILS
NL3-BGE-120-ST-DG-1061	PILE REINFORCEMENT ELEVATIONS AND SECTIONS
NL3-BGE-120-ST-DG-1070	PRECAST WINGWALL CONCRETE SHEET 1
NL3-BGE-120-ST-DG-1071	PRECAST WINGWALL CONCRETE SHEET 2
NL3-BGE-120-ST-DG-1075	PRECAST WINGWALL REINFORCEMENT SHEET 1
NL3-BGE-120-ST-DG-1076	PRECAST WINGWALL REINFORCEMENT SHEET 2
	TREAST WINGWALE REIN ORCEHENT SHELT 2
NL3-BGE-120-ST-DG-1080	ABUTMENT No. 1 CONCRETE PLAN AND ELEVATION
NL3-BGE-120-ST-DG-1081	ABUTMENT No. 1 CONCRETE PART PLAN AND WINGWALL ELEVATIONS
NL3-BGE-120-ST-DG-1085	ABUTMENT No. 2 CONCRETE PLAN AND ELEVATION
NL3-BGE-120-ST-DG-1086	ABUTMENT No. 2 CONCRETE PART PLAN AND WINGWALL ELEVATIONS
NL3-BGE-120-ST-DG-1087	ABUTMENT CONCRETE SECTION AND DETAILS
NL3-BGE-120-ST-DG-1090	ABUTMENT No. 1 REINFORCEMENT PLANS AND ELEVATION
NL3-BGE-120-ST-DG-1091	ABUTMENT No. 2 REINFORCEMENT PLANS AND ELEVATION
NL3-BGE-120-ST-DG-1092	ABUTMENT REINFORCEMENT DETAILS SHEET 1 OF 3
NL3-BGE-120-ST-DG-1093	ABUTMENT REINFORCEMENT DETAILS SHEET 2 OF 3
NL3-BGE-120-ST-DG-1094	ABUTMENT REINFORCEMENT DETAILS SHEET 3 OF 3

DRG No. SUB-STRUCTURE (CON'T) NL3-BGE-120-ST-DG-1192 NL3-BGE-120-ST-DG-1193

SUPER-STRUCTURE NL3-BGE-120-ST-DG-1200 NL3-BGE-120-ST-DG-1210 NL3-BGE-120-ST-DG-1220 NL3-BGE-120-ST-DG-1221

NL3-BGE-120-ST-DG-1240

NL3-BGE-120-ST-DG-1250 NL3-BGE-120-ST-DG-1260 NL3-BGE-120-ST-DG-1270 NL3-BGE-120-ST-DG-1271 NL3-BGE-120-ST-DG-1280

NL3-BGE-120-ST-DG-1300 NL3-BGE-120-ST-DG-1305

NL3-BGE-120-ST-DG-1320 NL3-BGE-120-ST-DG-1325

NL3-BGE-120-ST-DG-1340

NL3-BGE-120-ST-DG-1350

NL3-BGE-120-ST-DG-1355

NL3-BGE-120-ST-DG-1360

NL3-BGE-120-ST-DG-1365 NL3-BGE-120-ST-DG-1366 NL3-BGE-120-ST-DG-1367

NL3-BGE-120-ST-DG-1370 NL3-BGE-120-ST-DG-1375

NL3-BGE-120-ST-DG-1380

NL3-BGE-120-ST-DG-1430 NL3-BGE-120-ST-DG-1431 NL3-BGE-120-ST-DG-1432

DRAWING TITLE

BEARINGS TYPICAL SECTIONS BEARINGS ATTACHMENT PLATE PLANS AND DETAILS

PRECAST BEAM LAYOUT PLAN AND DETAILS PRECAST BEAM CONCRETE PLAN AND ELEVATION PRECAST BEAM CONCRETE SECTIONS PRECAST BEAM CONCRETE DETAILS

PRECAST BEAM PRESTRESS LAYOUT AND NOTES

PRECAST BEAM REINFORCEMENT PLAN AND ELEVATION PRECAST BEAM REINFORCEMENT SECTIONS PRECAST BEAM REINFORCEMENT ABUTMENT END DIAPHRAGM PRECAST BEAM REINFORCEMENT ABUTMENT END DIAPHRAGM SECTIONS PRECAST BEAM REINFORCEMENT INTERNAL DIAPHRAGM

DECK CONCRETE PLAN AND DETAILS DECK CONCRETE DETAILS AND ELEVATIONS

DECK REINFORCEMENT PLAN AND DETAILS DECK REINFORCEMENT ELEVATIONS AND DETAILS

DECK WATERPROOFING PLAN AND DETAILS

APPROACH SLAB CONCRETE PLAN AND SECTIONS

APPROACH SLAB REINFORCEMENT PLAN AND SECTIONS

EXPANSION JOINT PLAN AND SECTIONS

COVER PLATE PLAN COVER PLATE DETAILS SHEET 1 COVER PLATE DETAILS SHEET 2

BARRIER LAYOUT PLAN AND SECTION BARRIER SECTIONS AND DETAILS

PRECAST PARAPET PANEL DETAILS

SERVICES LAYOUT PLAN SERVICES SECTIONS AND DETAILS LIGHT POLE CONNECTION DETAIL

NL3-BGE-120-ST-DG-1140

INSITU RETAINING WALL CONCRETE SET OUT PLAN AND DETAILS

NL3-BGE-120-ST-DG-1190 NL3-BGE-120-ST-DG-1191

DESCRIPTION

ISSUED FOR CONSTRUCTION

ISSUED FOR CONSTRUCTION

BEARINGS PLAN AND NOTES BEARINGS DETAILS

> Perth Office-484 Murray St, Perth WA 6000 P/+61 8 6364 3300 E / info@bgeeng.com bgeeng.com-



۲	DRAWN	A. RIECK B. GIBBENS	23.03.2018 23.03.2018	Kellogg Brown & Root Pty Ltd			
		P. THOMPSON	23.03.2018	ABN 91 007 660 317 Level 15, 300 Murray St, Perth Western Australia 6000	CPB		A COLOR
1	APPROVED	P. THOMPSON	20.04.2018				INFRASTRUCTURE
	DRAWING	STATUS		R. DENHAM	PROJECT S. NICOLAY	26.04.18 DATE	PROJECT Y. SIDDIQUI MANAGER
	IFC			24.04.18 DATE	DESIGN A. WHITESIDE	26.04.18 DATE	PROJECT R. ARNOTT DIRECTOR

AMENDMENTS

	MEIA	DATA
	GROUND SURVEY STANDARD:	67-08-4
	DATE OF CAPTURE:	
	MAPPING SURVEY STANDARD:	67-08-4
PDT 18.04.2018	DATE OF CAPTURE:	
PDT 23.03.2018	DATE OF CAPTORE:	
APPROVED & DATE	MAIN ROADS PROJECT ZONE:	PCG94
	HEIGHT DATUM:	ΔHD

BG&E DOC No: P17077

MRWA REFERENCE DRAWINGS

0430-0760

0430-0761-1

0430-0762-1

0430-0764-1

0430-0765-2

0530-1456-4

0530-1457-3

0730-0406-1

9331-0376-3

KERB TYPES

0730-0407


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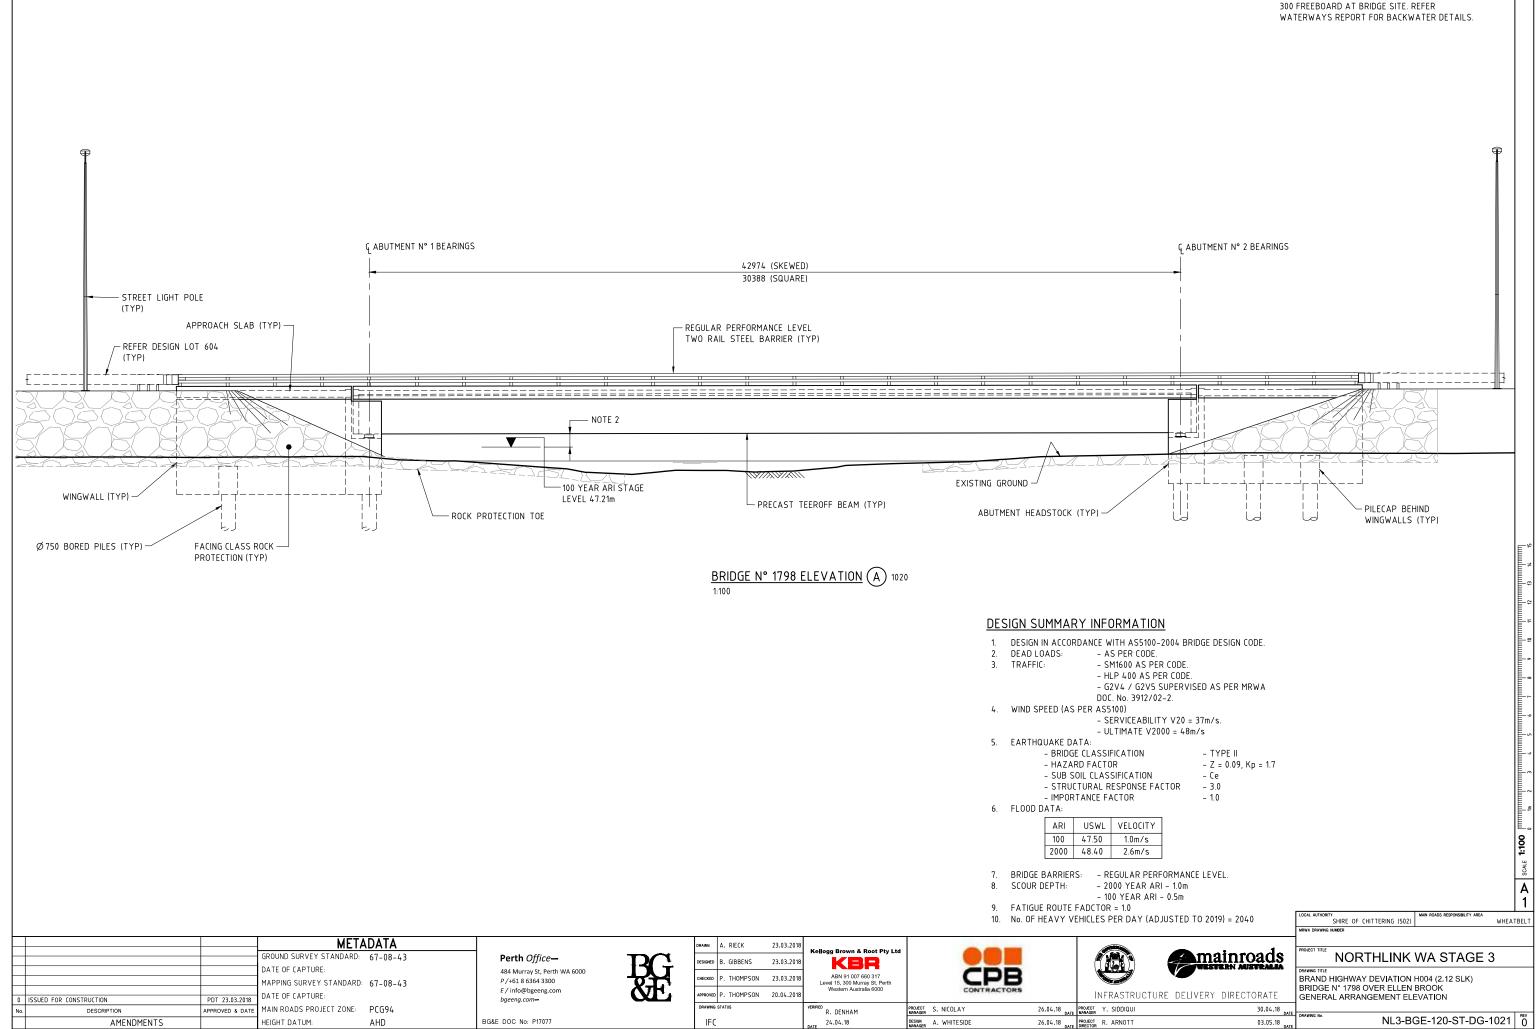
0430-0763

REGULAR PERFORMANCE LEVEL BARRIER RAIL ELEVATIONS AND DETAILS REGULAR PERFORMANCE LEVEL BARRIER TRANSITION RAIL ELEVATIONS REGULAR PERFORMANCE LEVEL BARRIER GUARDRAIL POST DETAILS REGULAR PERFORMANCE LEVEL BARRIER FIXED SPLICE ASSEMBLY DETAILS REGULAR PERFORMANCE LEVEL BARRIER EXPANSION SPLICE ASSEMBLY REGULAR PERFORMANCE LEVEL BARRIER TWO RAIL BARRIER TRANSITION PRECAST PARAPET PANEL DETAILS ROAD-SIDE SLIP BASE AND BRIDGE MOUNTED OCTAGONAL LIGHT POLE DETAILS - SHEET N° 1 ROAD-SIDE SLIP BASE AND BRIDGE MOUNTED OCTAGONAL LIGHT POLE DETAILS - SHEET N° 2 BRIDGE ACCESS WAY SHEET N° 1 BRIDGE ACCESS WAY SHEET N° 2

			1
	LOCAL AUTHORITY SHIRE OF CHITTERING (502)	MAIN ROADS RESPONSIBILITY AREA	TBELT
	MRWA DRAWING NUMBER		
mainroads		WA STAGE 3	
DELIVERY DIRECTORATE	DRAWING TITLE BRAND HIGHWAY DEVIATION BRIDGE N° 1798 OVER ELLEN BI INDEX SHEET		
30.04.18	INDEX SHEET		
03.05.18	DRAWING NO. NL3-BC	GE-120-ST-DG-1001	REV 1


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NOTES:

- 1. FOR GENERAL NOTES REFER DRG N°
- NL3-BGE-120-ST-DG-1005.
- 2. CLEARANCE ALLOWS FOR 300 BACKWATER AND 300 FREEBOARD AT BRIDGE SITE. REFER

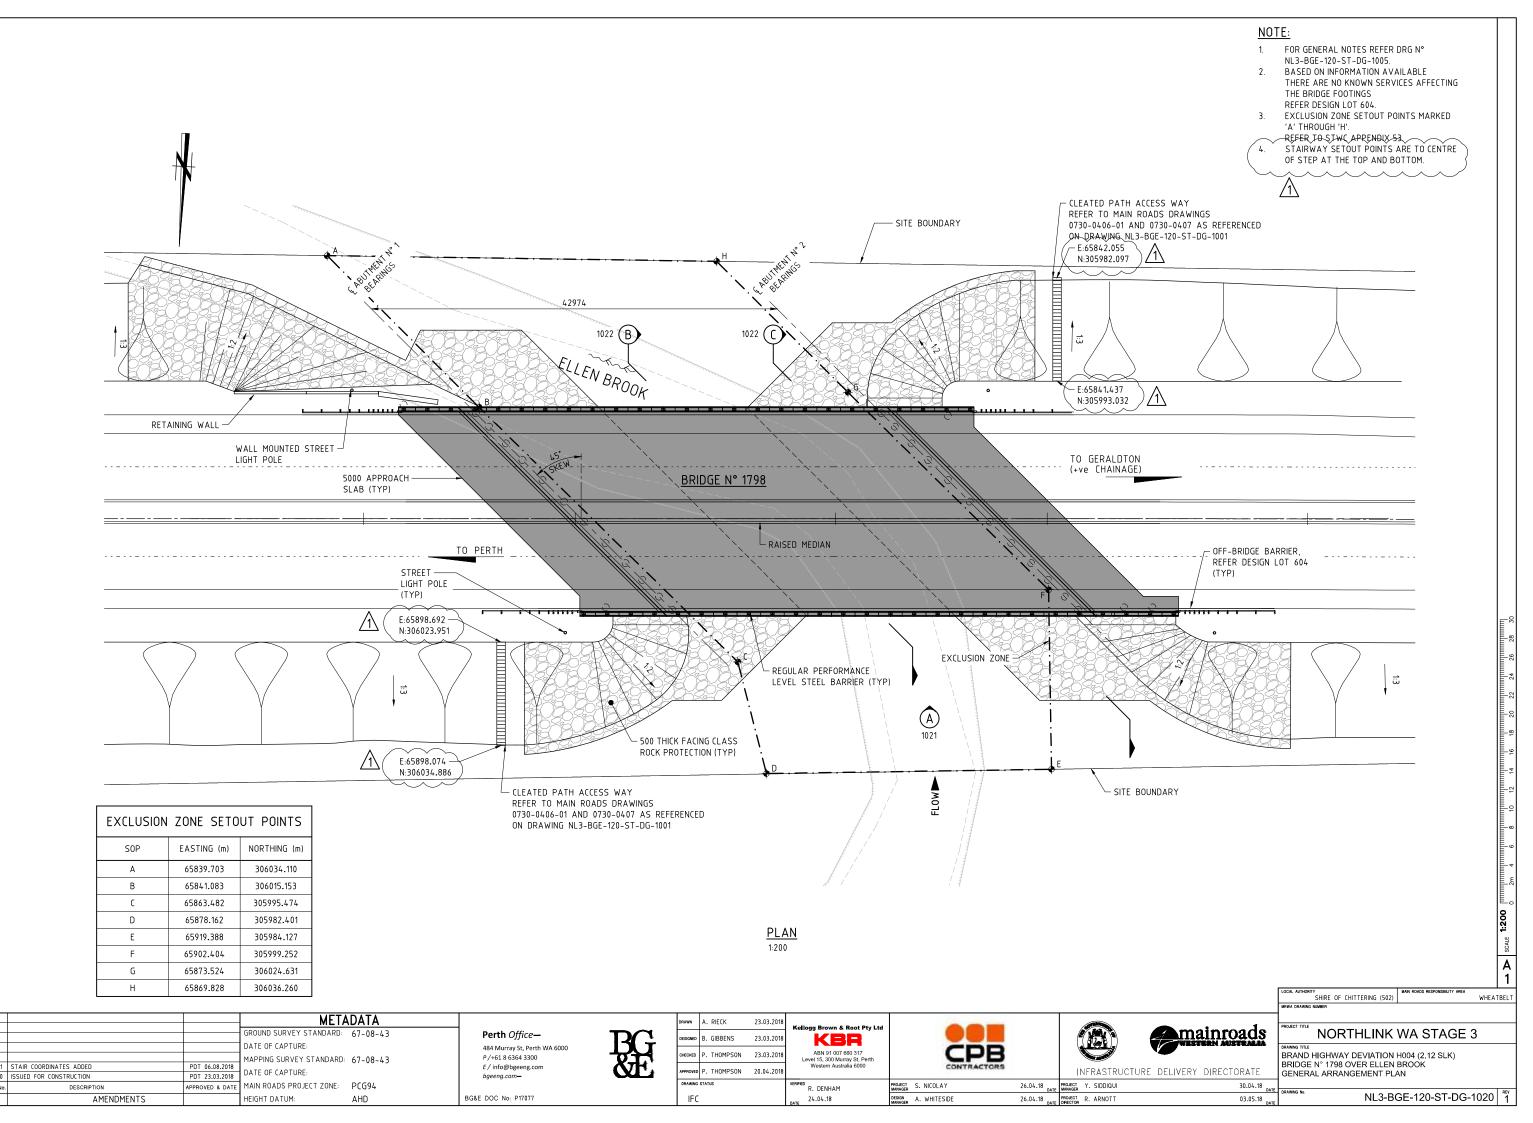

NOTES:

1. FOR GENERAL NOTES REFER DRG N° NL3-BGE-120-ST-DG-1005.

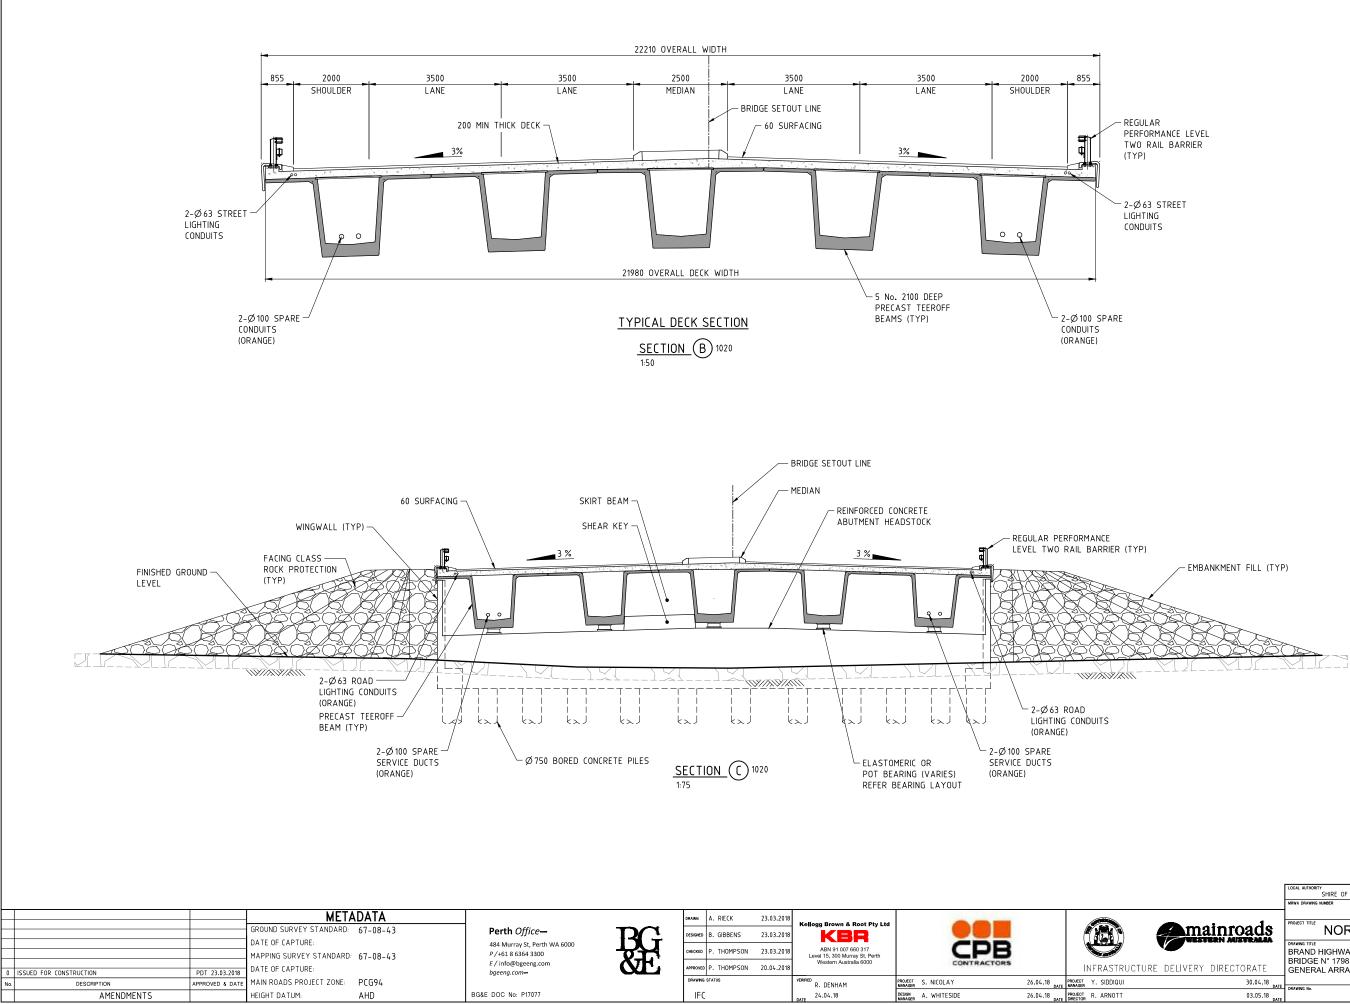			1
	LOCAL AUTHORITY SHIRE OF CHITTERING (502)	MAIN ROADS RESPONSIBILITY AREA WHEA	TBELT
	MRWA DRAWING NUMBER		
mainroads	PROJECT TITLE NORTHLINK	WA STAGE 3	
JRE DELIVERY DIRECTORATE	DRAWING TITLE BRAND HIGHWAY DEVIATION BRIDGE N° 1798 OVER ELLEN GENERAL ARRANGEMENT SE	BROOK	
30.04.18 DATE			
03.05.18	DRAWING No. NL3-B	GE-120-ST-DG-1022	0



NORTHLINK STAGE 3 DRAWING INDEX

DRAWING INDEX				
DRG No.	DRAWING TITLE	DRG No.	DRAWING TITLE	DRG No.
GENERAL		SUB-STRUCTURE (CON'T)		
				SUPER-STRUCTURE (CC
NL3-BGE-160-ST-DG-1000	COVER SHEET	NL3-BGE-160-ST-DG-1190	BEARINGS PLAN AND NOTES	NL3-BGE-160-ST-DG-1381
NL3-BGE-160-ST-DG-1001	INDEX SHEET	NL3-BGE-160-ST-DG-1191	BEARINGS SECTIONS AND DETAILS SHEET 1	NL3-BGE-160-ST-DG-1382
NL3-BGE-160-ST-DG-1005	GENERAL NOTES	NL3-BGE-160-ST-DG-1192	BEARINGS SECTIONS AND DETAILS SHEET 2	NL3-BGE-160-ST-DG-1385
		SUPER-STRUCTURE		NL3-BGE-160-ST-DG-1386
NL3-BGE-160-ST-DG-1008	CONSTRUCTION NOTES SHEET 1	NL3-BGE-160-ST-DG-1200	PRECAST BEAM LAYOUT PLAN AND DETAILS	NES-DOL-100-31-DO-1500
	CONSTRUCTION NOTES SHEET 2			
NL3-BGE-160-ST-DG-1009	CONSTRUCTION NOTES SHEET Z	NL3-BGE-160-ST-DG-1210	PRECAST BEAM CONCRETE PLAN AND ELEVATION SHEET 1 OF 8	NL3-BGE-160-ST-DG-1395
		NL3-BGE-160-ST-DG-1211	PRECAST BEAM CONCRETE PLAN AND ELEVATION SHEET 2 OF 8	
NL3-BGE-160-ST-DG-1010	DESIGN SUMMARY SHEET 1 OF 3	NL3-BGE-160-ST-DG-1212	PRECAST BEAM CONCRETE PLAN AND ELEVATION SHEET 3 OF 8	NL3-BGE-160-ST-DG-1400
NL3-BGE-160-ST-DG-1011	DESIGN SUMMARY SHEET 2 OF 3	NL3-BGE-160-ST-DG-1213	PRECAST BEAM CONCRETE PLAN AND ELEVATION SHEET 4 OF 8	
NL3-BGE-160-ST-DG-1012	DESIGN SUMMARY SHEET 3 OF 3	NL3-BGE-160-ST-DG-1214	PRECAST BEAM CONCRETE PLAN AND ELEVATION SHEET 5 OF 8	NL3-BGE-160-ST-DG-1405
		NL3-BGE-160-ST-DG-1215	PRECAST BEAM CONCRETE PLAN AND ELEVATION SHEET 6 OF 8	
NL3-BGE-160-ST-DG-1020	GENERAL ARRANGEMENT PLAN	NL3-BGE-160-ST-DG-1216	PRECAST BEAM CONCRETE PLAN AND ELEVATION SHEET 7 OF 8	NL3-BGE-160-ST-DG-1430
NL3-BGE-160-ST-DG-1021	GENERAL ARRANGEMENT ELEVATION AND SECTION	NL3-BGE-160-ST-DG-1217	PRECAST BEAM CONCRETE PLAN AND ELEVATION SHEET 8 OF 8	NL3-BGE-160-ST-DG-1431
NL3-BGE-160-ST-DG-1022	GENERAL ARRANGEMENT SECTIONS			NL3-BGE-160-ST-DG-1432
		NL3-BGE-160-ST-DG-1225	PRECAST BEAM CONCRETE SECTIONS - SHEET 1 OF 2	NL3-BGE-160-ST-DG-1433
NL3-BGE-160-ST-DG-1040	SITE INVESTIGATION INFORMATION SHEET 1 OF 2	NL3-BGE-160-ST-DG-1226	PRECAST BEAM CONCRETE SECTIONS – SHEET 2 OF 2	
NL3-BGE-160-ST-DG-1041	SITE INVESTIGATION INFORMATION SHEET 2 OF 2	NL3-BGE-160-ST-DG-1227	PRECAST BEAM CONCRETE SECTIONS AND DETAILS	NL3-BGE-160-ST-DG-1450
NL3-BGE-160-ST-DG-1050	GEOMETRIC DATA	NL3-BGE-160-ST-DG-1240	PRECAST BEAM PRESTRESS LAYOUT AND NOTES - SHEET 1 OF 3	NL3-BGE-160-ST-DG-1470
		NL3-BGE-160-ST-DG-1241	PRECAST BEAM PRESTRESS LAYOUT AND NOTES - SHEET 2 OF 3	
SUB-STRUCTURE		NL3-BGE-160-ST-DG-1242	PRECAST BEAM PRESTRESS LAYOUT AND NOTES - SHEET 3 OF 3	
NL3-BGE-160-ST-DG-1070	ABUTMENT No. 1 MSE WALL PLAN AND ELEVATION	NL3-BGE-160-ST-DG-1245	PRECAST BEAM POST TENSIONING DETAILS	MRWA REFERENCE DRA
NL3-BGE-160-ST-DG-1071	ABUTMENT No. 2 MSE WALL PLAN AND ELEVATION	NES-BGE-100-31-BG-1245		0530-1456-4 ROAD-SIDE
NL3-BGE-160-ST-DG-1072	ABUTMENT DETAILS	NL3-BGE-160-ST-DG-1250	PRECAST BEAM REINFORCEMENT PLAN AND ELEVATIONS SHEET 1 OF 4	0530-1456-3 ROAD-SIDE
NES-DOE-100-51-DO-1072	ADUTHENT DETAILS			9230-0921-6 LUMINAIRE S
		NL3-BGE-160-ST-DG-1251	PRECAST BEAM REINFORCEMENT PLAN AND ELEVATIONS SHEET 2 OF 4	
NL3-BGE-160-ST-DG-1100	ABUTMENT No. 1 FOOTING CONCRETE PLAN AND SECTIONS	NL3-BGE-160-ST-DG-1252	PRECAST BEAM REINFORCEMENT PLAN AND ELEVATIONS SHEET 3 OF 4	
		NL3-BGE-160-ST-DG-1253	PRECAST BEAM REINFORCEMENT PLAN AND ELEVATIONS SHEET 4 OF 4	
NL3-BGE-160-ST-DG-1105	ABUTMENT No. 2 FOOTING CONCRETE PLAN AND SECTIONS			
		NL3-BGE-160-ST-DG-1260	PRECAST BEAM REINFORCEMENT SECTIONS	
NL3-BGE-160-ST-DG-1110	ABUTMENT No. 1 AND No. 2 FOOTING REINFORCMENT PLAN AND SECTIONS			
		NL3-BGE-160-ST-DG-1270	PRECAST BEAM REINFORCEMENT ABUTMENT END DIAPHRAGM	
NL3-BGE-160-ST-DG-1115	PRECAST COLUMN FORMER CONCRETE AND REINFORCEMENT DETAILS	NL3-BGE-160-ST-DG-1271	PRECAST BEAM REINFORCEMENT DIAPHRAGM SECTIONS	
NL3-BGE-160-ST-DG-1120	PRECAST COLUMN FORMER INFILL CONCRETE AND REINFORCEMENT DETAILS	NL3-BGE-160-ST-DG-1280	PRECAST BEAM REINFORCEMENT INTERNAL DIAPHRAGM	
NL3-BGE-160-ST-DG-1130	ABUTMENT N° 1 CAP BEAM CONCRETE PLAN AND ELEVATION	NL3-BGE-160-ST-DG-1290	PRECAST BEAM REINFORCEMENT PIER END DIAPHRAGM	
NL3-BGE-160-ST-DG-1131	ABUTMENT N° 2 CAP BEAM CONCRETE PLAN AND ELEVATION	NL3-BGE-160-ST-DG-1295	PRECAST BEAM CONTINUITY DETAILS	
NL3-BGE-160-ST-DG-1132	ABUTMENT CAP BEAM CONCRETE TYPICAL DETAILS			
		NL3-BGE-160-ST-DG-1300	DECK CONCRETE PLAN	
NL3-BGE-160-ST-DG-1135	ABUTMENT CAP BEAM REINFORCEMENT PLAN AND SECTIONS	NL3-BGE-160-ST-DG-1310	DECK CONCRETE SECTIONS AND DETAILS	
NL3-BGE-160-ST-DG-1140	UPPER WINGWALL SETOUT PLAN	NL3-BGE-160-ST-DG-1320	DECK REINFORCEMENT PLAN	
NL3-BGE-160-ST-DG-1141	UPPER WINGWALL CONCRETE PLANS AND ELEVATIONS SHEET 1	NL3-BGE-160-ST-DG-1321	DECK REINFORCEMENT SECTIONS AND DETAILS	
NL3-BGE-160-ST-DG-1142	UPPER WINGWALL CONCRETE PLANS AND ELEVATIONS SHEET 2	NL3-BGE-160-ST-DG-1322	DECK REINFORCEMENT ELEVATIONS AND DETAILS	
NL3-BGE-160-ST-DG-1143	UPPER WINGWALL CONCRETE TYPICAL DETAILS			
		NL3-BGE-160-ST-DG-1340	DECK WATERPROOFING PLAN AND DETAILS	
NL3-BGE-160-ST-DG-1145	UPPER WINGWALL REINFORCEMENT PLAN, ELEVATION AND SECTION			
		NL3-BGE-160-ST-DG-1350	APPROACH SLAB CONCRETE PLAN AND SECTIONS	
NL3-BGE-160-ST-DG-1150	PILE LAYOUT PLAN AND DETAILS			
NL3-BGE-160-ST-DG-1151	PILE REINFORCEMENT ELEVATIONS AND SECTIONS	NL3-BGE-160-ST-DG-1355	APPROACH SLAB REINFORCEMENT PLAN AND SECTIONS	
NL3-BGE-160-ST-DG-1160	PIER LAYOUT PLANS	NL3-BGE-160-ST-DG-1360	EXPANSION JOINT PLAN AND SECTIONS	
NL3-BGE-160-ST-DG-1161	PIER No. 1 CONCRETE PLAN AND SECTIONS			
NL3-BGE-160-ST-DG-1162	PIER No. 2 CONCRETE PLAN AND SECTIONS	NL3-BGE-160-ST-DG-1365	COVER PLATE PLAN AND SECTIONS	
NL3-BGE-160-ST-DG-1163	PIER No. 3 CONCRETE PLAN AND SECTIONS	NL3-BGE-160-ST-DG-1366	COVER PLATE DETAILS	
······				
NL3-BGE-160-ST-DG-1165	TYPICAL DEFLECTION WALL REINFORCEMENT ELEVATION AND DETAILS	NL3-BGE-160-ST-DG-1370	BARRIER LAYOUT PLAN AND DETAILS	
NL3-BGE-160-ST-DG-1166	TYPICAL PIER WALL REINFORCEMENT ELEVATION AND DETAILS			
NL3-BGE-160-ST-DG-1167	PIER COLUMN REINFORCEMENT ELEVATION, PLAN AND SECTIONS	NL3-BGE-160-ST-DG-1375	BARRIER SECTIONS AND DETAILS	
		NL3-BGE-160-ST-DG-1380	PRECAST PANEL PLANS AND ELEVATIONS SHEET 1 OF 3	
	ΜΕΤΑΠΑΤΑ		PRIME K TAVIOD 12.0/ 19	
	MEIANAIA		DRAWN K TAYLOD 12.0/.19	

			METADATA				
			GROUND SURVEY STANDARD:	67-08-43			
			DATE OF CAPTURE:				
			MAPPING SURVEY STANDARD:	67-08-43			
			DATE OF CAPTURE:				
0	ISSUED FOR CONSTRUCTION	PDT 12.04.18	DATE OF CAPTURE:				
No.	DESCRIPTION	APPROVED & DATE	MAIN ROADS PROJECT ZONE:	PCG94			
	AMENDMENTS		HEIGHT DATUM:	AHD			

Perth *Office*— 484 Murray St, Perth WA 6000 *P*/+61 8 6364 3300 *E*/info@bgeeng.com *bgeeng.com*—

BG&E DOC No: P17077




DRAWN K. TAYLOR 12.04.18 Kellogg Brown & Root Pty Ltd DESIGNED H. ALGUIRE 12.04.18 KBR ABN 91 007 660 317 Level 15, 300 Murray St, Perth Western Australia 6000 CHECKED P. THOMPSON 12.04.18 Approved P. THOMPSON 07.06.18 Drawing status INFRASTRUCTU 14.06.18 PROJECT Y. SIDDIQUI R. DENHAM PROJECT C. SAXON MANAGER C. SAXON DESIGN A. WHITESIDE IFC 11.06.18


	DRAWING TITLE							
(CON'T)								
	PRECAST PANEL PLANS AND ELEVATIONS SHEET 2 OF 3							
	PRECAST PANEL PLANS AND ELEVATIONS SHEET 3 OF 3							
	PRECAST PANEL REINFORCEMENT SHEET 1 OF 2							
	PRECAST PANEL REINFORCEMENT SHEET 2 OF 2							
	INSITU BARRIER STITCH ELEVATION AND DETAILS							
	TRANSITION BARRIER DETAILS							
	TRANSITION BARRIER REINFORCEMENT DETAILS							
	SERVICES LAYOUT PLAN							
	SERVICES TYPICAL SECTIONS							
	LIGHT POLE DETAILS							
	LIGHT POLE JUNCTION BOX DETAILS							
	UNDER BRIDGE LIGHTING LAYOUT PLAN AND DETAILS							
	HARD LANDSCAPING LAYOUT PLAN AND DETAILS							

RAWINGS


SIDE SLIP-BASE AND BRIDGE MOUNTED OCTAGONAL LIGHT POLE DETAILS – SHEET N° 1 SIDE SLIP-BASE AND BRIDGE MOUNTED OCTAGONAL LIGHT POLE DETAILS – SHEET N° 2 IRE SUPPORT BRACKET AND COVER PLATE DETAILS

		Roote A									
	LOCAL AUTHORITY SHIRE OF CHITTERING (502) MRWA DRAWING NUMBER	MAIN ROADS RESPONSIBILITY AREA WHEATBELT									
mainroads	mainroads NORTHLINK WA STAGE 3										
RE DELIVERY DIRECTORATE	BRAND HWY DEVIATION H004 (3.28 SLK) BRIDGE N° 1799 OVER EXISTING BRAND HWY AND RAILWAY INDEX SHEET										
19.06.18 DATE	DRAWING No.	REV									
28.06.18	NL3-B	GE-160-ST-DG-1001 👸									

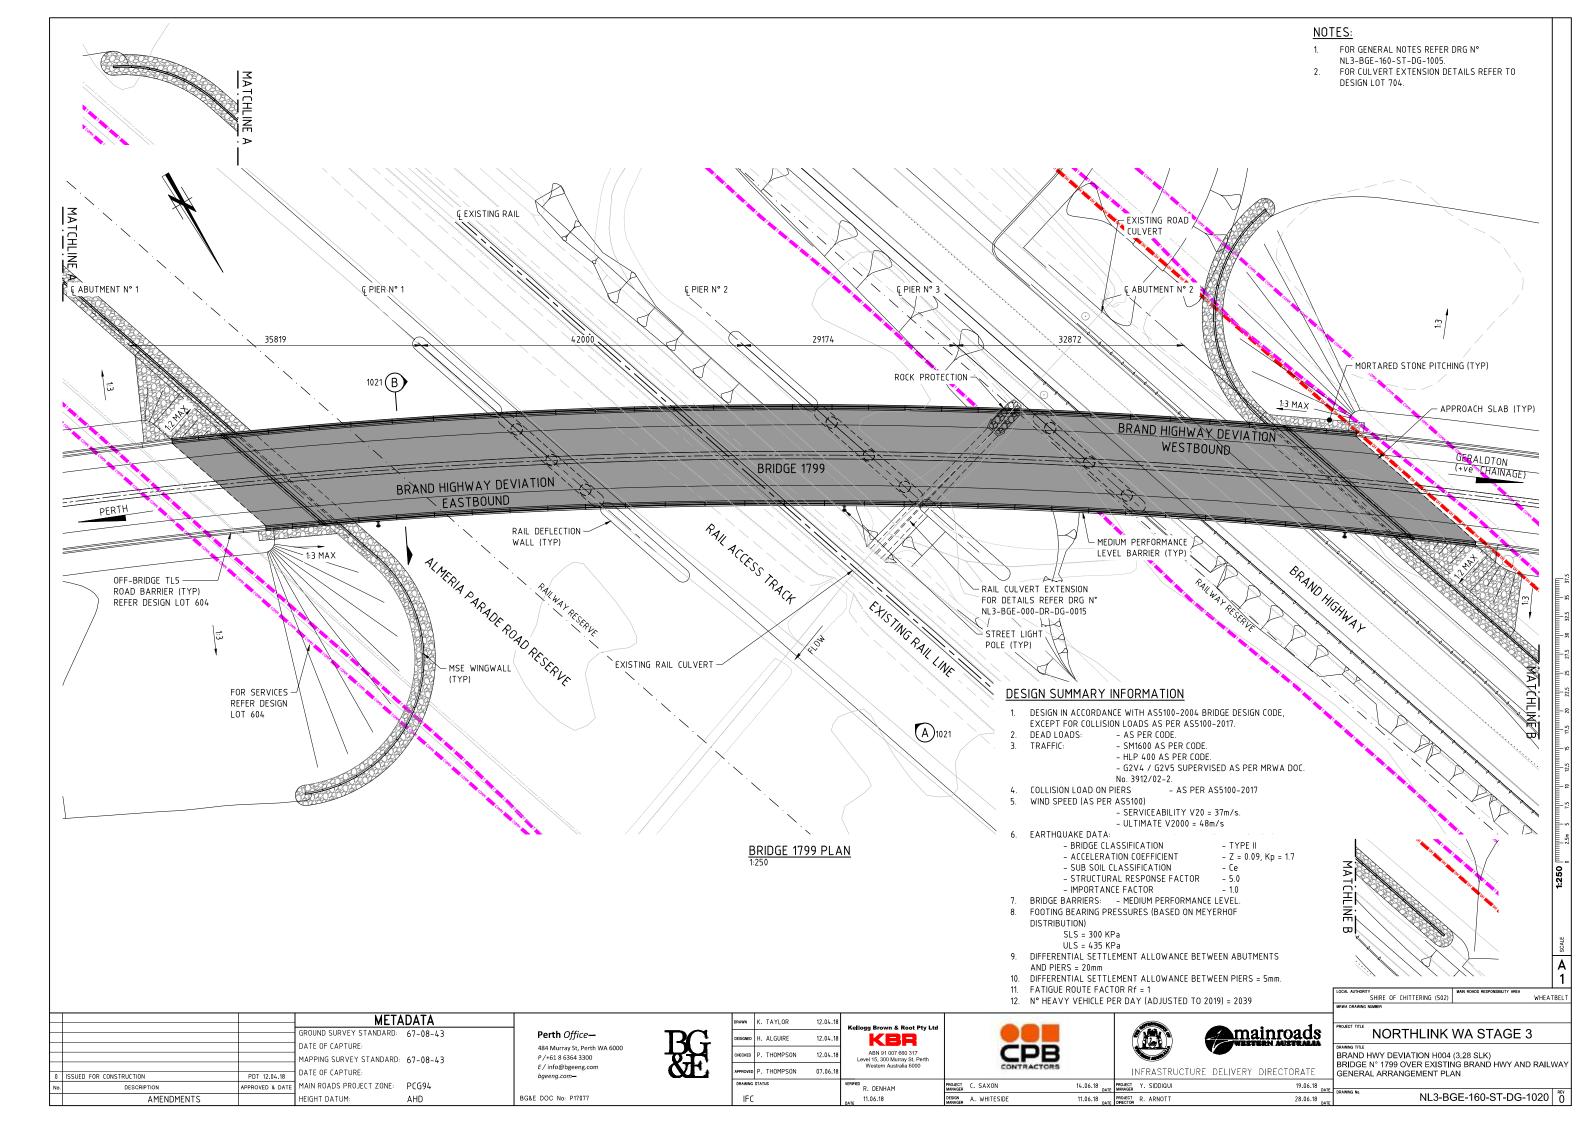

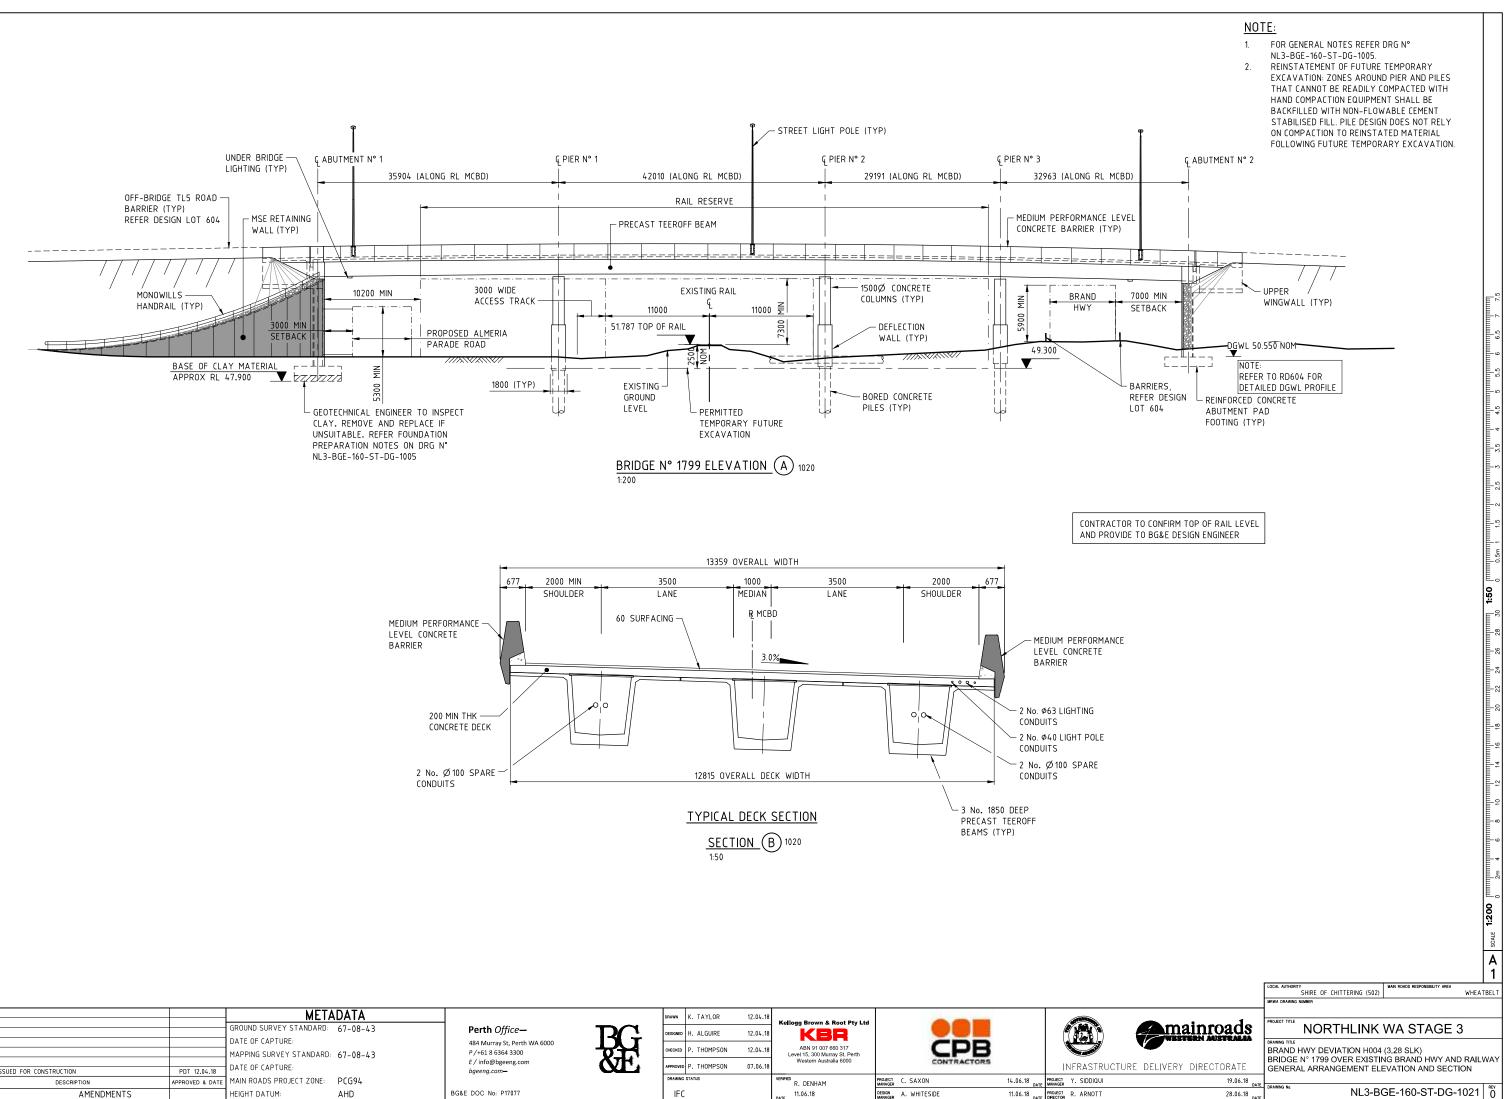

			MET	ADATA			DRAWN K. TAYLOR	12.04.18					
_			GROUND SURVEY STANDARD:		Perth Office—				Kellogg Brown & Root Pty Ltd				
-			DATE OF CAPTURE:		484 Murray St, Perth WA 6000	-4(÷	DESIGNED H. ALGUIRE	12.04.18	KBR				
-			MAPPING SURVEY STANDARD	67-08-/3	P/+61 8 6364 3300		CHECKED P. THOMPSON	12.04.18	ABN 91 007 660 317 Level 15, 300 Murray St. Perth	CPB			
			DATE OF CAPTURE:	07-00-45	E / info@bgeeng.com	ŇT.	APPROVED P. THOMPSON	07.06.18	Western Australia 6000	CONTRACTORS			RASTRUCTURE
	0 ISSUED FOR CONSTRUCTION	PDT 12.04.18	DATE OF CAPTORE:		bgeeng.com-		ATTICIES T. THOTH SON	07.00.10				IINI	ASTRUCTURE
	No. DESCRIPTION	APPROVED & DATE	MAIN ROADS PROJECT ZONE:	PCG94			DRAWING STATUS		R. DENHAM	PROJECT C. SAXON	14.06.18 DAT	PROJECT Y.	SIDDIQUI
	AMENDMENTS		HEIGHT DATUM:	AHD	BG&E DOC No: P17077		IFC		DATE 11.06.18	DESIGN A. WHITESIDE	11.06.18 DAT	PROJECT R.	ARNOTT

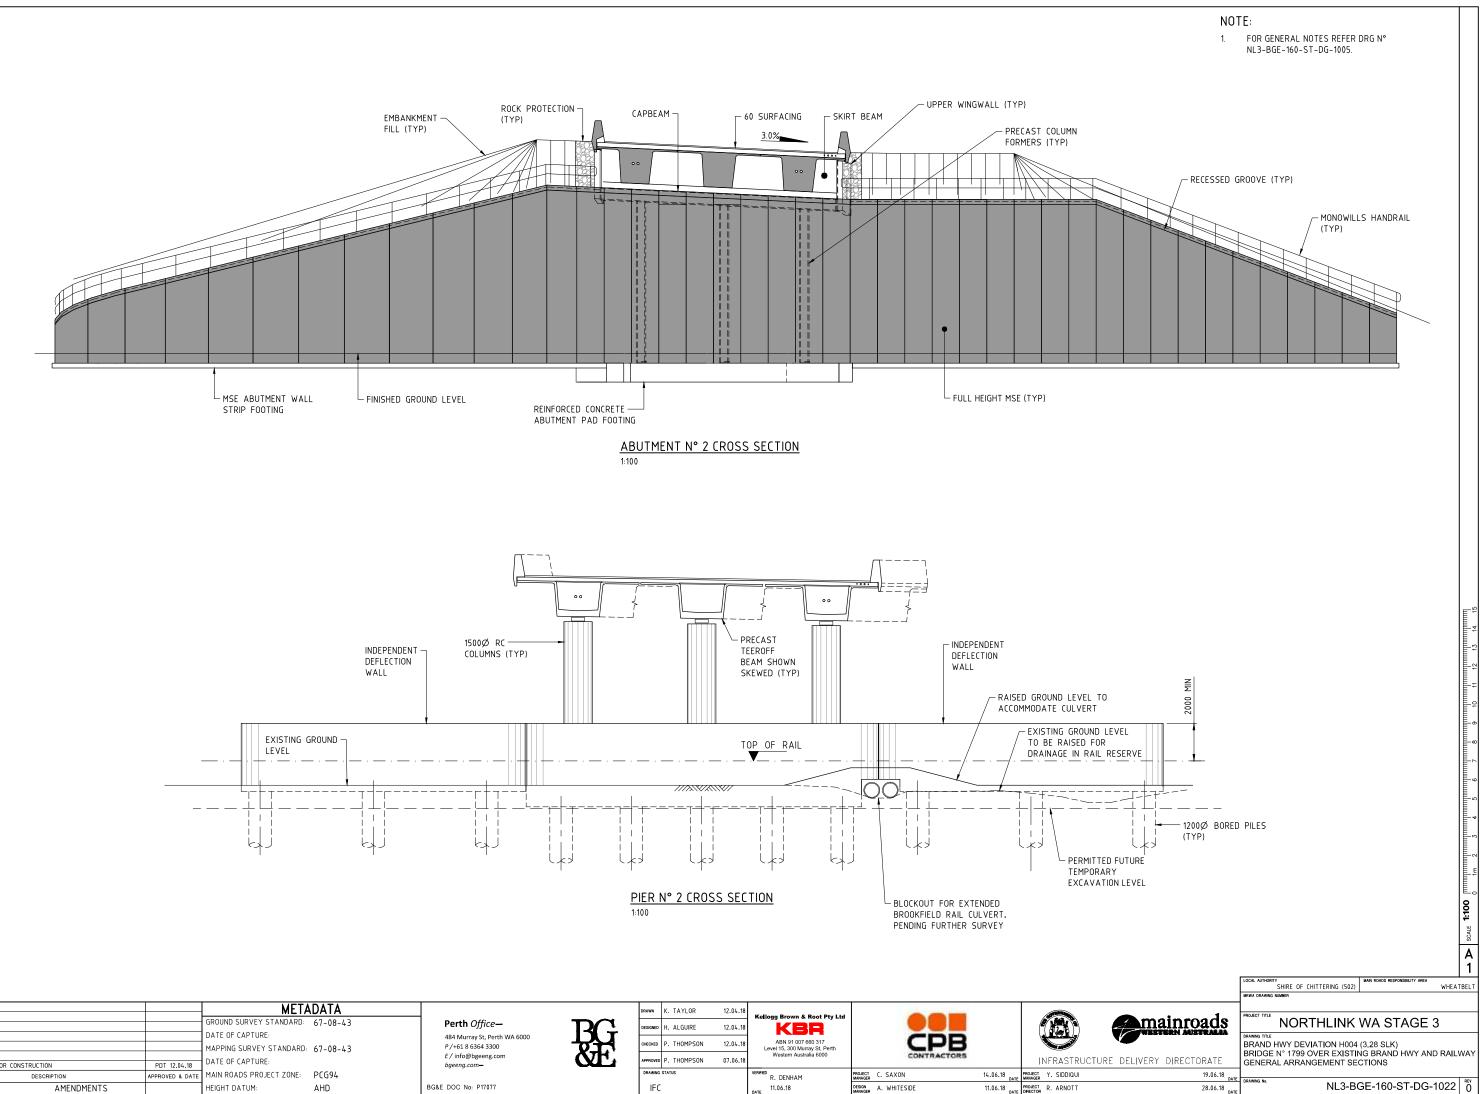

F			META	ADATA			DRAWN	K. TAYLOR	12.04.18	Kellogg Brown & Root Pty Ltd				
			GROUND SURVEY STANDARD:	67-08-43	Perth Office—		DESIGNED	H. ALGUIRE	12.04.18					
			DATE OF CAPTURE:		484 Murray St, Perth WA 6000	DU		P. THOMPSON		ABN 91 007 660 317	CDP			
			MAPPING SURVEY STANDARD:	67-08-43	P /+61 8 6364 3300 E / info@bgeeng.com	7.5	CHECKED	P. THUMPSON	12.04.18	Level 15, 300 Murray St, Perth Western Australia 6000	CONTRACTORS			
	0 ISSUED FOR CONSTRUCTION	PDT 12.04.18	DATE OF CAPTURE:		bgeeng.com-	QE	APPROVED	P. THOMPSON	07.06.18		CONTRACTORS			INFRASTRUCTURE
Ī	No. DESCRIPTION	APPROVED & DATE	MAIN ROADS PROJECT ZONE:	PCG94			DRAWING S	STATUS		R. DENHAM	PROJECT C. SAXON	14.06.18 DATE	PROJECT MANAGER	Y. SIDDIQUI
Ī	AMENDMENTS		HEIGHT DATUM:	AHD	BG&E DOC No: P17077		IFC			11.06.18 DATE	DESIGN A. WHITESIDE	11.06.18 DATE		R. ARNOTT

	METADATA		A.RIECK 15.02.18	
NL3-BGE-230-ST-DG-1270	PRECAST PLANK REINFORCEMENT ABUTMENT & INTERNAL DIAPHRAGMS			
NL3-BGE-230-ST-DG-1260	PRECAST PLANK REINFORCEMENT SECTIONS			
NL3-BGE-230-ST-DG-1250	PRECAST PLANK REINFORCEMENT PLAN AND SECTION			
NL3-BGE-230-ST-DG-1240	PRECAST PLANK PRESTRESS LAYOUT AND NOTES			
NL3-BGE-230-ST-DG-1210 NL3-BGE-230-ST-DG-1220	PRECAST PLANK CONCRETE PLAN AND SECTIONS PRECAST PLANK CONCRETE SECTIONS AND DETAILS			
NL3-BGE-230-ST-DG-1200	PRECAST PLANK LAYOUT PLAN AND DETAILS			
SUPER-STRUCTURE				
NL3-BGE-230-ST-DG-1191	BEARINGS SECTIONS AND DETAILS			
NL3-BGE-230-ST-DG-1190	BEARINGS PLAN AND NOTES			
NL3-BGE-230-ST-DG-1130	ABUTMENT No. 1 & No. 2 CAPBEAM REINFORCEMENT PLAN AND SECTIONS			
NL3-BGE-230-ST-DG-1127	ABUTMENT No. 2 CAP BEAM CONCRETE PLAN AND ELEVATION	NL3-BGE-230-ST-DG-1450	UNDER BRIDGE LIGHTING LAYOUT PLAN AND DETAILS	
NL3-BGE-230-ST-DG-1125	ABUTMENT No. 1 CAP BEAM CONCRETE PLAN, ELEVATION AND SECTIONS	NL3-BGE-230-ST-DG-1431	SERVICES SECTIONS AND DETAILS	
NL3-BGE-230-ST-DG-1120	DETAILS	NL3-BGE-230-ST-DG-1430	SERVICES LAYOUT PLAN	
	DETAILS PRECAST COLUMN FORMER INFILL CONCRETE AND REINFORCEMENT	NL3-BGE-230-ST-DG-1400 NL3-BGE-230-ST-DG-1401	INSITU TRANSITION BARRIER ELEVATION AND DETAILS INSITU TRANSITION BARRIER REINFORCEMENT DETAILS	
NL3-BGE-230-ST-DG-1115	PRECAST COLUMN FORMER CONCRETE AND REINFORCEMENT	NL3-BGE-230-ST-DG-1395	INSITU BARRIER STITCH ELEVATION AND DETAILS	
NL3-BGE-230-ST-DG-1110	ABUTMENT No. 1 AND No. 2 FOOTING REINFORCEMENT PLAN AND SECTIONS	NL3-BGE-230-ST-DG-1385	PRECAST PANEL REINFORCEMENT DETAILS	
NL3-BGE-230-ST-DG-1105	ABUTMENT No. 2 FOOTING CONCRETE PLAN AND SECTIONS	NL3-BGE-230-ST-DG-1380 NL3-BGE-230-ST-DG-1381	PRECAST PANEL PLANS AND ELEVATIONS – SHEET 1 PRECAST PANEL PLANS AND ELEVATIONS – SHEET 2	
NL3-BGE-230-ST-DG-1100	ABUTMENT No. 1 FOOTING CONCRETE PLAN AND SECTIONS	NL3-BGE-230-ST-DG-1375	BARRIER SECTIONS AND DETAILS	
NL3-BGE-230-ST-DG-1081 NL3-BGE-230-ST-DG-1082	ABUTMENT No. 2 MSE WALL PLAN AND ELEVATION ABUTMENT MSE WALL DETAILS	NL3-BGE-230-ST-DG-1370	BARRIER LAYOUT PLAN AND DETAILS	
NL3-BGE-230-ST-DG-1080	ABUTMENT No. 1 MSE WALL PLAN AND ELEVATION	NI 2 DEE 220 ST DE 1270		
SUB-STRUCTURE		NL3-BGE-230-ST-DG-1365 NL3-BGE-230-ST-DG-1366	COVER PLATE PLAN AND SECTIONS COVER PLATE DETAILS	
NL3-BGE-230-ST-DG-1050	GEOMETRIC DATA	NL3-BGE-230-ST-DG-1360	EXPANSION JOINT PLAN AND SECTIONS	
NL3-BGE-230-ST-DG-1040 NL3-BGE-230-ST-DG-1041	SITE INVESTIGATION INFORMATION SHEET 1 OF 2 SITE INVESTIGATION INFORMATION SHEET 2 OF 2	NL3-BGE-230-ST-DG-1355	APPROACH SLAB REINFORCEMENT PLAN AND SECTIONS	
NL3-BGE-230-ST-DG-1022		NL3-BGE-230-ST-DG-1350	APPROACH SLAB CONCRETE PLAN AND DETAILS	
NL3-BGE-230-ST-DG-1021	GENERAL ARRANGEMENT ELEVATION			
NL3-BGE-230-ST-DG-1020	GENERAL ARRANGEMENT PLAN	NL3-BGE-230-ST-DG-1340	DECK WATERPROOFING PLAN AND DETAILS	
		NL3-BGE-230-ST-DG-1330	DECK REINFORCEMENT SECTIONS AND DETAILS	
		NL3-BGE-230-ST-DG-1320	DECK REINFORCEMENT ELEVATION	
NL3-BGE-230-ST-DG-1008	CONSTRUCTION NOTES	NL3-BGE-230-ST-DG-1315	DECK REINFORCEMENT PLAN	
NL3-BGE-230-ST-DG-1005	GENERAL NOTES	NL3-BGE-230-ST-DG-1310	DECK CONCRETE SECTIONS AND DETAILS	
NL3-BGE-230-ST-DG-1001	INDEX SHEET	NL3-BGE-230-ST-DG-1300	DECK CONCRETE PLAN AND DETAILS	7250 0721 O
GENERAL NL3-BGE-230-ST-DG-1000	COVER SHEET	SUPER-STRUCTURE (CON'T)		MRWA REF 9230-0921-6
	DRAWING TITLE	DRG No.	DRAWING TITLE	
DRG No.		DDCN		

			METADATA			
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			DATE OF CAPTURE:			
			MAPPING SURVEY STANDARD:	67-08-43		
0	ISSUED FOR CONSTRUCTION	PDT 15.02.18	DATE OF CAPTURE:			
No.	DESCRIPTION	APPROVED & DATE	MAIN ROADS PROJECT ZONE:	PCG94		
	AMENDMENTS		HEIGHT DATUM:	AHD		

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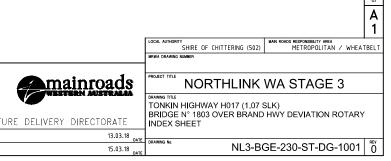
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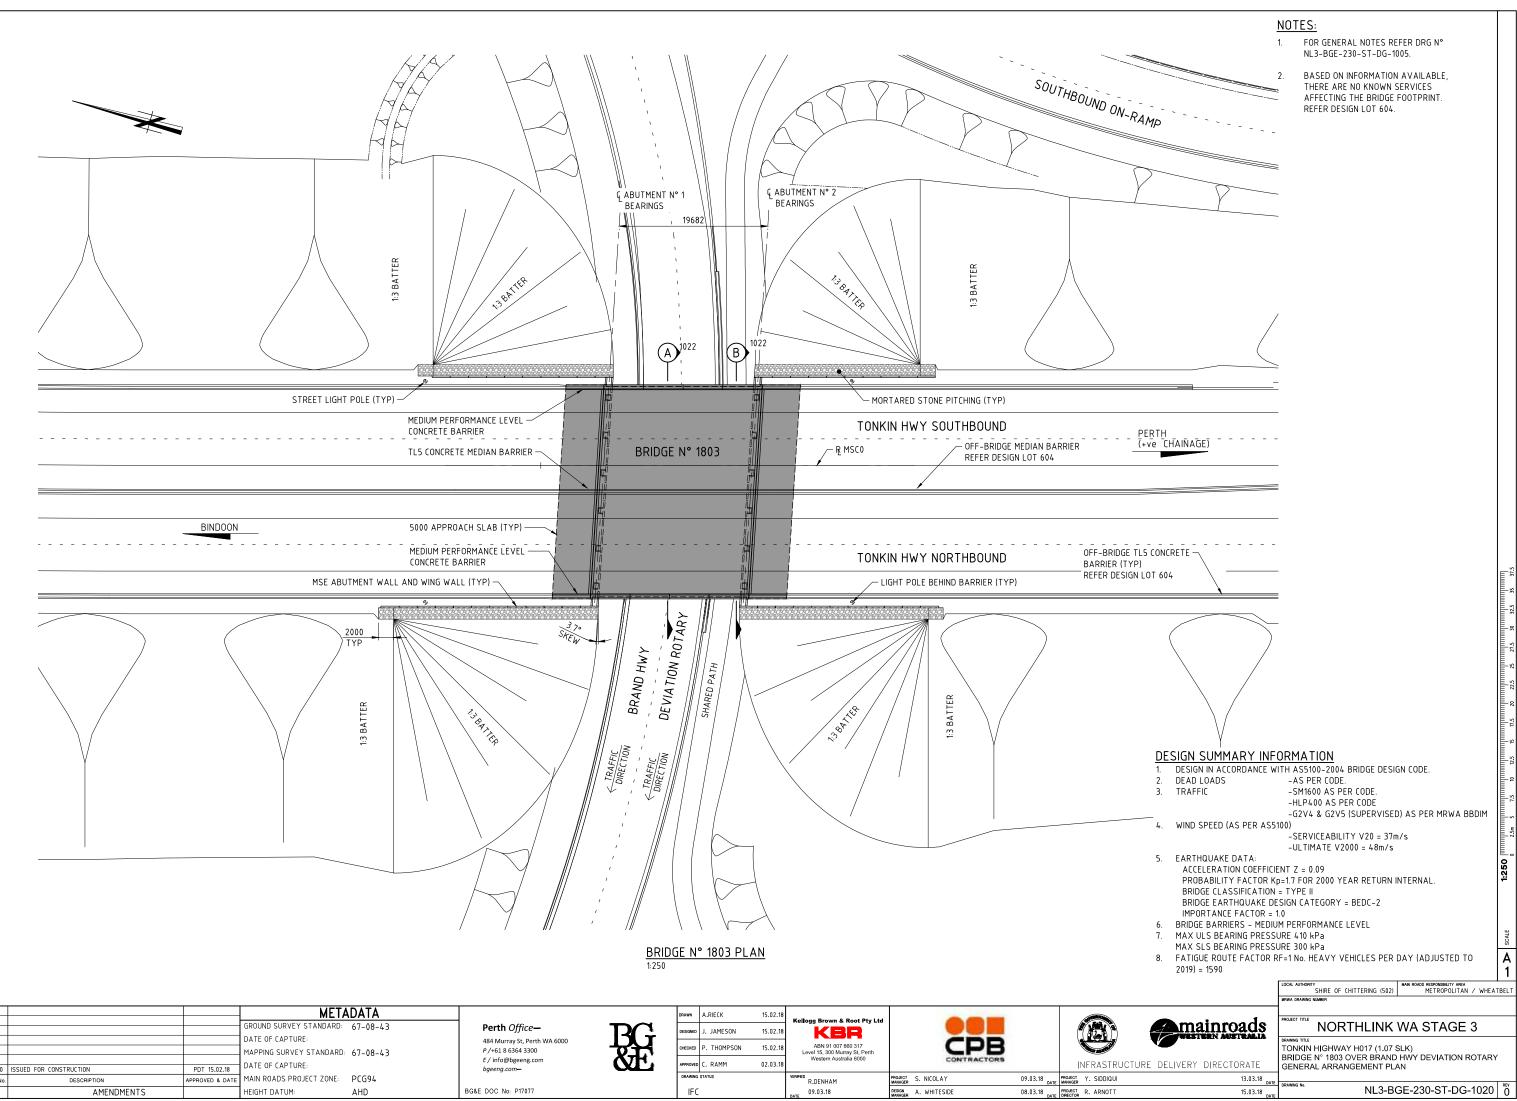
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₹LJ	DESIGNED	J. JAMESON	15.02.18	KBR			
Ē	CHECKED	P. THOMPSON	15.02.18	Level 15, 300 Murray St, Perth	CPB	CPB	
	APPROVED	C. RAMM	02.03.18	Western Australia 6000	CONTRACTORS		INFRASTRUCTU
	DRAWING	STATUS		R. DENHAM	PROJECT S. NICOLAY	09.03.18 DATE	PROJECT Y. SIDDIQUI
	IFC			09.03.18	DESIGN A. WHITESIDE	08.03.18 _{date}	PROJECT R. ARNOTT

A REFERENCE DRAWINGS


LUMINAIRE SUPPORT BRACKET AND COVER PLATE DETAILS




SCALE



BG&E DOC No: P17077

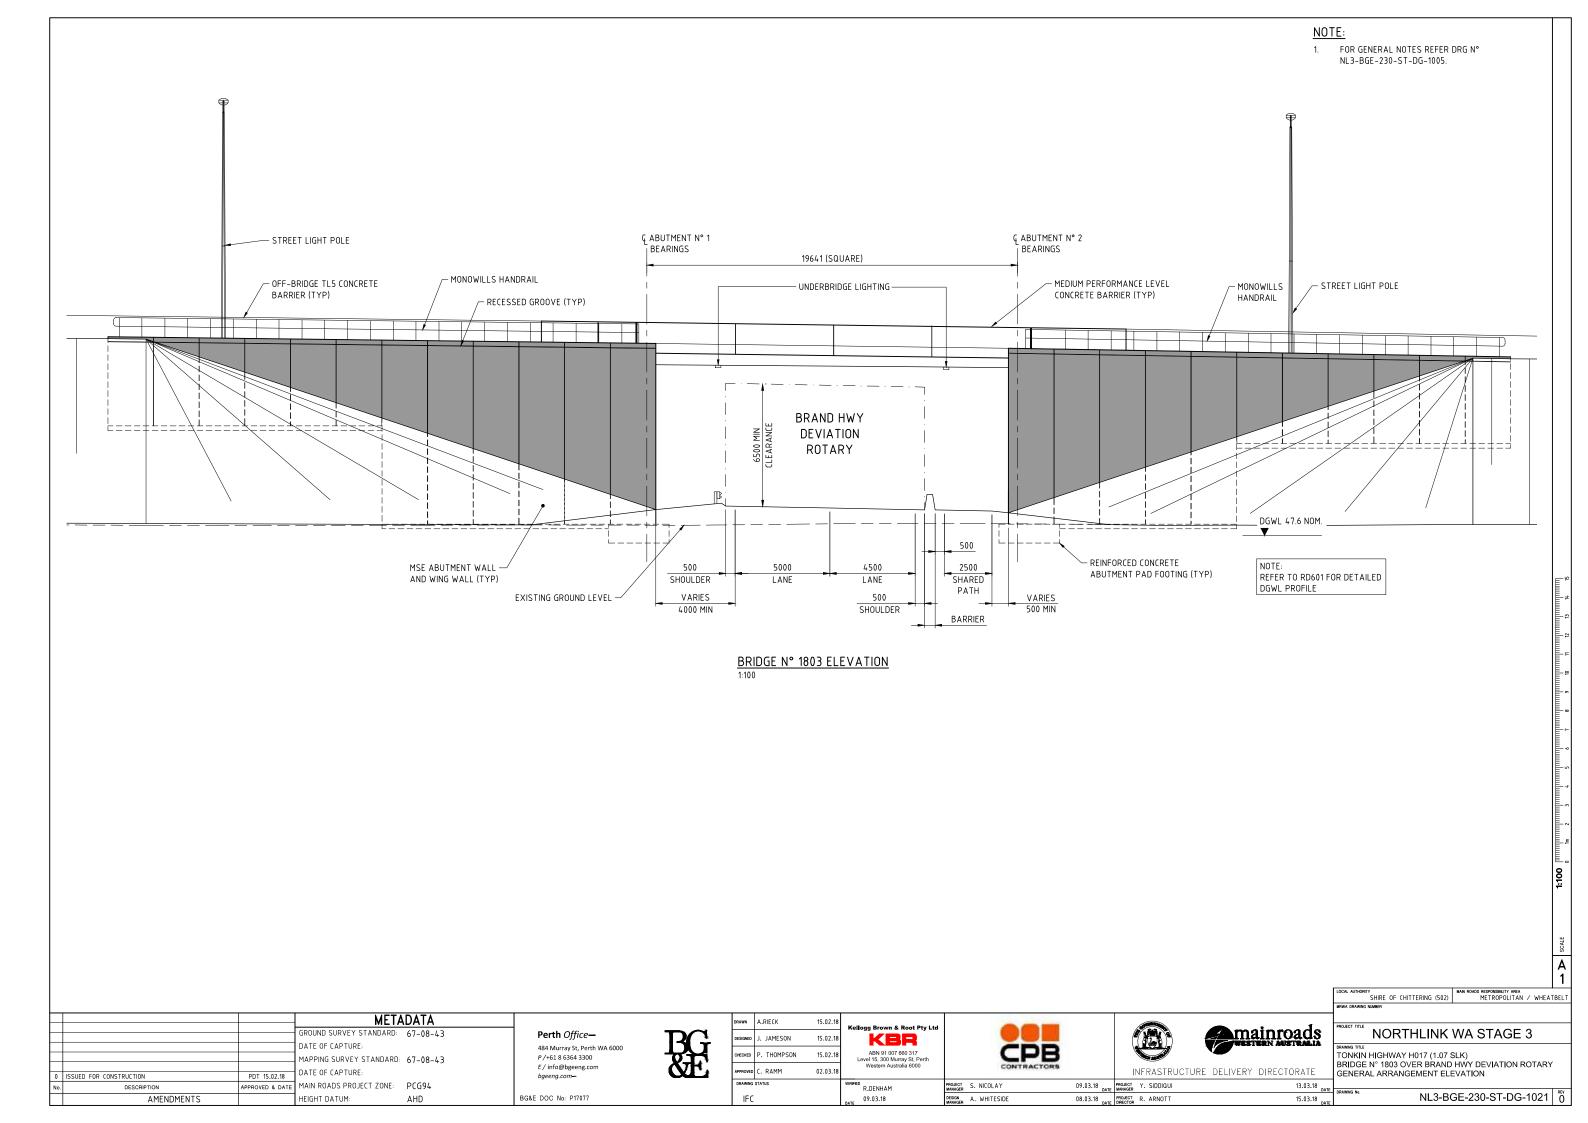

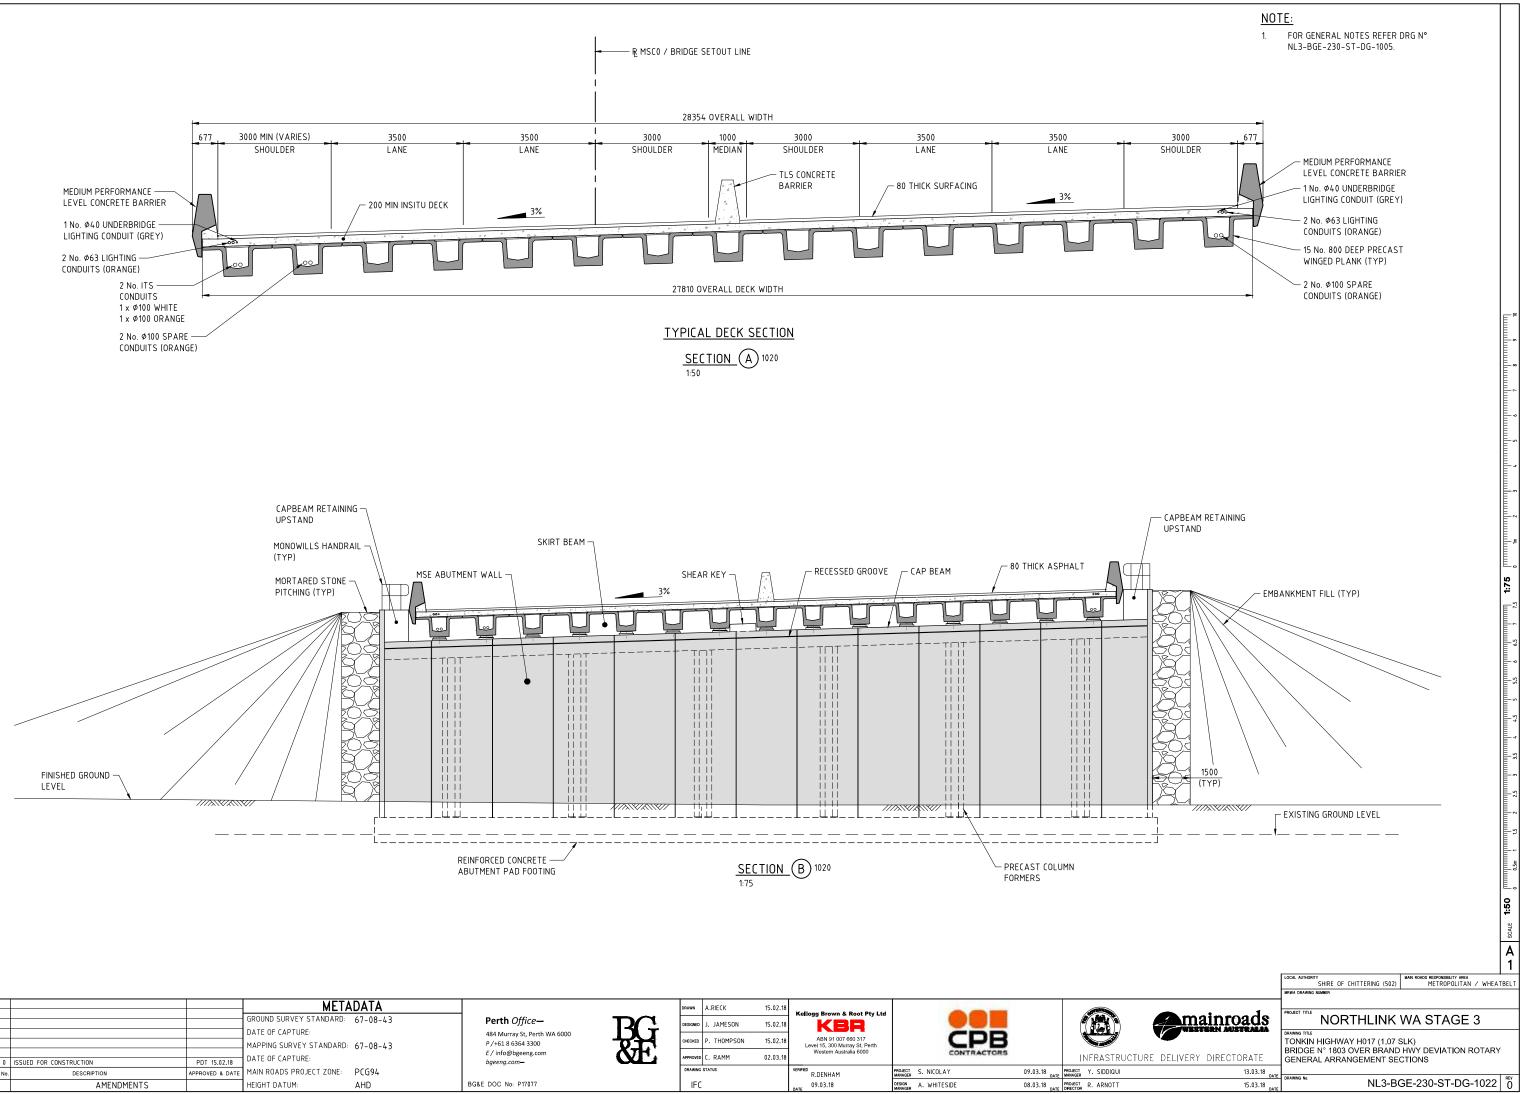

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GENERAL		SUPER-STRUCTURE CONT.		MRWA REF
NL3-BGE-230-ST-DG-2000	COVER SHEET			9230-0921-6
NL3-BGE-230-ST-DG-2001	INDEX SHEET	NL3-BGE-230-ST-DG-2270	PRECAST BEAM REINFORCEMENT ABUTMENT END DIAPHRAGM	
NL3-BGE-230-ST-DG-2005	GENERAL NOTES	NL3-BGE-230-ST-DG-2280	PRECAST BEAM REINFORCEMENT INTERNAL DIAPHRAGM	
NL3-BGE-230-ST-DG-2008	CONSTRUCTION NOTES	NL3-BGE-230-ST-DG-2300	DECK CONCRETE PLAN	
NL3-BGE-230-ST-DG-2010	DESIGN SUMMARY SHEET 1 OF 3			
NL3-BGE-230-ST-DG-2010	DESIGN SUMMART SHEET FUP 3 DESIGN SUMMARY SHEET 2 OF 3	NL3-BGE-230-ST-DG-2305	DECK CONCRETE DETAILS AND ELEVATIONS	
NL3-BGE-230-ST-DG-2012	DESIGN SUMMARY SHEET 2 OF 3			
		NL3-BGE-230-ST-DG-2315	DECK REINFORCEMENT PLAN	
NL3-BGE-230-ST-DG-2020	GENERAL ARRANGEMENT PLAN			
NL3-BGE-230-ST-DG-2021	GENERAL ARRANGEMENT ELEVATION	NL3-BGE-230-ST-DG-2320	DECK REINFORCEMENT ELEVATIONS	
NL3-BGE-230-ST-DG-2022	GENERAL ARRANGEMENT SECTIONS			
NL3-BGE-230-ST-DG-2040	SITE INVESTIGATION INFORMATION SHEET 1 OF 2	NL3-BGE-230-ST-DG-2330	DECK REINFORCEMENT SECTIONS AND DETAILS	
NL3-BGE-230-ST-DG-2041	SITE INVESTIGATION INFORMATION SHEET 1 OF 2			
		NL3-BGE-230-ST-DG-2340	DECK WATERPROOFING PLAN AND DETAILS	
NL3-BGE-230-ST-DG-2050	GEOMETRIC DATA	NL3-BGE-230-ST-DG-2350	APPROACH SLAB CONCRETE PLAN AND SECTIONS	
SUB-STRUCTURE		ME2-DAF-520-21-DA-5220	AFFROACH SLAD CONCRETE FLAN AND SECTIONS	
NL3-BGE-230-ST-DG-2080	ABUTMENT No. 1 MSE WALL PLAN AND ELEVATION	NL3-BGE-230-ST-DG-2355	APPROACH SLAB REINFORCEMENT PLAN AND SECTIONS	
NL3-BGE-230-ST-DG-2081	ABUTMENT No. 2 MSE WALL PLAN AND ELEVATION	NL3-DUE-230-51-DU-2355	APPRUACH SLAD REINFURCEMENT PLAN AND SECTIONS	
NL3-BGE-230-ST-DG-2082	ABUTMENT MSE WALL DETAILS	NL3-BGE-230-ST-DG-2360	EXPANSION JOINT PLAN AND SECTIONS	
		NL3-BGE-230-ST-DG-2361	EXPANSION JOINT PEAN AND SECTIONS	
NL3-BGE-230-ST-DG-2100	ABUTMENT No. 1 FOOTING CONCRETE PLAN AND SECTIONS	NL3-DUE-23V-S1-DU-2301	EXPANSION JOINT DETAILS	
NL3-BGE-230-ST-DG-2105	ABUTMENT No. 2 FOOTING CONCRETE PLAN AND SECTIONS	NL3-BGE-230-ST-DG-2365	COVER PLATE PLAN AND SECTIONS	
		NL3-BGE-230-ST-DG-2366	COVER PLATE DETAILS	
NL3-BGE-230-ST-DG-2110	ABUTMENT No. 1 AND No. 2 FOOTING REINFORCMENT PLAN AND			
NL3-DUE-23V-31-DU-211V	SECTIONS	NL3-BGE-230-ST-DG-2370	BARRIER LAYOUT PLAN AND DETAILS	
NL 3-BGE-230-ST-DG-2115	PRECAST COLUMN FORMER CONCRETE AND REINFORCEMENT			
NL3-BUE-230-31-DU-2115	DETAILS	NL3-BGE-230-ST-DG-2375	BARRIER SECTIONS AND DETAILS	
		NL3-BGE-230-ST-DG-2380	PRECAST PANEL PLANS AND ELEVATIONS SHEET 1	
NL3-BGE-230-ST-DG-2120	PRECAST COLUMN FORMER INFILL CONCRETE AND REINFORCEMENT DETAILS	NL3-BGE-230-ST-DG-2381	PRECAST PANEL PLANS AND ELEVATIONS SHEET 2	
		NL3-BGE-230-ST-DG-2382	PRECAST PANEL PLANS AND ELEVATIONS SHEET 3	
NL3-BGE-230-ST-DG-2125	ABUTMENT No. 1 CAPBEAM CONCRETE PLAN AND ELEVATION	NL3-BGE-230-ST-DG-2385	PRECAST PANEL REINFORCEMENT DETAILS	
NL3-BGE-230-ST-DG-2127	ABUTMENT No. 2 CAPBEAM CONCRETE PLAN AND ELEVATIONS	NL3-BGE-230-ST-DG-2395	INSITU BARRIER STITCH ELEVATION AND DETAILS	
NL3-BGE-230-ST-DG-2128	ABUTMENT No. 1 & 2 CAPBEAM CONCRETE SECTIONS			
		NL3-BGE-230-ST-DG-2400	TRANSITION BARRIER ELEVATION AND DETAILS	
NL3-BGE-230-ST-DG-2130	ABUTMENT CAPBEAM REINFORCMENT ELEVATION AND SECTIONS	NL3-BGE-230-ST-DG-2401	TRANSITION BARRIER REINFORCEMENT DETAILS	
NL3-BGE-230-ST-DG-2190	BEARINGS PLAN AND NOTES			
NL3-BGE-230-ST-DG-2191	BEARINGS SECTIONS AND DETAILS	NL3-BGE-230-ST-DG-2430	SERVICES LAYOUT PLAN	
	BEARINGS SECTIONS AND BETAILS	NL3-BGE-230-ST-DG-2431	SERVICES SECTIONS AND DETAILS	
SUPER-STRUCTURE				
NL3-BGE-230-ST-DG-2200	PRECAST BEAM LAYOUT PLAN AND DETAILS	NL3-BGE-230-ST-DG-2450	UNDER BRIDGE LIGHTING LAYOUT PLAN AND DETAILS	
NL3-BGE-230-ST-DG-2210	PRECAST BEAM CONCRETE PLAN AND ELEVATION			
NL3-BGE-230-ST-DG-2211	PRECAST BEAM CONCRETE PLANS			
NL3-BGE-230-ST-DG-2220	PRECAST BEAM CONCRETE SECTIONS			
NL3-BGE-230-ST-DG-2221	PRECAST BEAM CONCRETE SECTIONS AND DETAILS			
NL3-BGE-230-ST-DG-2230	PRECAST BEAM LIFTING LOCATIONS AND DETAILS			
NL3-BGE-230-ST-DG-2240	PRECAST BEAM PRESTRESS LAYOUT AND NOTES			
NL3-BGE-230-ST-DG-2250	PRECAST BEAM REINFORCEMENT PLAN AND ELEVATION			
NL3-BGE-230-ST-DG-2260	PRECAST BEAM REINFORCEMENT SECTIONS			

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			DATE OF CAPTURE:	
			MAPPING SURVEY STANDARD:	67-08-43
			DATE OF CAPTURE:	
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No.	DESCRIPTION	APPROVED & DATE	MAIN ROADS PROJECT ZONE:	PCG94
	AMENDMENTS		HEIGHT DATUM:	AHD

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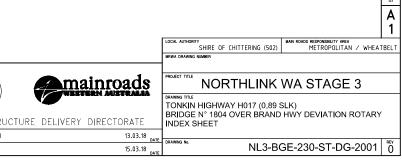
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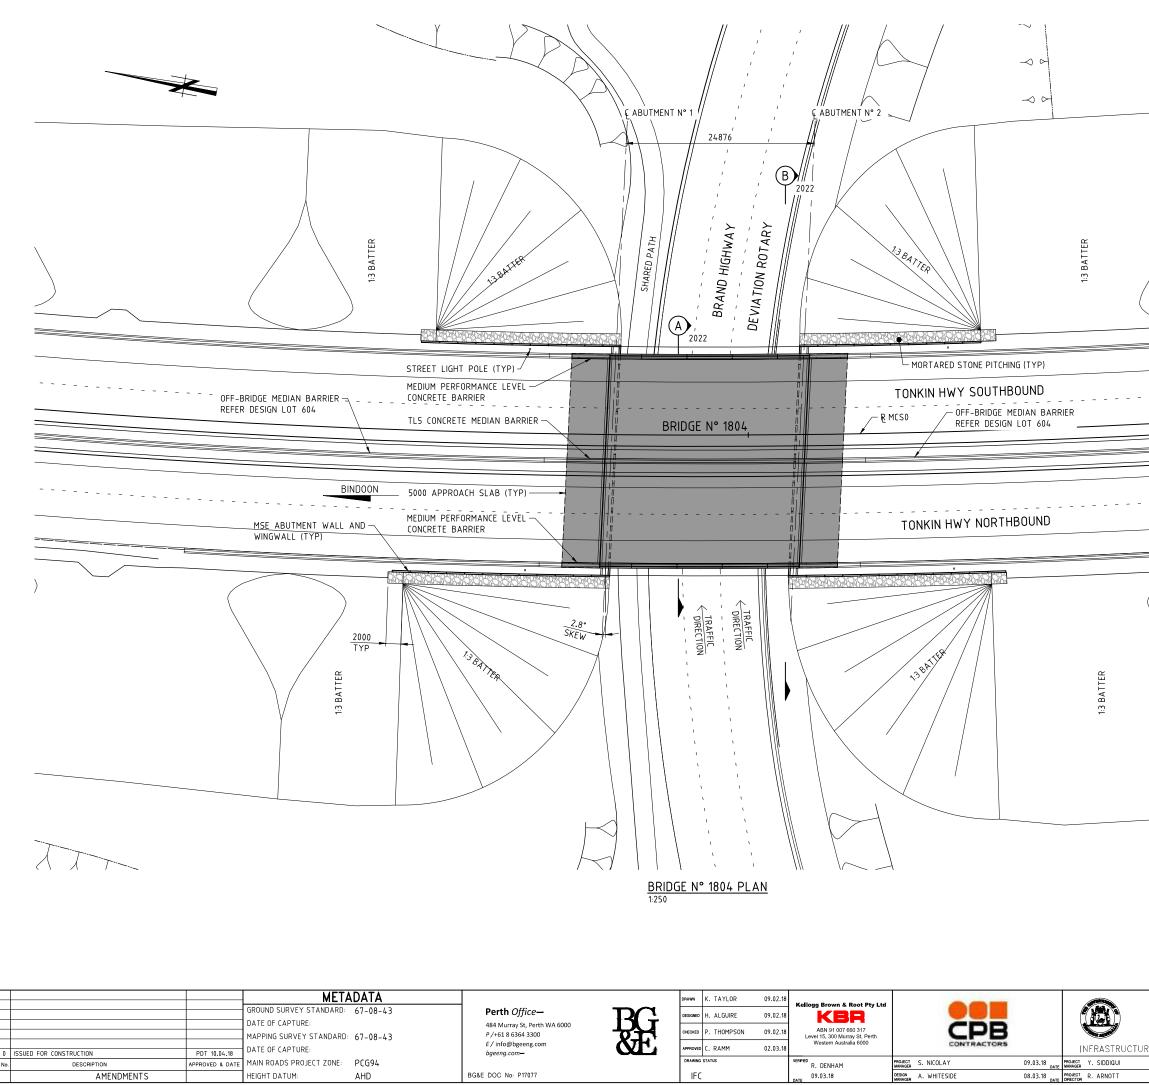
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DESIGNED	H. ALGUIRE	09.02.18	KBR			
CHECKED	P. THOMPSON	09.02.18	ABN 91 007 660 317 Level 15, 300 Murray St, Perth	CPB		
APPROVED	C. RAMM	02.03.18	Western Australia 6000	CONTRACTORS		INFRASTRU
DRAWING	STATUS		R. DENHAM	PROJECT S. NICOLAY	09.03.18 DATE	PROJECT Y. SIDDIQUI
IFC			09.03.18	DESIGN A. WHITESIDE	08.03.18 _{date}	PROJECT R. ARNOTT

EFERENCE DRAWINGS

LUMINAIRE SUPPORT BRACKET AND COVER PLATE DETAILS



SCALE



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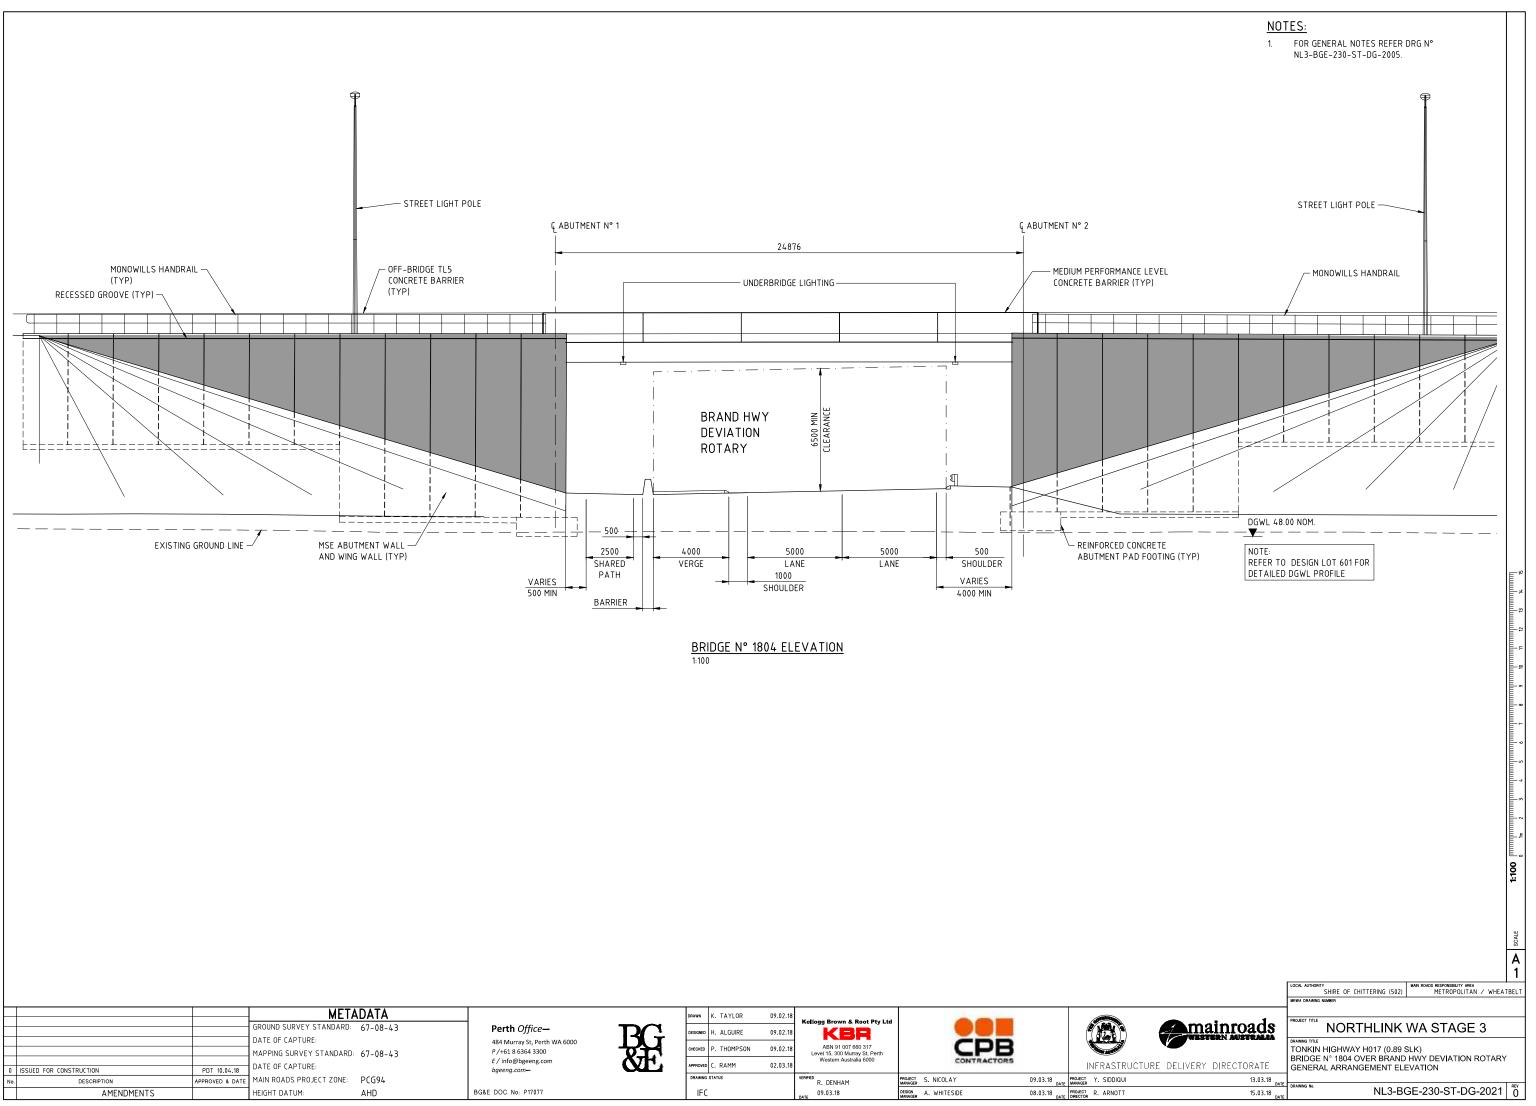
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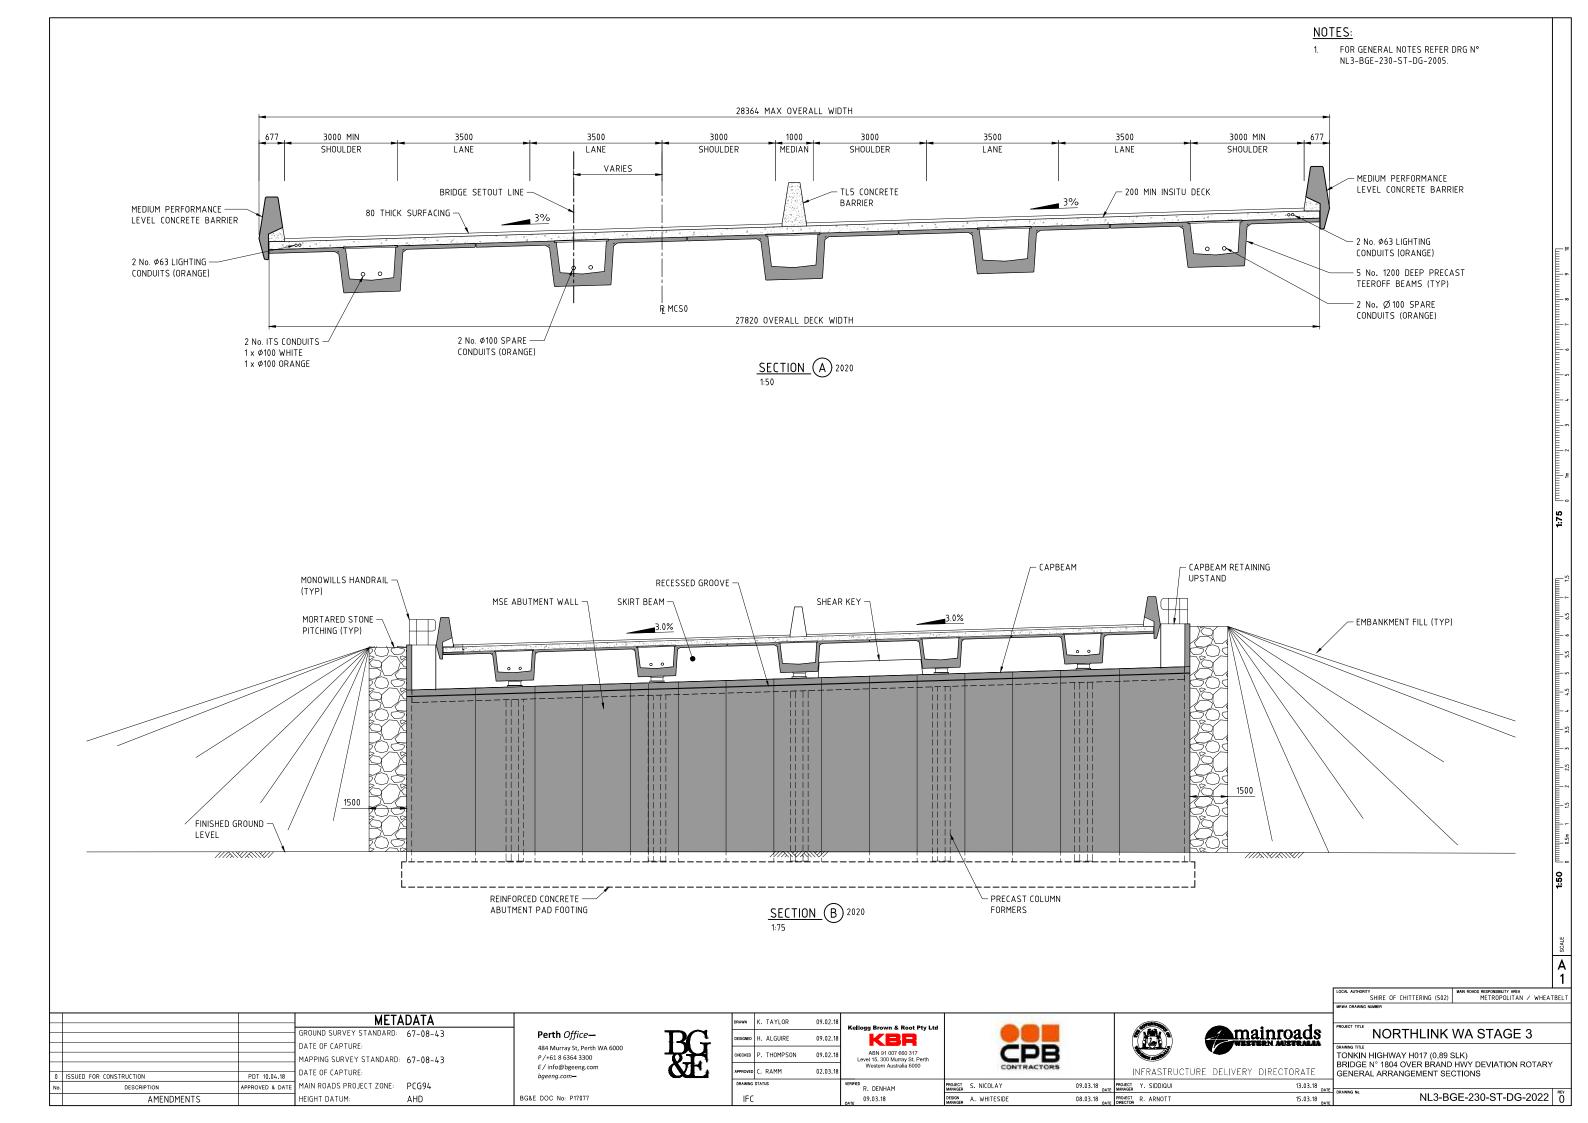
AMENDMENTS

09.03.18

<u>NOT</u> 1. 2.	FOR GENERAL NOTES REFER DRG N° NL3-BGE-230-ST-DG-2005. BASED ON INFORMATION AVAILABLE, THERE ARE NO KNOWN SERVICES AFFECTING THE BRIDGE FOOTPRINT. REFER DESIGN LOT 604.	
_PERTH _(+ve_CHAINĀGĒ)		
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DESIGN SUMMARY INF 1. DESIGN IN ACCORDANCE W 2. DEAD LOADS 3. TRAFFIC 4. WIND SPEED (AS PER ASS	ITH AS5100-2004 BRIDGE DESIGN CODE. -AS PER CODE. -SM1600 AS PER CODE. -HLP400 AS PER CODE -G2V4 & G2V5 (SUPERVISED) AS PER MRWA BBDIM 100) -SERVICEABILITY V20 = 37m/s	minuminuminuminuminuminum 2.5m s 7.5 to 12.5 ts 17
BRIDGE CLASSIFICATION BRIDGE EARTHQUAKE DE IMPORTANCE FACTOR = ' 6. BRIDGE BARRIERS - MEDIU 7. MAX ULS BEARING PRESSI MAX SLS BEARING PRESSI	p=1.7 FOR 2000 YEAR RETURN INTERNAL. = TYPE II ESIGN CATEGORY = BEDC-2 1.0 M PERFORMANCE LEVEL URE 365KPa.	V SCALE 1:250
	LOCAL AUTHORITY SHIRE OF CHITTERING (502) MAN ROADS RESPONSIBILITY AREA METROPOLITAN / WHEA MANA DRAWING NAMBER	
RE DELIVERY DIRECTORATE	DANNE NORTHLINK WA STAGE 3 DANNE THE TONKIN HIGHWAY H017 (0.89 SLK) BRIDGE N° 1804 OVER BRAND HWY DEVIATION ROTAR' GENERAL ARRANGEMENT PLAN	Y
13.03.18 DATE 15.03.18 DATE	DRAWING No. NL3-BGE-230-ST-DG-2020	REV



			MET	ADATA			DRAWN K. TAYLOR	09.02.18	Kellogg Brown & Root Pty Ltd			
-			GROUND SURVEY STANDARD:	67-08-43	Perth Office—	DC	DESIGNED H. ALGUIRE	09.02.18				
			DATE OF CAPTURE:		484 Murray St, Perth WA 6000	DU	CHECKED P. THOMPSON	09.02.18	ABN 91 007 660 317	CDR		
_			MAPPING SURVEY STANDARD	67-08-43	P /+61 8 6364 3300 E / info@bgeeng.com	&E			Level 15, 300 Murray St, Perth Western Australia 6000	CONTRACTORS		
(0 ISSUED FOR CONSTRUCTION	PDT 10.04.18	DATE OF CAPTURE:		bgeeng.com-		APPROVED C. RAMM	02.03.18				INFRASTRUCTURE
N	No. DESCRIPTION	APPROVED & DATE	MAIN ROADS PROJECT ZONE:	PCG94			DRAWING STATUS		R. DENHAM	PROJECT S. NICOLAY	09.03.18 DATE	PROJECT Y. SIDDIQUI
	AMENDMENTS		HEIGHT DATUM:	AHD	BG&E DOC No: P17077		IFC		09.03.18 DATE	DESIGN A. WHITESIDE	08.03.18 DATE	PROJECT R. ARNOTT DIRECTOR




APPENDIX B

Non-Compliances

Northlink Infrastructure Report - Clearance Footprint Outside the Development Envelope Map 1 of 6




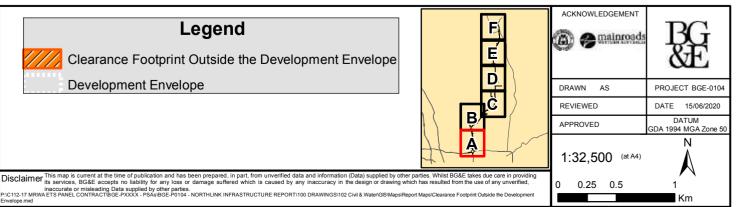

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Northlink Infrastructure Report - Clearance Footprint Outside the Development Envelope Map 2 of 6



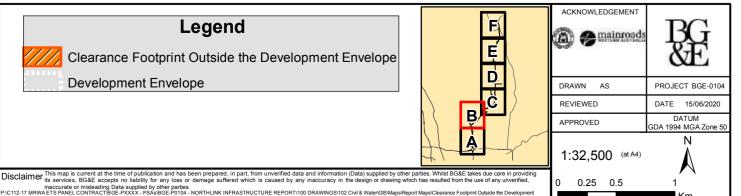


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Northlink Infrastructure Report - Clearance Footprint Outside the Development Envelope Map 3 of 6






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Northlink Infrastructure Report - Clearance Footprint Outside the Development Envelope Map 4 of 6

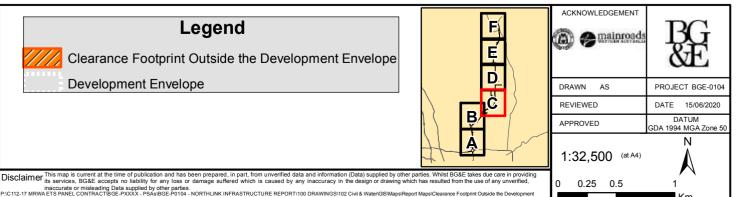

Clearance Footprint Outside the Development Envelope


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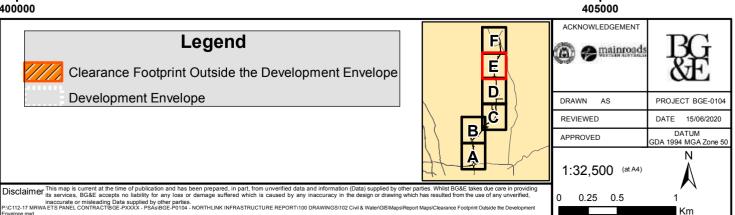


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REVIEWED	DATE 15/06/2020				
APPROVED	DATUM GDA 1994 MGA Zone 50				
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Northlink Infrastructure Report - Clearance Footprint Outside the Development Envelope Map 5 of 6

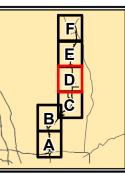




Northlink Infrastructure Report - Clearance Footprint Outside the Development Envelope Map 6 of 6

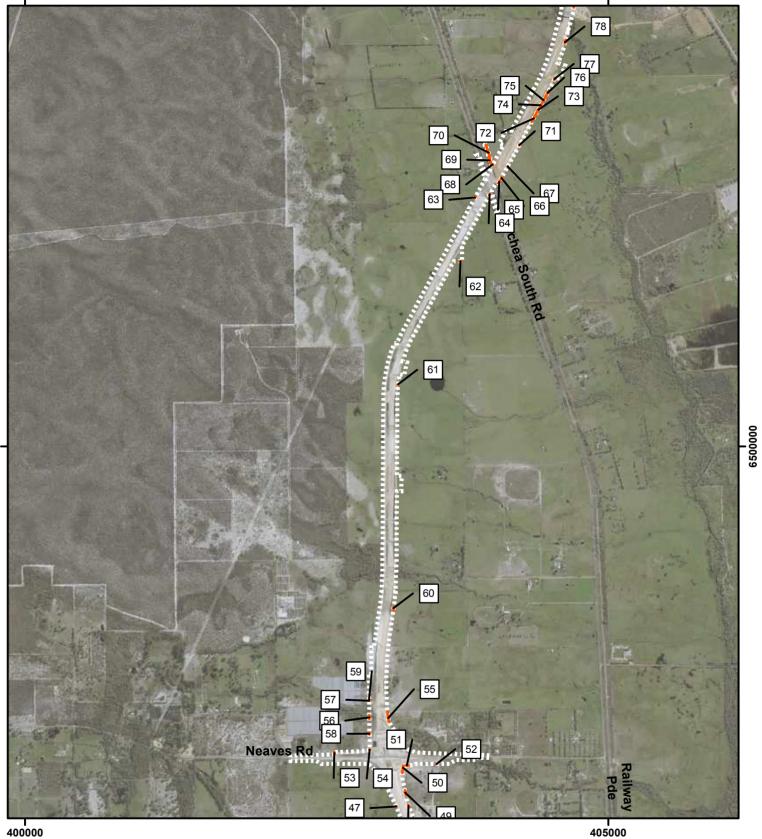



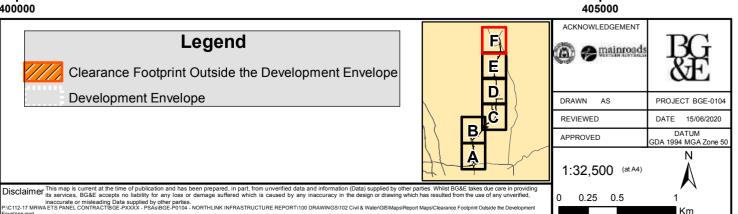

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APPENDIX C

DWER Response



Government of Western Australia Department of Water and Environmental Regulation

> Our ref: DWERA-000257 Enquiries: Rowan Inglis, Ph 6364 6472

Mr John Braid Principal Environment Officer Main Roads Western Australia Waterloo Crescent East Perth WA 6004

Dear Mr Braid

MINISTERIAL STATEMENT 1036 PERTH – DARWIN NATIONAL HIGHWAY (SWAN VALLEY SECTION) CONDITION 1-1 NOTIFICATION OF OPERATIONS OUTSIDE OF DEVELOPMENT ENVELOPE

I refer to your email dated 15 June 2020 in which Main Roads Western Australia notified the Department of Water and Environmental Regulation (the department) that operations relating to the construction and operation of the Perth-Darwin National Highway have exceeded the development envelope defined as Figure 1 (as approved on 7 June 2017) of Ministerial Statement 1036.

The department notes the following, of the 94 instances where the development envelope was exceeded:

- 1. 90 are considered minor and to be due to errors in the accuracy of the spatial data; and
- 2. The remaining four instances relate to road works on existing infrastructure where no clearing of native vegetation occurred.

The department has determined that due to the nature of the exceedances of the development envelope no enforcement action will be taken in relation to this matter.

Please contact Rowan Inglis on 6364 6472 or <u>rowan.inglis@dwer.wa.gov.au</u> if you require any additional information relating to this matter.

Yours sincerely

Ms Clare Grosser Senior Manager Compliance and Enforcement 07 / 07 / 2020